File Number Related File Number Pre-consultation Meeting Application Submitted Complete Application	N/A N/A N/A October 19, 2021 January 31, 2022	Application Fee Conservation Authority Fee Well & Septic Info Provided Planner Public Notice Sign	1560.00 - paid N/A N/A Hanne Yager -		
Check the type of plan	ning application(	s) you are submitting.			
Consent/Severance/Boundary Adjustment Surplus Farm Dwelling Severance and Zoning By-law Amendment Minor Variance Easement/Right-of-Way  Property Assessment Roll Number: 331049502030500000					
A. Applicant Informati					
Name of Owner Brian Albrecht			····		
It is the responsibility of ownership within 30 day	• •	cant to notify the planner of e.	any changes in		
Address	293 Townline Street	·			
Town and Postal Code	St. Williams N0E 1P0				
Phone Number	519-591-6486				
Cell Number					
Email	brianalbrecht@rogers.com				
Name of Applicant Tabatha Atkinson - CDN Buildings					
Address	523 James Street				
Town and Postal Code	Delhi N4S 2Z2				
Phone Number	519-582-8222				
Cell Number	519-429-1533				

ta@cdnbuildings.com



Email

For Office Use Only:

Name of Agent	Tabatha Atkinso	n - CDN Buildings		
Address	523 James Stree	et		
Town and Postal Code	Delhi N4S 2Z2			
Phone Number	519-582-8222 519-429-1533 ta@cdnbuildings.com			
Cell Number				
Email				
•		hould be sent. Unless otherwise directed, this application will be forwarded to the		
Owner	Agent	<ul><li>Applicant</li></ul>		
Legal Description (inc Block Number and U	rban Area or Hamlet)	wnship, Concession Number, Lot Number,		
Municipal Civic Addre	ess: 293 Townline	St, St. Williams, ON N0E 1P0		
Present Official Plan	Designation(s):	<del></del>		
Present Zoning: CR	- Commerical Rura	al 		
2. Is there a special pro  Yes No If yes	-	zone on the subject lands?		
3. Present use of the su	bject lands:			




4.	Please describe all existing buildings or structures on the subject lands and
	whether they are to be retained, demolished or removed. If retaining the buildings or
	structures, please describe the type of buildings or structures, and illustrate the
	setback, in metric units, from front, rear and side lot lines, ground floor area, gross
	floor area, lot coverage, number of storeys, width, length, and height on your
	attached sketch which must be included with your application:
	1 30x40x16' Steel accessory building

5.	If an addition to an existing building is being proposed, please explain what it will be
	used for (for example a bedroom, kitchen, or bathroom). If new fixtures are
	proposed, please describe.
	N/A

- 6. Please describe all proposed buildings or structures/additions on the subject lands. Describe the type of buildings or structures/additions, and illustrate the setback, in metric units, from front, rear and side lot lines, ground floor area, gross floor area, lot coverage, number of storeys, width, length, and height on your attached sketch which must be included with your application:
  Please see site plan
- 7. Are any existing buildings on the subject lands designated under the *Ontario*Heritage Act as being architecturally and/or historically significant? Yes No

  If yes, identify and provide details of the building:
- 8. If known, the length of time the existing uses have continued on the subject lands: Residential
- Existing use of abutting properties:
   Residental
- 10. Are there any easements or restrictive covenants affecting the subject lands?

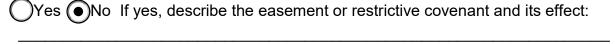



#### C. Purpose of Development Application

Note: Please complete all that apply.

Note: Please comple	ete ali that ap	pıy.	
1. Site Information	1	Existing	Proposed
Please indicate unit	of measurem	ent, for example: n	ո, m² or %
Lot frontage		205'-0"	205'-0"
Lot depth		408'-11/16"	408'- 11 11/16"
Lot width		261'-5 5/8"	261'-5 5/8"
Lot area		97923SF	97923SF
Lot coverage		4%	5%
Front yard		39'-8 1/2"	39'-8 1/2"
Rear yard		30'-11 1/4"	30'-11 1/4"
Left Interior side yard	d	39'-8 1/2"	63'-2 9/16"
Right Interior side ya		0'-0"	0'-0"
Exterior side yard (co		0'-0"	0'-0"
By-law: Home owner is p	:: 6.6M  thy it is not pooroposing 30x oroposing from	x40x16 steel acces	ith the provision(s) of the Zoning sory building to store vehicles and to be proposed as accessory to the
<b>4.</b> Description of lar Frontage:	N/A	be severed in me	tric units:
Depth:	N/A		
Width:	N/A	· · · · · · · · · · · · · · · · · · ·	
Lot Area:	N/A		
Present Use:	N/A		
Proposed Use:	N/A		
•	t size (if boun	ndary adjustment):	N/A



•	n of land intended to be retained in metric units:  N/A
Frontage:	N/A
Depth:	N/A
Width:	N/A
Lot Area: Present Us	NI/Λ
Proposed I	NI/Λ
•	on retained land: N/A
. Description	of proposed right-of-way/easement in metric units:
. Descriptior Frontage:	n of proposed right-of-way/easement in metric units:
•	
Frontage:	N/A
Frontage: Depth:	N/A N/A
Frontage: Depth: Width:	N/A N/A N/A
Frontage: Depth: Width: Area:	N/A N/A N/A
Frontage: Depth: Width: Area: Proposed U	N/A  N/A  N/A  N/A  N/A  N/A  N/A  N/A
Frontage: Depth: Width: Area: Proposed U	N/A N/A N/A N/A N/A N/A N/A N/A N/A
Frontage: Depth: Width: Area: Proposed I	N/A  N/A  N/A  N/A  N/A  N/A  N/A  Oerties in Norfolk County, which are owned and farmed by the applicant and in the farm operation:
Frontage: Depth: Width: Area: Proposed I List all propand involve	N/A  N/A  N/A  N/A  N/A  N/A  N/A  Oerties in Norfolk County, which are owned and farmed by the applicant and in the farm operation:
Frontage: Depth: Width: Area: Proposed I List all propand involve Owners Name	N/A  N/A  N/A  N/A  N/A  N/A  N/A  Derties in Norfolk County, which are owned and farmed by the applicant ed in the farm operation:  N/A  331049502030500000
Frontage: Depth: Width: Area: Proposed I List all propand involve	N/A  N/A  N/A  N/A  N/A  N/A  N/A  N/A



Οv	vners Name:	Brian Albrecht
Ro	oll Number:	331049502030500000
То	tal Acreage:	2.24
W	orkable Acreage:	2.24
Ex	isting Farm Type:	(for example: corn, orchard, livestock) No
		Yes No If yes, year dwelling built
Ov	vners Name:	
Ro	ll Number:	
То	tal Acreage:	
W	orkable Acreage:	
Ex	isting Farm Type:	(for example: corn, orchard, livestock)
Dν	velling Present?:	Yes No If yes, year dwelling built
Ov	vners Name:	
Ro	ll Number:	
То	tal Acreage:	
W	orkable Acreage:	
Ex	isting Farm Type:	(for example: corn, orchard, livestock)
Dv	velling Present?:	Yes No If yes, year dwelling built
Nc	te: If additional	space is needed please attach a separate sheet.
D.	Previous Use of	the Property
1.		an industrial or commercial use on the subject lands or adjacent  No   Unknown
	If yes, specify the	e uses (for example: gas station, or petroleum storage):
2.		o believe the subject lands may have been contaminated by former or adjacent sites? Yes No Unknown
3.	Provide the informanswers unknown	mation you used to determine the answers to the above questions:



4.	If you answered yes to any of the above questions in Section D, a previous use inventory showing all known former uses of the subject lands, or if appropriate, the adjacent lands, is needed. Is the previous use inventory attached? Yes No
Ε.	Provincial Policy
1.	Is the requested amendment consistent with the provincial policy statements issued under subsection 3(1) of the <i>Planning Act, R.S.O. 1990, c. P. 13</i> ? • Yes No
	If no, please explain:
	USABLE FLOOR AREA EXCEEDS MAXIMUM USABLE AREA LIMIT FROM NORFOLK COUNTY'S ZONING BYLAW FR LOTS ZONED AS CR. OVERALL HEIGHT EXCEEDS LIMIT FROM NORFOLK COUNTY BYLAW
2.	It is owner's responsibility to be aware of and comply with all relevant federal or provincial legislation, municipal by-laws or other agency approvals, including the Endangered Species Act, 2007. Have the subject lands been screened to ensure that development or site alteration will not have any impact on the habitat for endangered or threatened species further to the provincial policy statement subsection 2.1.7? Yes No
	If no, please explain:
	THE PROPOSED AREA FOR THE ADDITION IS IN AN AREA WITH UNDISTURBED SOIL WITH NO LANDSCAPING (TREES, BUSHES ETC.) TREES ARE VERY FAR AWAY
3.	Have the subject lands been screened to ensure that development or site alteration will not have any impact on source water protection? Yes No
	If no, please explain: THERE IS A POND APPROX 160' FROM THE PROPOSED BUILDING LOCATION
	Note: If in an area of source water Wellhead Protection Area (WHPA) A, B or C please attach relevant information and approved mitigation measures from the Risk Manager Official.



١.	Are any of the following uses or features on the subject lands or within 500 metres of the subject lands, unless otherwise specified? Please check boxes, if applicable.
	Livestock facility or stockyard (submit MDS Calculation with application)
	On the subject lands orwithin 500 meters – distance
	Wooded area  ✓ On the subject lands or within 500 meters – distance 301' 11 1/16"
	Municipal Landfill On the subject lands or within 500 meters – distance
	Sewage treatment plant or waste stabilization plant  On the subject lands or within 500 meters – distance
	Provincially significant wetland (class 1, 2 or 3) or other environmental feature  On the subject lands or within 500 meters – distance
	Floodplain On the subject lands or within 500 meters – distance
	Rehabilitated mine site On the subject lands or within 500 meters – distance
	Non-operating mine site within one kilometre On the subject lands or within 500 meters – distance
	Active mine site within one kilometre  On the subject lands or within 500 meters – distance
	Industrial or commercial use (specify the use(s))  On the subject lands or within 500 meters – distance
	Active railway line On the subject lands or within 500 meters – distance
	Seasonal wetness of lands On the subject lands or within 500 meters – distance
	Erosion On the subject lands or within 500 meters – distance
	Abandoned gas wells On the subject lands or within 500 meters – distance



F.	Servicing and Access	
1.	Indicate what services are available or proposed:	
	Water Supply	
	Municipal piped water	Communal wells
	Individual wells	Other (describe below)
	Sewage Treatment	
	Municipal sewers	Communal system
	Septic tank and tile bed in good working order	Other (describe below)
	Storm Drainage	
	Storm sewers	<ul><li>Open ditches</li></ul>
	Other (describe below)	
2.	Existing or proposed access to subject lands	
	Municipal road	Provincial highway
	Unopened road  Name of road/street:	Other (describe below)
G.	Other Information	
1. Does the application involve a local business? OYes No		)Yes  No
	If yes, how many people are employed on the sub	eject lands?
2	ls there any other information that you think may be	ne useful in the review of this

2. Is there any other information that you think may be useful in the review of this application? If so, explain below or attach on a separate page.

Home owner is proposing a 30'-0"W x 40'-0"L x 16'H Steel accessory building Max. usable floor area for accessory buildings in Zoning ByLaw for CR zoned lots is 100sqm. They're also proposing overall height of 21'6" and Bylaw for CR zoned lots is 19'8".



#### H. Supporting Material to be submitted by Applicant

In order for your application to be considered complete, folded hard copies (number of paper copies as directed by the planner) and an **electronic version (PDF) of the site plan drawings, additional plans, studies and reports** will be required, including but not limited to the following details:

- 1. Concept/Layout Plan
- 2. All measurements in metric
- 3. Existing and proposed easements and right of ways
- Parking space totals required and proposed
- 5. All dimensions of the subject lands
- 6. Dimensions and setbacks of all buildings and structures
- 7. Location and setbacks of septic system and well from all existing and proposed lot lines, and all existing and proposed structures
- 8. Names of adjacent streets
- 9. Natural features, watercourses and trees

In addition, the following additional plans, studies and reports, including but not limited to, may also be required as part of the complete application submission:

Zoning Deficiency Form

On-Site Sewage Disposal System Evaluation Form (to verify location and condition)

Environmental Impact Study

Geotechnical Study / Hydrogeological Review

Minimum Distance Separation Schedule

Record of Site Condition

Agricultural Impact Assessment

Your development approval might also be dependent on Ministry of Environment Conservation and Parks, Ministry of Transportation or other relevant federal or provincial legislation, municipal by-laws or other agency approvals.

All final plans must include the owner's signature as well as the engineer's signature and seal.



#### I. Transfers, Easements and Postponement of Interest

The owner acknowledges and agrees that if required it is their solicitor's responsibility on behalf of the owner for the registration of all transfer(s) of land to the County, and/or transfer(s) of easement in favour of the County and/or utilities. Also, the owner further acknowledges and agrees that it is their solicitor's responsibility on behalf of the owner for the registration of postponements of any charges in favour of the County.

#### **Permission to Enter Subject Lands**

Permission is hereby granted to Norfolk County officers, employees or agents, to enter the premises subject to this application for the purposes of making inspections associated with this application, during normal and reasonable working hours.

For the purposes of the Municipal Freedom of Information and Protection of Privacy Act,

#### Freedom of Information

I authorize and consent to the use by or the disclosinformation that is called to	sure to any person or public body any
information that is collected under the authority of	the Planning Act, R.S.O. 1990, c. P.
13 for the purposes of processing this application.	Oct 14/21.
Owner/Applicant/Agent Signature	Date
J. Owner's Authorization	
If the applicant/agent is not the registered owner of application, the owner must complete the authorize	ation set out below
INVe Brian & Mary Pilbree Lam lands that is the subject of this application.	/are the registered owner(s) of the
I/We authorize Rright Many Albred myour behalf and to provide any of myour person	to make this application on
my/our behalf and to provide any of my/our person processing of this application. Moreover, this sha	hal information necessary for the
authorization for so doing.	ii be your good and sufficient
n un	Oct 14/21.
1	



Owner

Revised April 2019 Committee of Adjustment Development Application Page 11 of 12

Date

K. Declaration		
Ι,	_of	
solemnly declare that:		
all of the above statements and the statements contained in all of the exhibits transmitted herewith are true and I make this solemn declaration conscientiously believing it to be true and knowing that it is of the same force and effect as if made under oath and by virtue of <i>The Canada Evidence Act</i> .		
Declared before me at:		
In	Owner/Applicant/Agent Signature	
Thisday of		
A.D., 20		
A Commissioner, etc.		





523 James St. Unit # 3 Delhi, ON N4B 2C2 Ph: 519-582-8222 Fax: 519-582-2098 www.cdnbuildings.com

OWNERS AUTHORIZATION;
ADDRESS: 293 Townline Street St. William's, ont
St. William's, ont
NOE-1PO
I/We, Brian Albrech , the owner(s) of the above mentioned
property/address that is subject to this application, do herby authorize and appoint CDN Buildings
as my/our Agent to make this application on my/our behalf and to conduct all communications on my/our behalf respecting the same.
my/our bendin respecting the same.
OWNER'S SIGNATURE; Men
OWNER'S SIGNATURE;
OWNER'S NAME (Please Print): Brian Albrecht
DATE: July 6, 2021

Please note: We will require a variance to keep an existing block building which is 20 x 24. if we don't have a choice we will take it down.

## ALBRECHT, BRIAN

ADDRESS:

293 TOWNLINE ST,

ST WILLIAMS, ON

N0E 1P0

CONTACT: PHONE:

**BRIAN ALBRECHT** 

**EMAIL:** 

(519) 591-6486 BRIANALBRECHT@ROGERS.COM

## 30'-0"W x 40'-0"L x 16'-0"H (4/12 PITCH) **CLEAR SPAN STEEL ACCESSORY BUILDING**





523 James St. Delhi, ON N4B 2C2

Office: (519) 582-8222 Fax: (519) 582-2098

Website: www.cdnbuildings.com

#### COLOURS:

WALLS: CHARCOAL QC 8317 **ROOF: WHITE WHITE QC 8317** TRIM: WHITE WHITE QC 8317 DOORS: WHITE WHITE QC 8317 WINDOWS: WHITE WHITE QC 8317

#### **INDEX OF DRAWINGS**

Sheet#	Sheet Name
01	Site Plan
A0	Isometric Models
A1	Floor Plan
A2	Section 'A'
A3	Elevations - East
A4	Elevations - West
A5	Elevations - South
A6	Elevations - North
S0	Structural Model
S1	Foundation Plan
S2	Foundation Details
S3	Post Plan
S4	Structural Elevations - East
S5	Structural Elevations - West
S6	Structural Elevations - South
S7	Structural Elevations - North
S8	Truss & Bracing Location
S9	Truss Detail
S10	Typical Truss Weld Details 1
S11	Typical Truss Weld Details 2
S12	Typical Truss Weld Details 3
S13	Post Bracing Detail
S14	Roof Bracing Detail
S15	Connection Details
S16	Eaves/Wall Details
S17	Material Specification
SN1	Structural Notes 1
SN2	Structural Notes 2



#### **PROJECT NUMBER:**

ACCORDANCE WITH THE 2020 ONTARIO BUILDING CODE AND ALL UP TO = 1.3 kPa (DEAD LOAD = 0.4 kPa) = 0.4 kPa

= 0.4 kPa = 0.8 = 0.92 = 0.9 = 1.22 kPa / 25.6 psf




LOT INFO

SITE ADDRESS:

293 TOWNLINE ST. ST. WILLIAMS ON NOE 1P0

TOWNSHIP/CITY: ZONING: ROLL #: BUILDING USE: NORFOLK COUNTY CR (RURAL COMMERCIAL ZONE) 3310495020305000000 ACCESSORY BUILDING

PROVISIONS		PROPOSED
FRONT YARD SETBACK	NOT PERMITED	12M
REAR YARD SETBACK	1.2M	100.4M
MINIMUM INTERIOR SIDE YARD SETBACK	1.2M	19.5M
MINIMUM EXTERIOR SIDE YARD SETBACK	NOT PERMITED	М
MINIMUM CORNER SIDE YARD SETBACK	N/A	M
MAXIMUM HEIGHT	6M	6.6M
LOT SF = 9792 EXISTING RESIDENCE = 1826 EXISTING ACCESSORY BUILDINGS = 2080 PROPOSED BUILDINGS = 1200	SF SF	
MAXIMUM COVERAGE	10%	5.2%

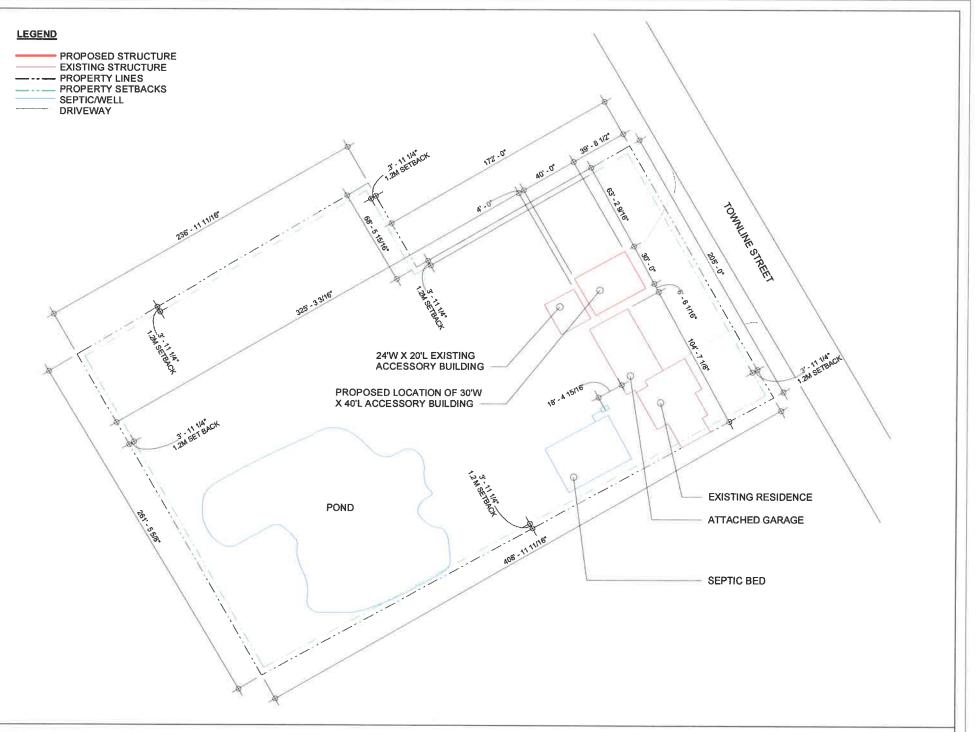



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Website: www.cdnbuildings.com

No.	Description	Date
1	Presentation Pkg for Review	21/08/19
2	Structural Drg Pkg for Review	21/09/07
3	Issued for Review/Permit	-
4	As Built Drawings	-

Site Plan

ALBRECHT, BRIAN

293 TOWNLINE ST. ST WILLIAMS ON NOE 1P0



 D1


 Project number
 21-706


 Date
 2021/09/07

 Drawn by
 JK

 Checked by
 LDO

 Scale
 1" = 60'-0"

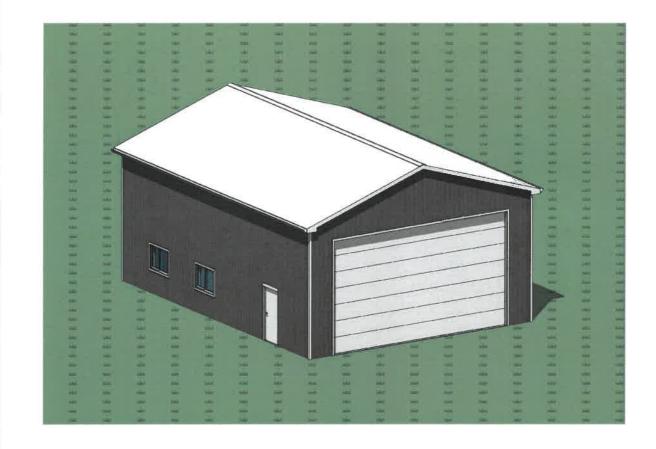

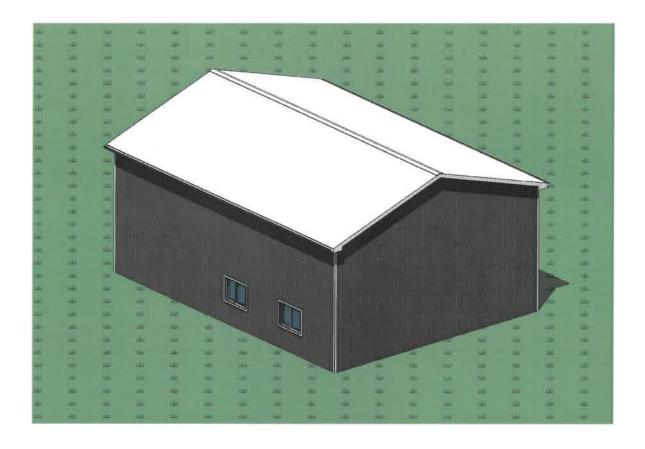

1 A0

Front View

2 A0

Rear View

# CDNBUILDINGS

523 James St. Delhi, ON N4B 2C2 Office: (519) 582-8222 Fax: (519) 582-2098

Website: www.cdnbuildings.com

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1	Presentation Pkg for Review	21/08/19
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3	Issued for Review/Permit	-
4	As Built Drawings	-


#### Isometric Models

## ALBRECHT, BRIAN



A0	
Project number	21-706
Date	2021/09/07
Drawn by	JK
Checked by	LDO
Scale	



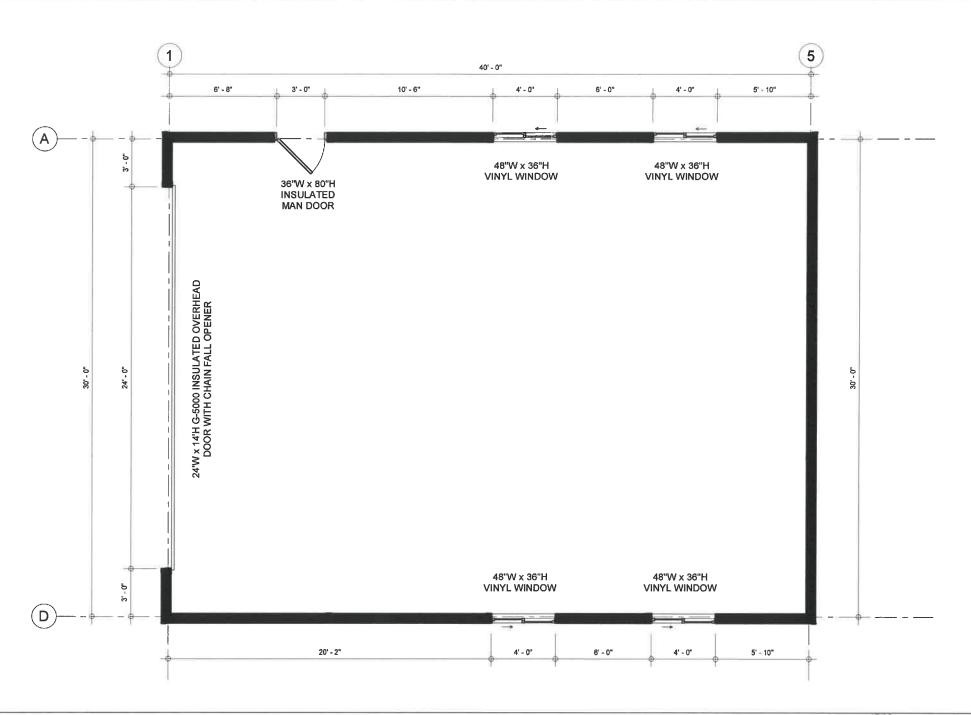



Office: (519) 582-8222 Fax: (519) 582-2098

Website: www.cdnbuildings.com


No.	Description	Date
1	Presentation Pkg for Review	21/08/19
2	Structural Drg Pkg for Review	21/09/07
3	Issued for Review/Permit	-
4	As Built Drawings	-

#### Floor Plan

## ALBRECHT, BRIAN



A1		
Project number	21-706	
Date	2021/09/07	
Drawn by	JK	
Checked by	LDO	
Scale	3/16" = 1'-0"	

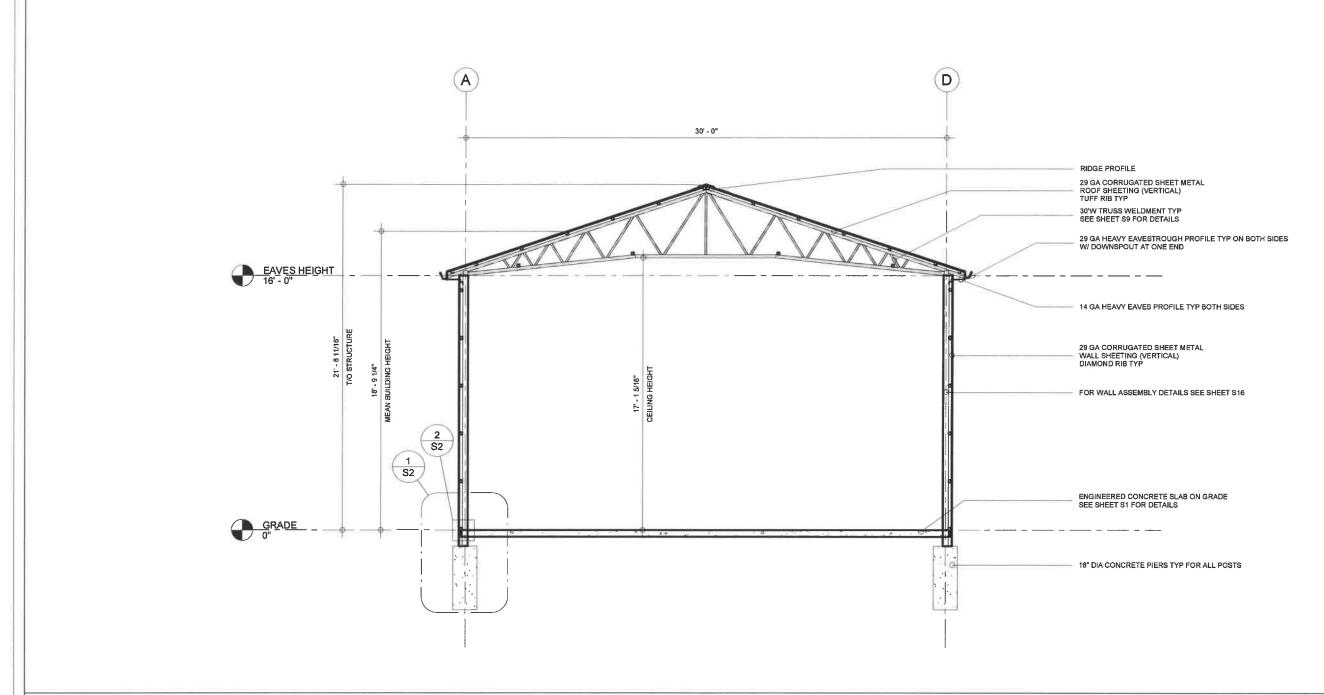



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Website: www.cdnbuildings.com


No.	Description	Date
1	Presentation Pkg for Review	21/08/19
2	Structural Drg Pkg for Review	21/09/07
3	Issued for Review/Permit	-
4	As Built Drawings	-

#### Section 'A'

## ALBRECHT, BRIAN



A2		
Project number	21-706	
Date	2021/09/07	
Drawn by	JK	
Checked by	LDO	
Scale	3/16" = 1'-0"	

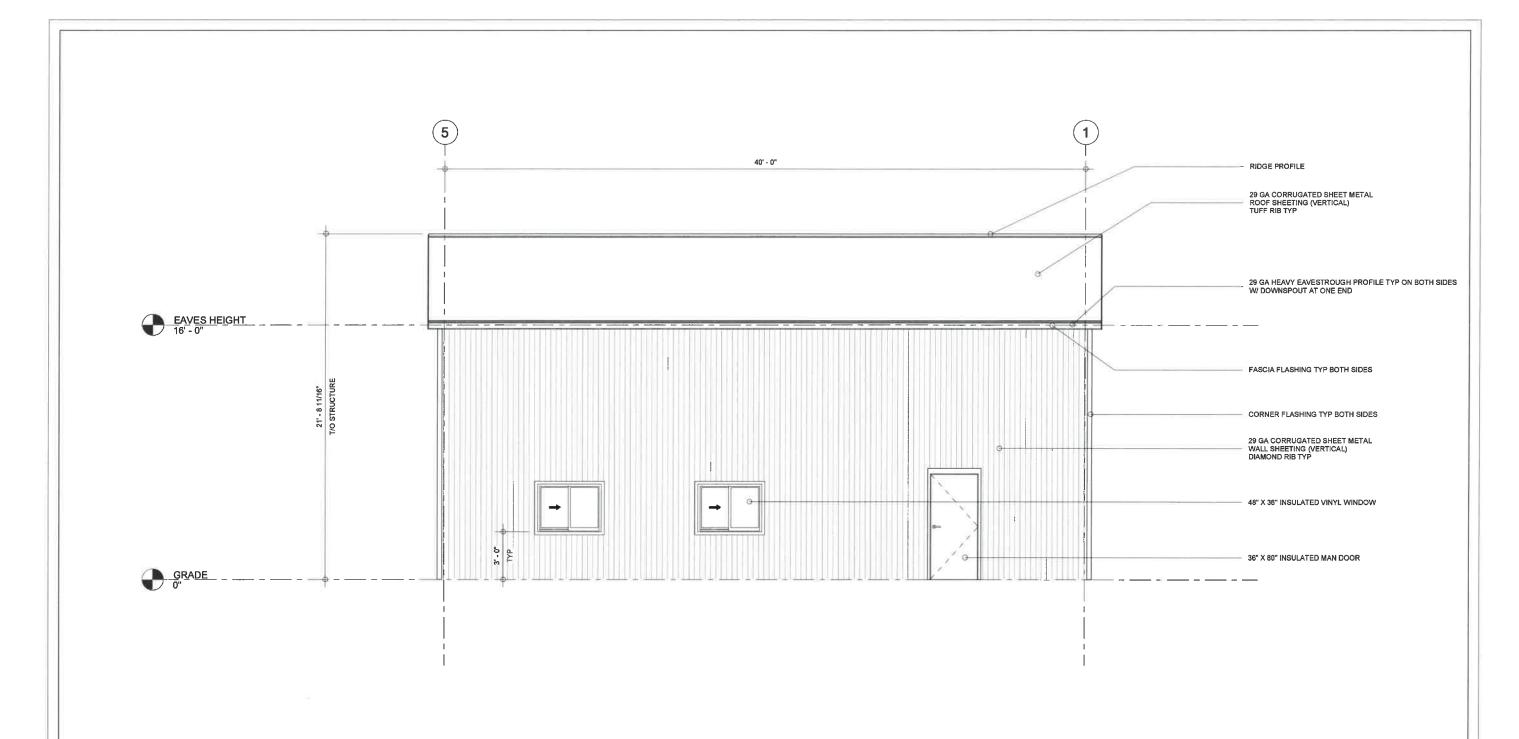



Office: (519) 582-8222 Fax: (519) 582-2098

Website: www.cdnbuildings.com


No.	Description	Date
1	Presentation Pkg for Review	21/08/19
2	Structural Drg Pkg for Review	21/09/07
3	Issued for Review/Permit	-
4	As Built Drawings	-

#### **Elevations - East**

## ALBRECHT, BRIAN



A3		
Project number	21-706	
Date	2021/09/07	
Drawn by	JK	
Checked by	LDO	
Scale	3/16" = 1'-0"	

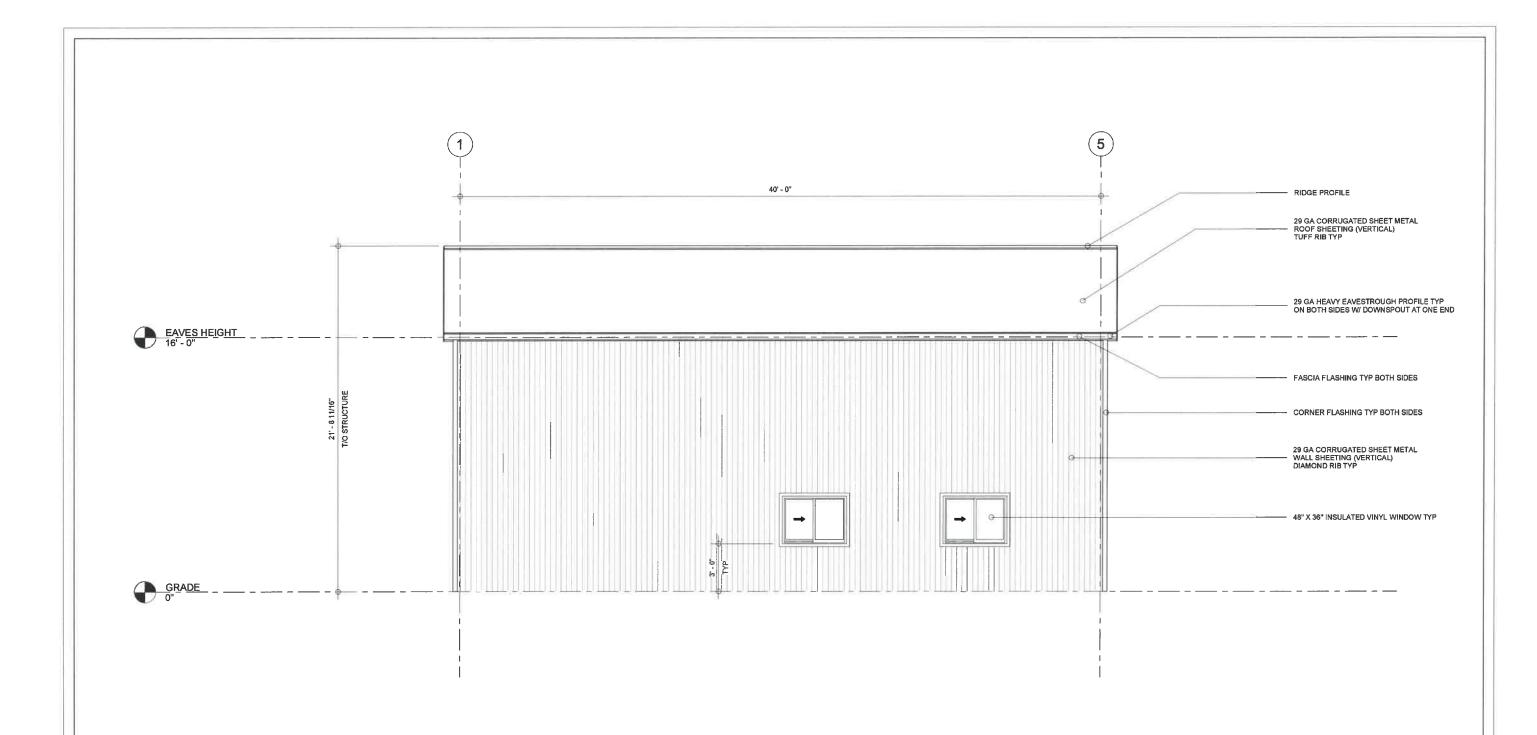



Office: (519) 582-8222 Fax: (519) 582-2098

Website: www.cdnbuildings.com


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1	Presentation Pkg for Review	21/08/19
2	Structural Drg Pkg for Review	21/09/07
3	Issued for Review/Permit	-
4	As Built Drawings	-
		_

**Elevations - West** 

## ALBRECHT, BRIAN



A	<b>A4</b>		
Project number	21-706		
Date	2021/09/07		
Drawn by	JK		
Checked by	LDO		
Scale	3/16" = 1'-0"		

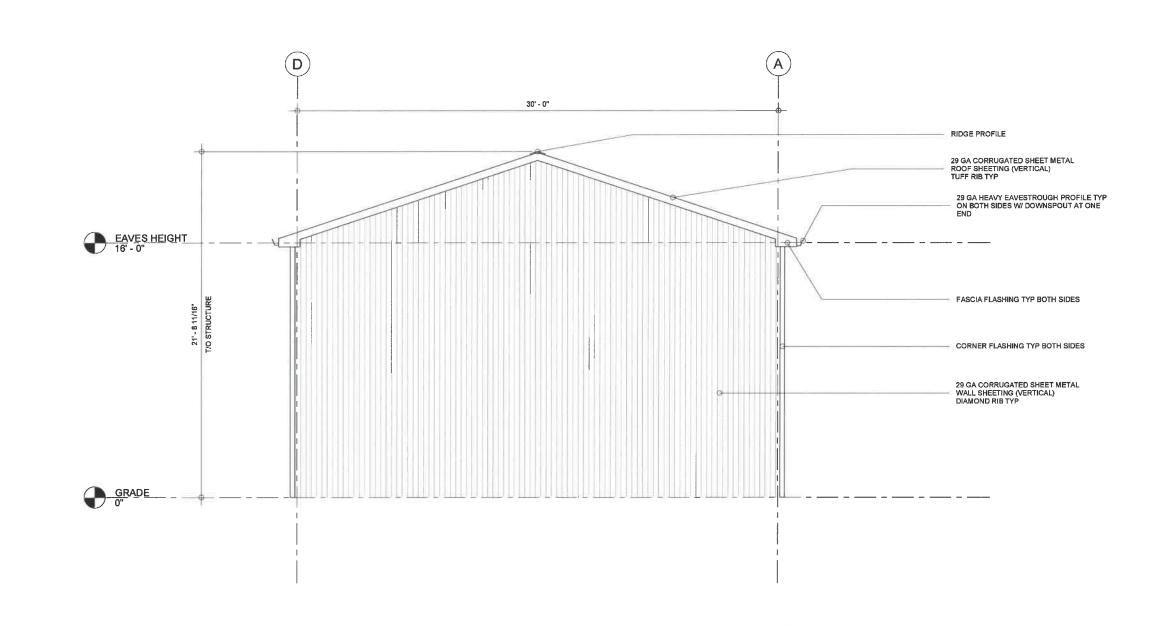



Office: (519) 582-8222 Fax: (519) 582-2098

Website: www.cdnbuildings.com


1/08/19 1/09/07
1/09/07

**Elevations - South** 

## ALBRECHT, BRIAN



A	15
Project number	21-706
Date	2021/09/07
Drawn by	JK
Checked by	LDO
Scale	3/16" = 1'-0"

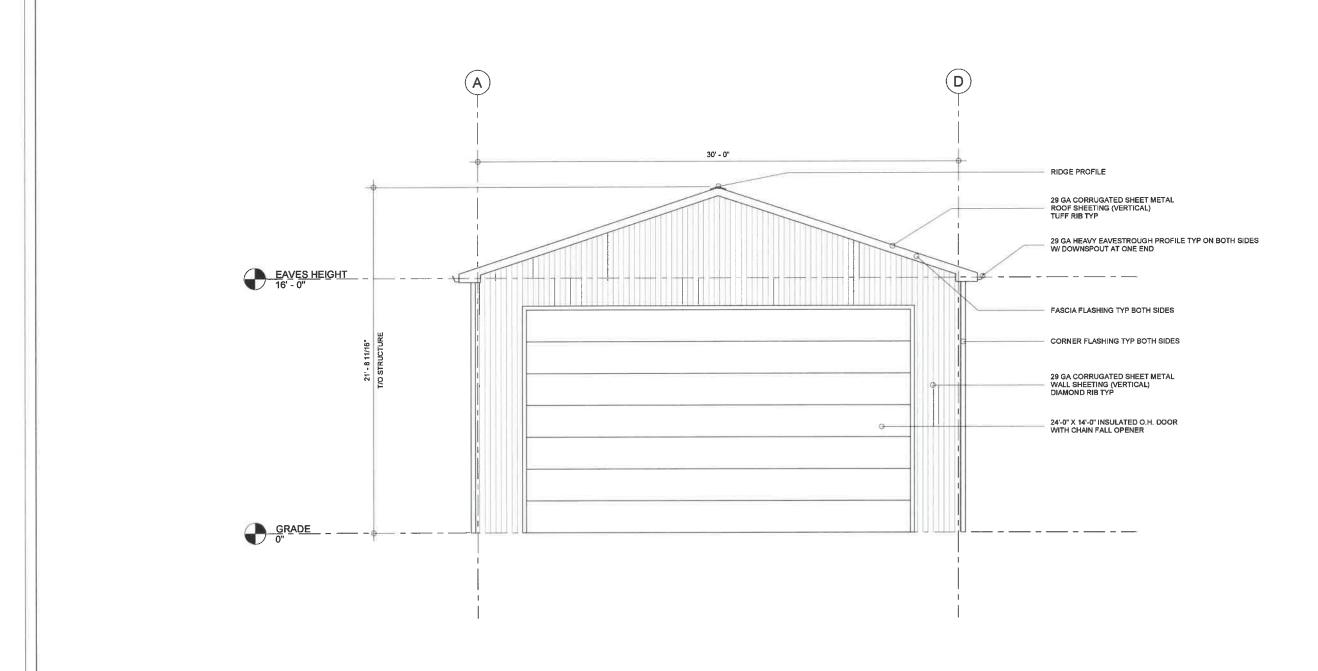



Office: (519) 582-8222 Fax: (519) 582-2098

Website: www.cdnbuildings.com


No.	Description	Date
1	Presentation Pkg for Review	21/08/19
2	Structural Drg Pkg for Review	21/09/07
3	Issued for Review/Permit	-
4	As Built Drawings	-

Elevations - North

## ALBRECHT, BRIAN



A6		
Project number 21-706		
Date	2021/09/07	
Drawn by	JK	
Checked by	LDO	
Scale	3/16" = 1'-0"	

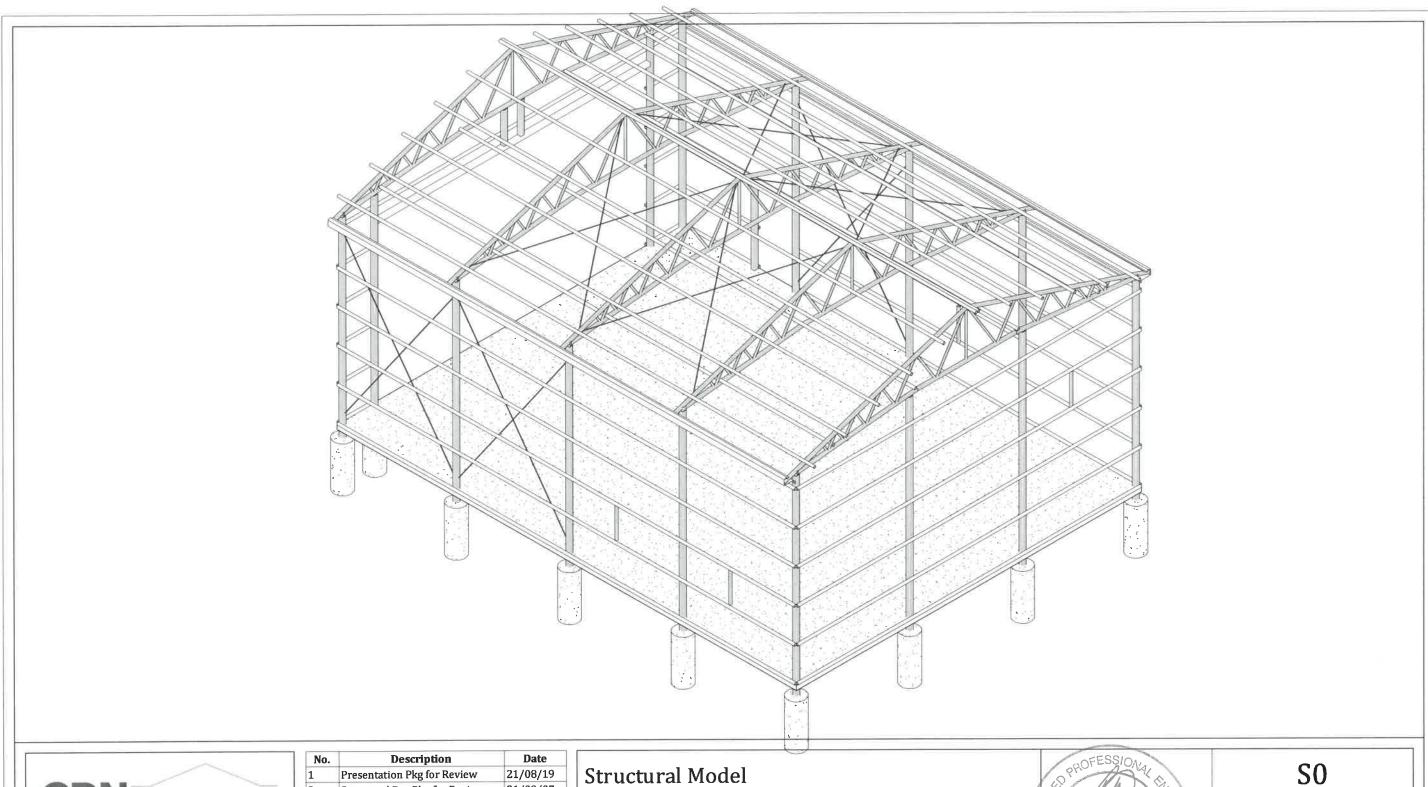



Office: (519) 582-8222 Fax: (519) 582-2098

Website: www.cdnbuildings.com


No.	Description	Date
1	Presentation Pkg for Review	21/08/19
2	Structural Drg Pkg for Review	21/09/07
3	Issued for Review/Permit	-
4	As Built Drawings	-

## ALBRECHT, BRIAN



50		
Project number	21-706	
Date	2021/09/07	
Drawn by	RP	
Checked by	LDO	
Scale		



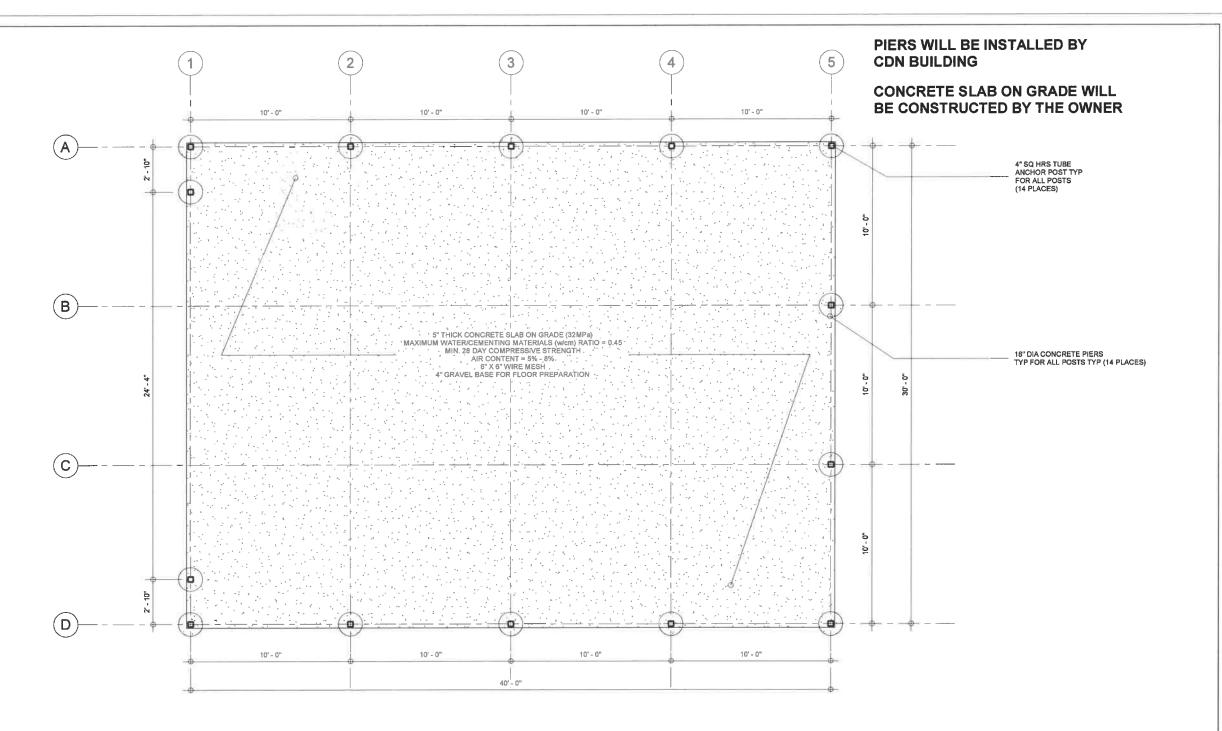



Office: (519) 582-8222 Fax: (519) 582-2098

Website: www.cdnbuildings.com

No.	Description	Date
1	Presentation Pkg for Review	21/08/19
2	Structural Drg Pkg for Review	21/09/07
3	Issued for Review/Permit	-
4	As Built Drawings	-

#### Foundation Plan


## ALBRECHT, BRIAN


293 TOWNLINE ST. ST WILLIAMS ON NOE 1P0



51		
Project number	21-706	
Date	2021/09/07	
Drawn by	RP	
Checked by	LDO	
Scale	3/16" = 1'-0"	

C1

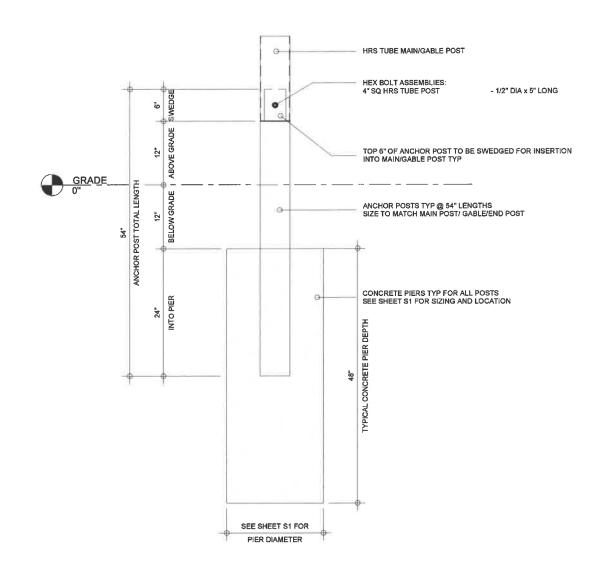

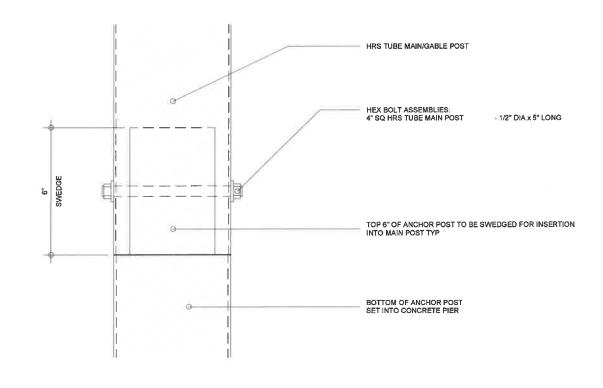

Typical Concrete Pier Detail 3/4" = 1'-0"

Typical Anchor Post to Main Post Connection
3" = 1'-0"

CDN	BUILD	INGS
		11 10.0

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No.	Description	Date
1	Presentation Pkg for Review	21/08/19
2	Structural Drg Pkg for Review	21/09/07
3	Issued for Review/Permit	-
4	As Built Drawings	-

#### Foundation Details


## ALBRECHT, BRIAN

293 TOWNLINE ST. ST WILLIAMS ON N0E 1P0



52	
Project number	21-706
Date	2021/09/07
Drawn by	RP
Checked by	LDO
Scale	As indicated

CO

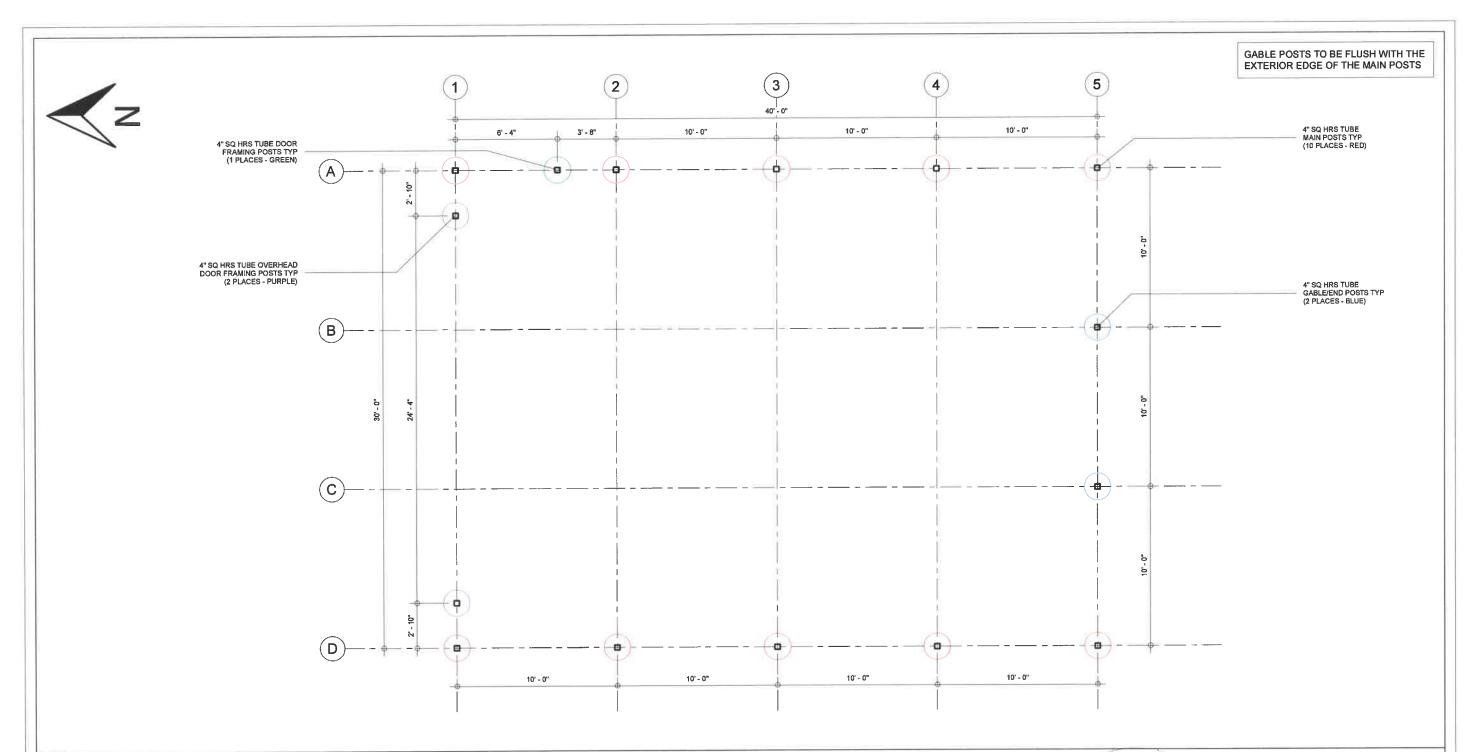



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No.	Description	Date
1	Presentation Pkg for Review	21/08/19
2	Structural Drg Pkg for Review	21/09/07
3	Issued for Review/Permit	-
4	As Built Drawings	-

#### Post Plan

## ALBRECHT, BRIAN


293 TOWNLINE ST. ST WILLIAMS ON NOE 1P0



S3	
Project number	21-706
Date	2021/09/07
Drawn by	RP
Checked by	LDO

3/16" = 1'-0"

Scale

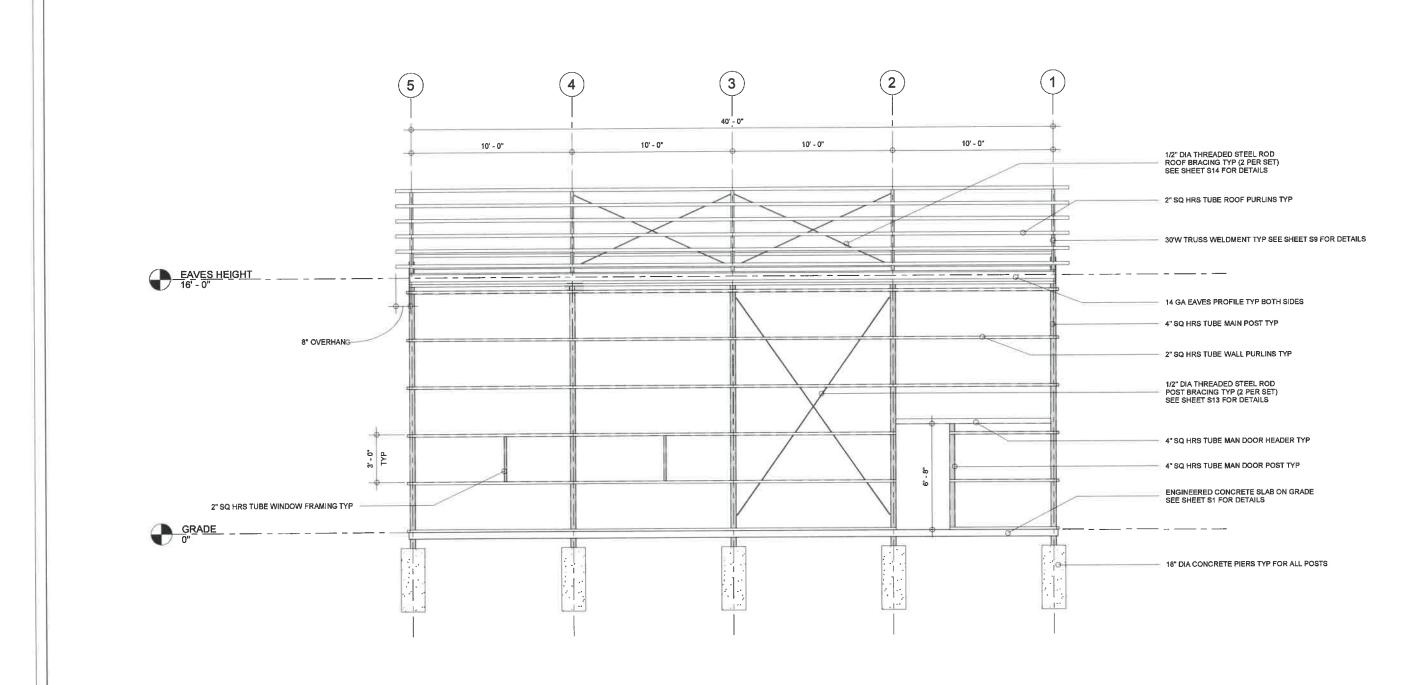




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Website: www.cdnbuildings.com


No.	Description	Date
1	Presentation Pkg for Review	21/08/19
2	Structural Drg Pkg for Review	21/09/07
3	Issued for Review/Permit	-5
4	As Built Drawings	-

Structural Elevations - East

## ALBRECHT, BRIAN

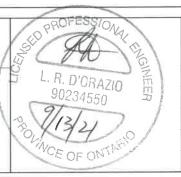

<b>S4</b>	
Project number	21-706
Date	2021/09/07
Drawn by	RP
Checked by	LDO
Scale	3/16" = 1'-0"

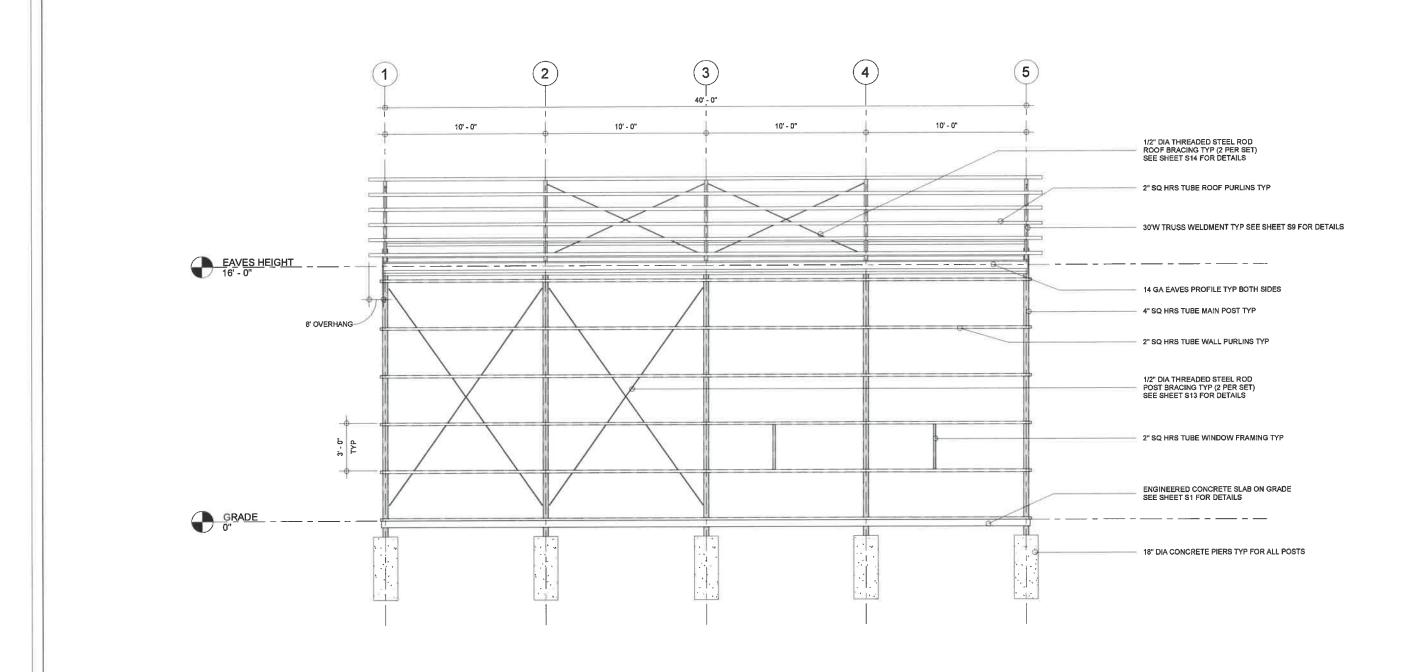



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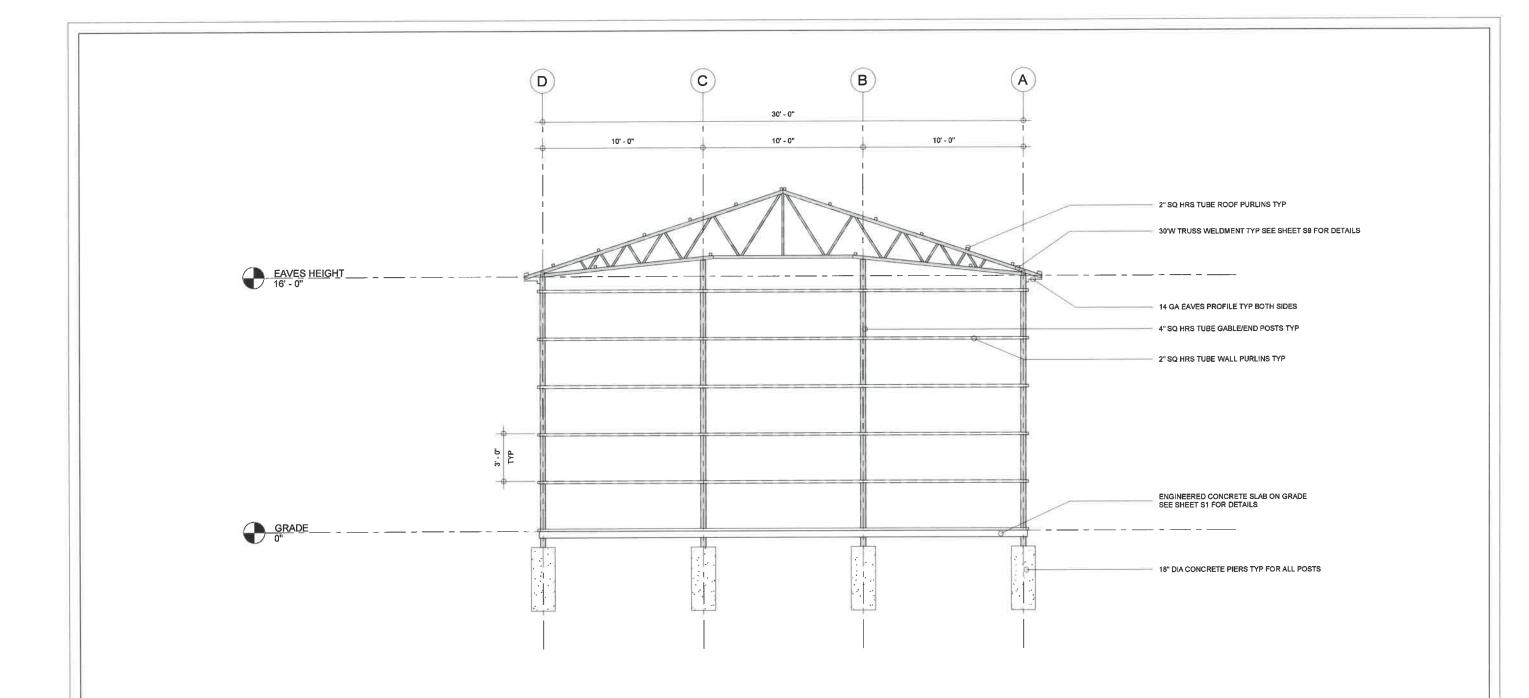
No.	Description	Date
1	Presentation Pkg for Review	21/08/19
2	Structural Drg Pkg for Review	21/09/07
3	Issued for Review/Permit	-
4	As Built Drawings	-
		-
,		

Structural Elevations - West

## ALBRECHT, BRIAN



S5	
Project number 21-706	
Date	2021/09/07
Drawn by	RP
Checked by	LDO
Scale	3/16" = 1'-0"





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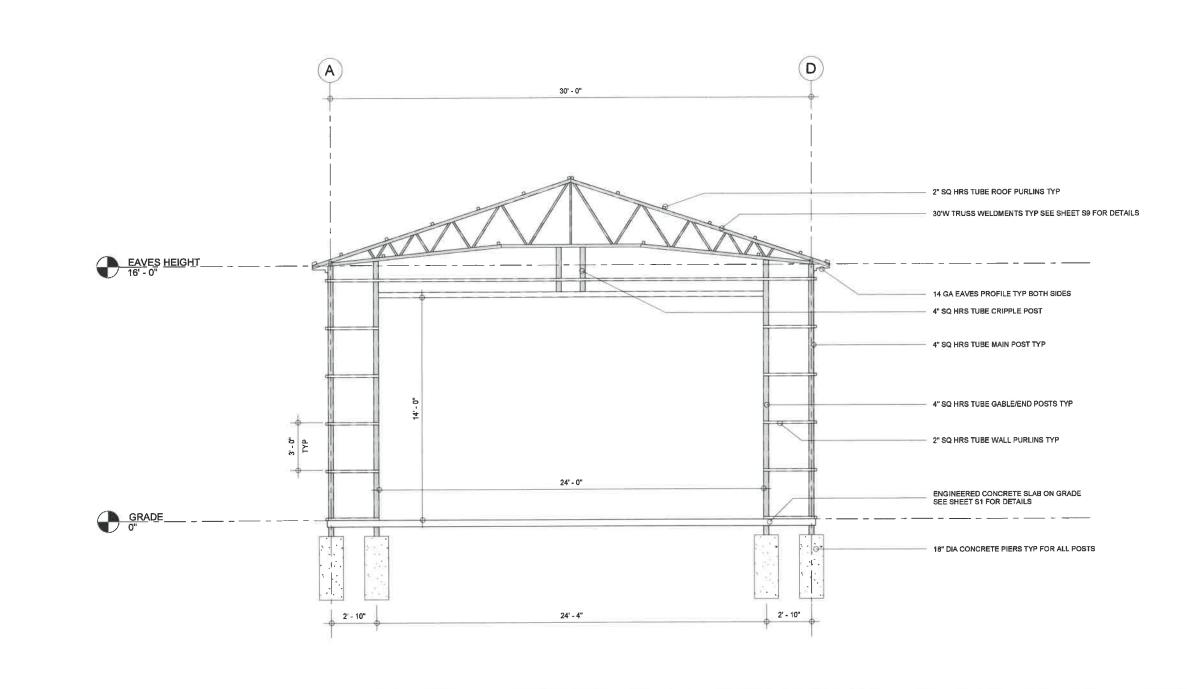
No.	Description	Date
1	Presentation Pkg for Review	21/08/19
2	Structural Drg Pkg for Review	21/09/07
3	Issued for Review/Permit	-
4	As Built Drawings	-

Structural Elevations - South

## ALBRECHT, BRIAN



S6	
Project number	21-706
Date	2021/09/07
Drawn by	RP
Checked by	LDO
Scale	3/16" = 1'-0"





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Website: www.cdnbuildings.com


No.	Description	Date
1	Presentation Pkg for Review	21/08/19
2	Structural Drg Pkg for Review	21/09/07
3	Issued for Review/Permit	-
4	As Built Drawings	-

Structural Elevations - North

## ALBRECHT, BRIAN



57	
Project number	21-706
Date	2021/09/07
Drawn by	RP
Checked by	LDO
Scale	3/16" = 1'-0"

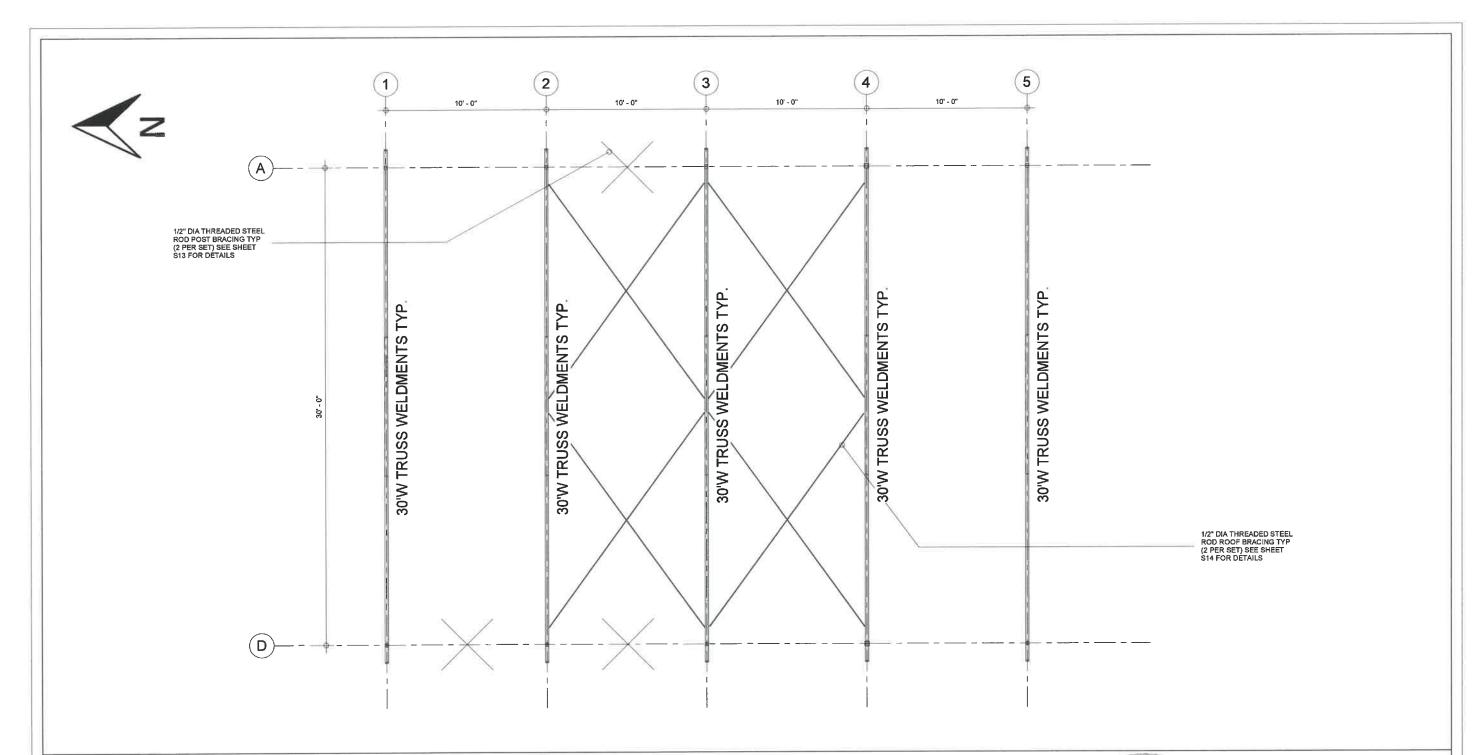



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No.	Description	Date
1	Presentation Pkg for Review	21/08/19
2	Structural Drg Pkg for Review	21/09/07
3	Issued for Review/Permit	-
4	As Built Drawings	-
		-


Truss & Bracing Location

## ALBRECHT, BRIAN



S8		
Project number	21-706	
Date	2021/09/07	
Drawn by	RP	
Checked by	LDO	
Scale	3/16" = 1'-0"	

Ss Sr Cb Cs = 0.4 kPa = 0.4 kPa = 0.8 = 0.92 = 0.9 = 1.22 kPa / 25.6 psf b) WIND = 0.47 kPa = 0.86 kPa

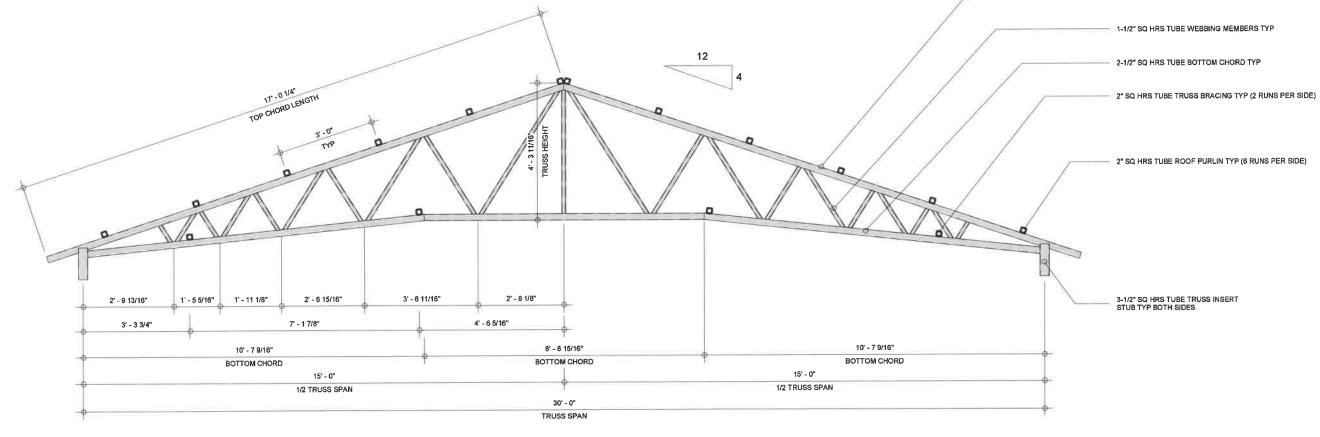

FLARE-V WELD REFER TO PAGE S10-S12 FOR WELD DETAILS



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LOADS: a) SNOW

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= 1.3 kPa (DEAD LOAD = 0.4 kPa)

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No.	Description	Date
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2	Structural Drg Pkg for Review	21/09/07
3	Issued for Review/Permit	-
4	As Built Drawings	-

Truss Deta	il
------------	----


## ALBRECHT, BRIAN

293 TOWNLINE ST. ST WILLIAMS ON NOE 1P0



S	9
Project number	21-706
Date	2021/09/07
Drawn by	RP
Checked by	LDO
Scale	3/8" = 1'-0"

2-1/2" SQ HRS TUBE TOP CHORD TYP

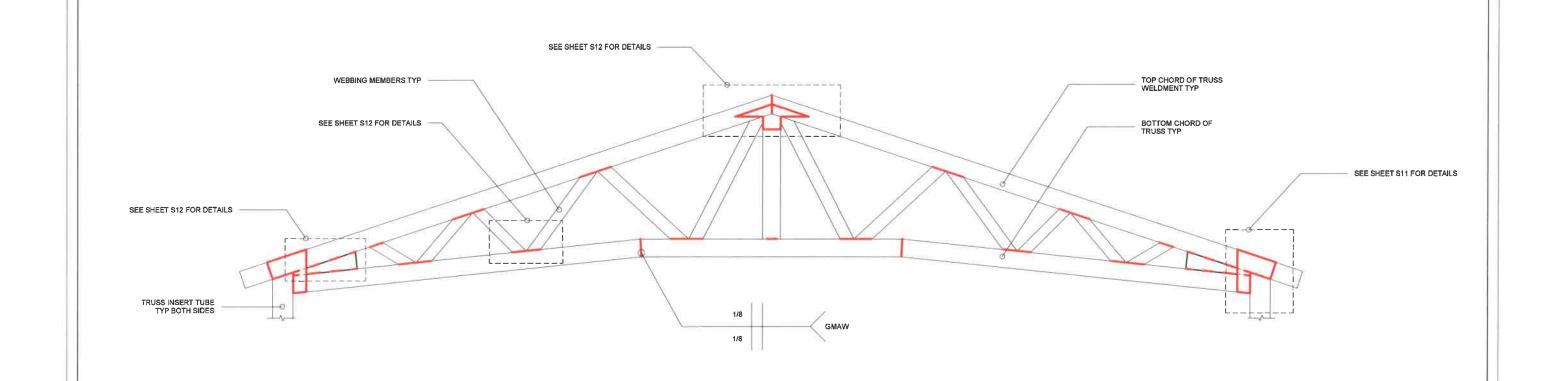

## TYPICAL WEBBING MEMBER WELDING DETAIL



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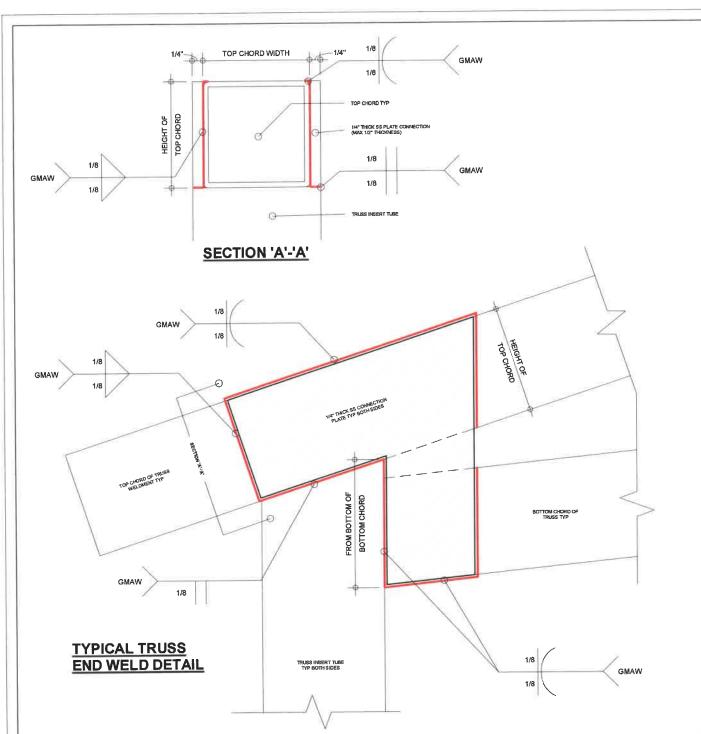
No.	Description	Date
1	Presentation Pkg for Review	21/08/19
2	Structural Drg Pkg for Review	21/09/07
3	Issued for Review/Permit	-
4	As Built Drawings	-


#### Typical Truss Weld Details 1

## ALBRECHT, BRIAN



S	10
Project number	21-706
Date	2021/09/07
Drawn by	RP
Checked by	LDO
Scale	1" = 1'-0"



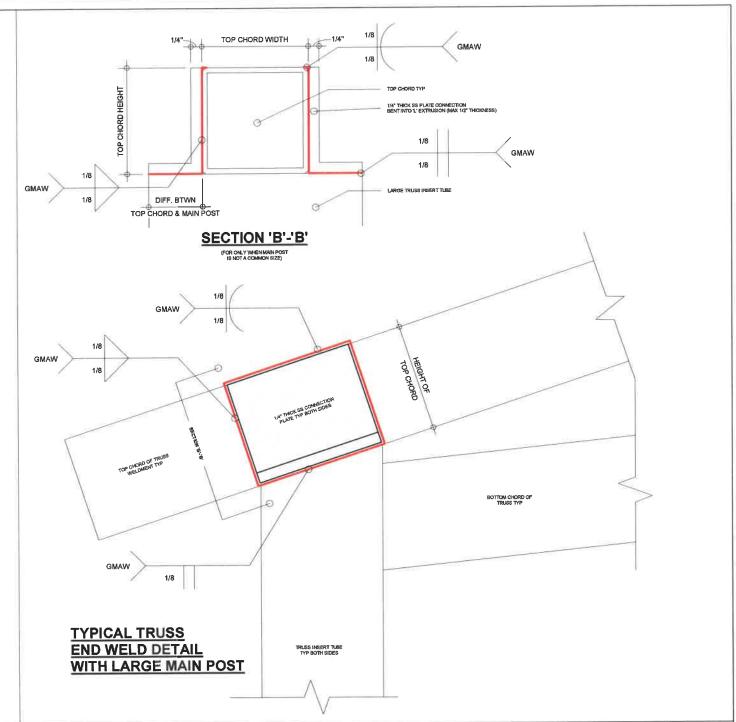



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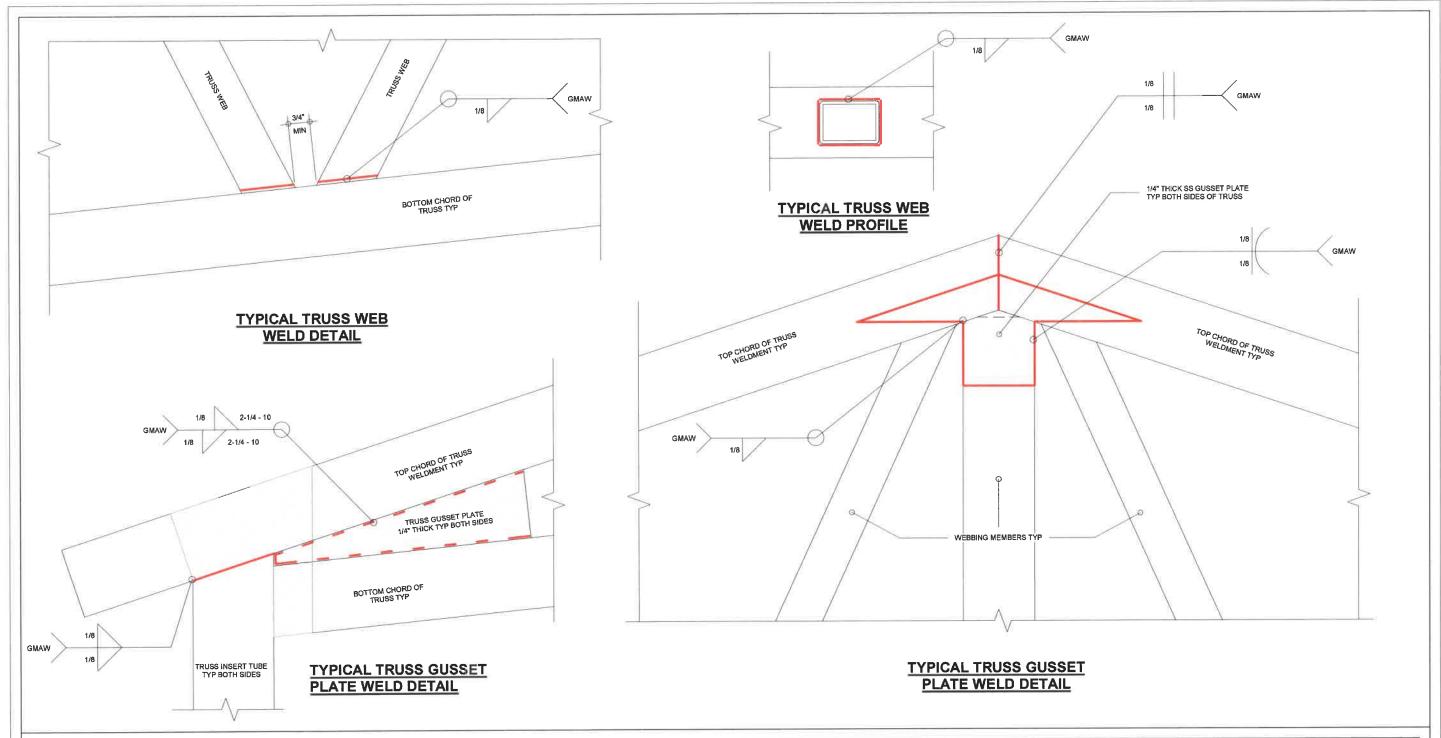
No.	Description	Date
1	Presentation Pkg for Review	21/08/19
2	Structural Drg Pkg for Review	21/09/07
3	Issued for Review/Permit	
4	As Built Drawings	11-

Typical Truss Weld Details 2

## ALBRECHT, BRIAN



S	11
Project number	21-706
Date	2021/09/07
Drawn by	RP
Checked by	LDO
Scale	6" = 1'-0"





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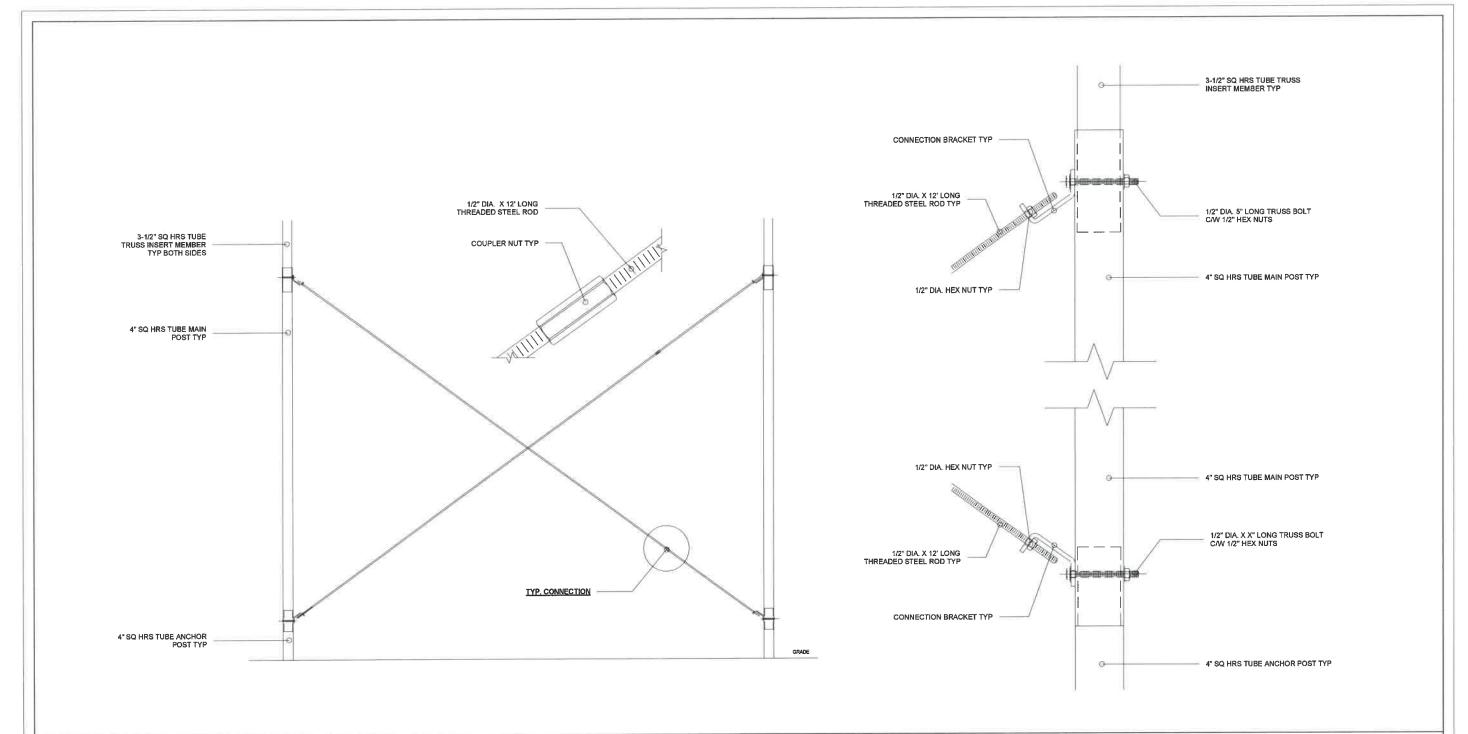
No.	Description	Date
1	Presentation Pkg for Review	21/08/19
2	Structural Drg Pkg for Review	21/09/07
3	Issued for Review/Permit	-
4	As Built Drawings	-

Typical Truss Weld Details 3

## ALBRECHT, BRIAN



S	12
Project number	21-706
Date	2021/09/07
Drawn by	RP
Checked by	LDO
Scale	1:3





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No.	Description	Date
1	Presentation Pkg for Review	21/08/19
2	Structural Drg Pkg for Review	21/09/07
3	Issued for Review/Permit	-
4	As Built Drawings	11-


#### Post Bracing Detail

## ALBRECHT, BRIAN



C	1	
		4

Project number	21-706
Date	2021/09/07
Drawn by	RP
Checked by	LDO
Scale	

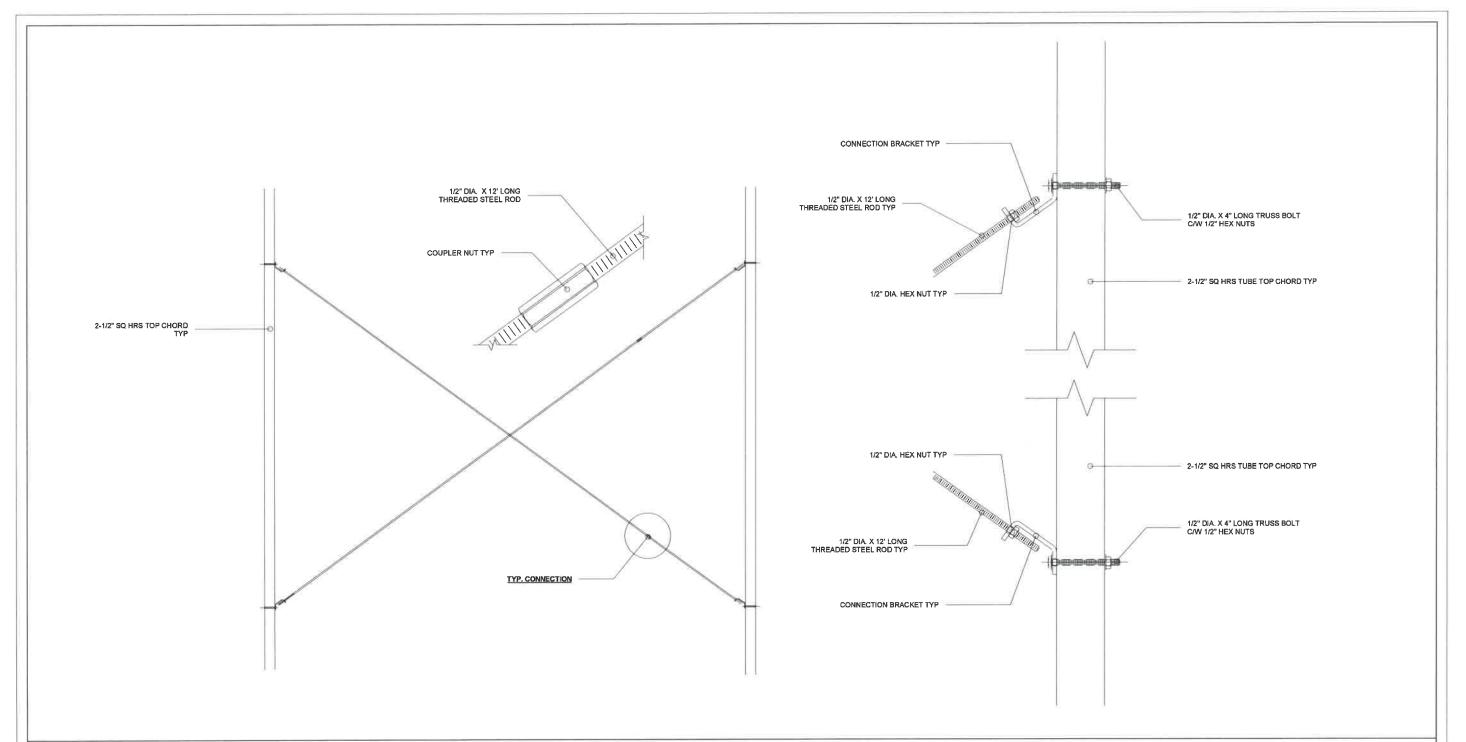



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No.	Description	Date	
1	Presentation Pkg for Review	21/08/19	
2	Structural Drg Pkg for Review	21/09/07	
3	Issued for Review/Permit	-	
4	As Built Drawings	<del>-</del>	

#### Roof Bracing Detail


## ALBRECHT, BRIAN


293 TOWNLINE ST. ST WILLIAMS ON NOE 1P0




### **S14**

Project number	21-706
Date	2021/09/07
Drawn by	-
Checked by	LDO
Scale	

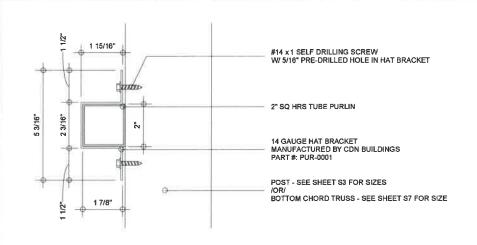

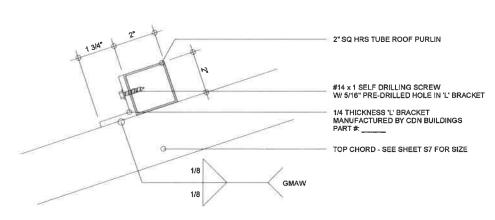

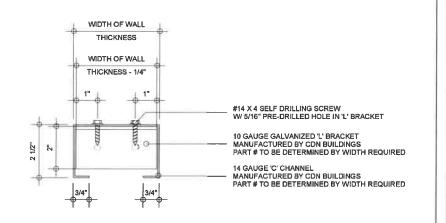



2" SQ HRS Connection S15 / 3" = 1'-0"

2" SQ HRS Roof Connection S15 3" = 1'-0"

'C' Channel Connection

S15 3" = 1'-0"

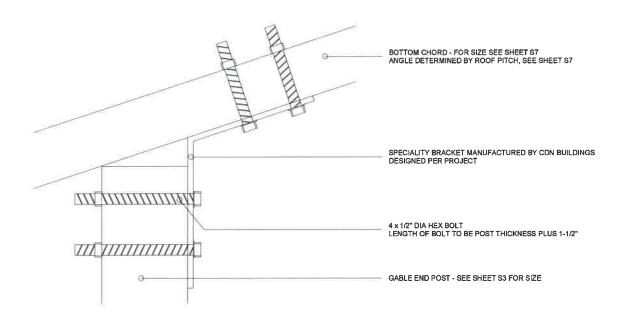

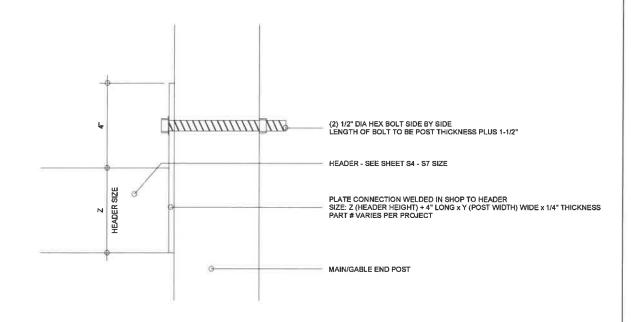

**Gable Post Connection** S15 3" = 1'-0"

O.H. Header Connection S15

3" = 1'-0"

CDM		100
CDN	BUILD	NGS

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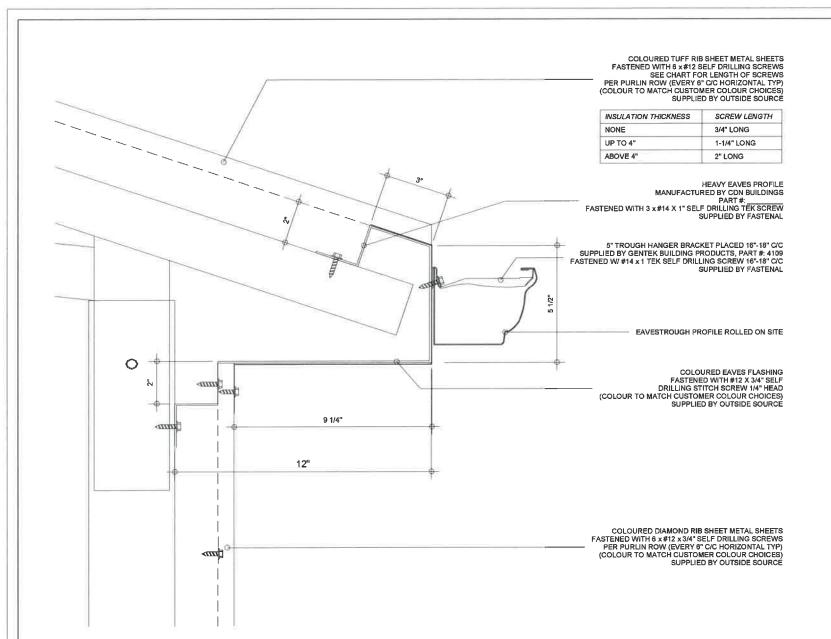
No.	Description	Date
1	Presentation Pkg for Review	21/08/19
2	Structural Drg Pkg for Review	21/09/07
3	Issued for Review/Permit	-
4	As Built Drawings	-


A	L	B	R	E(	<u>`</u> F	IT	B	R	A	N

**Connection Details** 



S15		
Project number 21-706		
Date	2021/09/07	
Drawn by	RP	
Checked by	LDO	
Scale	3" = 1'-0"	



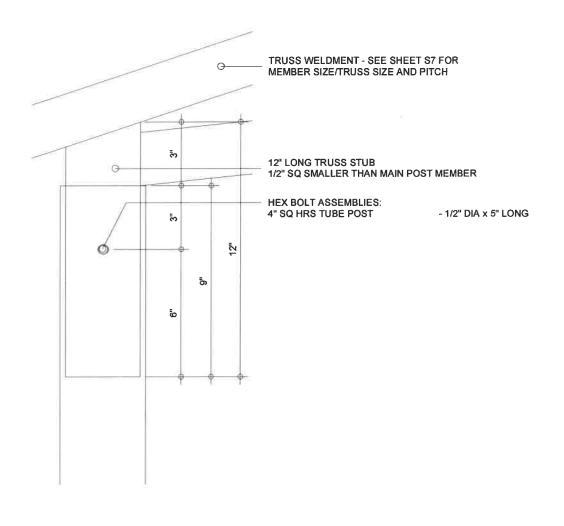

1

Eaves with 2" SQ HRS Wall Purlins

S16 3" = 1'-0"

2 Truss Stub Connection

S16 3" = 1'-0"



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No.	Description	Date		
1	Presentation Pkg for Review	21/08/19		
2	Structural Drg Pkg for Review	21/09/07		
3	Issued for Review/Permit	-		
4	As Built Drawings	-		

#### Eaves/Wall Details

#### ALBRECHT, BRIAN



\$16				
Project number	21-706			
Date	2021/09/07			
Drawn by	RP			
Checked by	LDO			
Scale	3" = 1'-0"			

	MATE	RIAL SPECIFICATION		
NO.	ITEM	MATERIAL		
1	ANCHOR POSTS (MAIN)	4" SQ HRS TUBE X 0.125" WALL X 54" LONG HDG		
2	ANCHOR POSTS (GABLE)	4" SQ HRS TUBE X 0.125" WALL X 54" LONG HDG		
3	MAIN POSTS	4" SQ HRS TUBE X 0.125" WALL 16'-0" LONG HDG		
4	GABLE/END POSTS	4" SQ HRS TUBE X 0.125" WALL X TO SUIT HDG		
5	30'W TRUSS WELDMENTS	TOP CHORDS		
	ON 10'-0" CENTERS	2-1/2" SQ HRS TUBE X 0.125" WALL HDG		
	TYP OF 5	BOTTOM CHORDS		
		2-1/2" SQ HRS TUBE X 0.125" WALL HDG		
		WEBBING MEMBERS		
		1-1/2" SQ HRS TUBE X 0.125" WALL HDG		
6	ROOF PURLINS	2" SQ HRS TUBE X 0.100" WALL @ 36" C/C		
7	WALL PURLINS	2" SQ HRS TUBE X 0.100" WALL @ 36" C/C		
8	ROOF BRACING	1/2" DIA. THREADED STEEL RODS @ 12'-0" LENGTHS HDG		
9	POST BRACING	1/2" DIA. THREADED STEEL RODS @ 12'-0" LENGTHS HDG		
10	ROOF SHEETING	29 GA CORRUGATED SHEET METAL TUFF RIB		
11	WALL SHEETING	29 GA CORRUGATED SHEET METAL DIAMOND RIB 36		
12	INT. WALL SHEETING	N/A		



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Description	Date
Presentation Pkg for Review	21/08/19
Structural Drg Pkg for Review	21/09/07
Issued for Review/Permit	-
As Built Drawings	-
	Presentation Pkg for Review Structural Drg Pkg for Review Issued for Review/Permit

**Material Specification** 

## ALBRECHT, BRIAN



	S17					
	Project number	21-706				
	Date	2021/09/07				
	Drawn by	RP				
	Checked by	LDO				
	Scale					

DESIGN RESPONSIBILITY
CON BUILDINGS ENGINEER IS THE DESIGN PROFESSIONAL OR ENGINEER OF RECORD FOR THE CONSTRUCTION PROJECT. CDN BUILDINGS IS NOT RESPONSIBLE FOR THE DESIGN OF ANY COMPONENT OR MATERIAL NOT SOLD BY IT. OR THEIR INTERFACE AND CONNECTION WITH THE STEEL BUILDINGS SYSTEM. UNLESS SUCH DESIGN RESPONSIBILITY IS SPECIFICALLY REQUIRED BY THE CONTRACT DOCUMENTS. CDN BUILDINGS IS ONLY RESPONSIBLE FOR ENSURING THAT THE COMPONENTS SUPPLIED BY IT ARE DESIGNED IN ACCORDANCE WITH THE APPLICABLE BUILDING CODES OR OTHER CRITERIA. ALL AS SPECIFIED BY THE OWNER, THE PROFESSIONAL ENGINEER AND/OR ARCHITECT OF RECORD RETAINED BY THE OWNER, OR THE DESIGN-BUILDER. THE DESIGNER (OF THE STRUCTURE) WHETHER DESIGN-BUILDER, ARCHITECT AND/OR PROFESSIONAL ENGINEER OF RECORD. IS RESPONSIBLE FOR SPECIFYING TO CDN BUILDINGS THE CODE AND STANDARDS TO GOVERN DESIGN, ALL DESIGN LOADS SUCH AS SNOW LOADS (INCLUDING COEFFICIENTS AND DRIFT CONDITIONS), WIND LOADS, COLLATERAL LOADS, SITE CONDITIONS FOR SEISMIC DESIGN, AND ANY OTHER SUPERIMPOSED LOADS WHICH THE STRUCTURE IS REQUIRED TO SUSTAIN. IT IS A VIOLATION OF THE LAW FOR ANY PERSON, UNLESS HE/SHE IS ACTING UNDER THE DIRECTION OF A LICENSED PROFESSIONAL ENGINEER, TO ALTER ANY ITEM ON THESE PLANS IN ANY WAY, IF ANY ITEM ON THESE PLANS IS ALTERED, THE ALERTING ENGINEER MUST AFFIX TO THE ITEM HIS/HER SEAL AND THE NOTATION "ALTERED BY" FOLLOWED BY HIS/HER SIGNATURE AND THE DATE OF SUCH ALTERNATION, AND A SPECIFIC DESCRIPTION OF THE ALTERATION CON BUILDINGS ASSUMES THAT ALL WINDOWS AND DOORS WILL BE DESIGNED TO WITHSTAND THE WIND LOADS SHOWN AND WILL REMAIN CLOSED DURING PERIOD OF SEVERE WINDS (THIS DOES NOT APPLY TO BUILDINGS DESIGNED AS CATEGORY 3).
FOR FURTHER CLARIFICATION OF DESIGN RESPONSIBILITY, REFER TO CSSBI B8 - 06 - BUILDINGS

INCORPORATING STEEL BUILDING SYSTEMS: RESPONSIBILITIES OF PARTIES INVOLVED.

CDN BUILDINGS IS RESPONSIBLE FOR THE DESIGN, MATERIALS, AND WORKMANSHIP OF THE FOUNDATION. ANCHOR BOLT PLANS ARE PREPARED BY CDN BUILDINGS ARE INTENDED TO SHOW ONLY LOCATION, DIAMETER, AND PROJECTION OF THE ANCHOR RODS REQUIRED TO ATTACH THE STEEL BUILDING SYSTEM TO THE FOUNDATION. IT IS THE RESPONSIBILITY OF THE END CUSTOMER AND/OR THEIR DESIGN PROFESSIONAL TO ENSURE THAT ADEQUATE PROVISIONS ARE MADE FOR SPECIFYING BOLT EMBEDMENT, BEARING ANGLES, TIE RODS AND/OR OTHER ASSOCIATED ITEMS EMBEDDED IN THE CONCRETE FOUNDATION, AS WELL AS FOUNDATION DESIGN FOR THE LOADS IMPOSED BY THE STEEL BUILDING SYSTEM, OTHER IMPOSED LOADS, AND THE BEARING CAPACITY OF THE SOIL AND OTHER CONDITIONS OF THE BUILDING SITE. CDN BUILDINGS DOES NOT SPECIFY GROUT REQUIREMENTS - THE IS THE RESPONSIBILITY OF THE FOUNDATION DESIGNER. THE CHAR PROVIDED WITH THE ANCHOR PLANS/DETAILS IS INTENDED TO DEMONSTRATE THAT GROUT SHALL BE TAKEN INTO ACCOUNT WHEN DETERMINING ANCHOR BOLT PROJECTION, IT DOES NOT CONSTITUTE THE SPECIFICATION OF GROUT BY THE CDN ENGINEER.

SERVICE ABILITY
UNLESS OTHERWISE SPECIFIED IN THE CONTRACT DOCUMENTS, CDN BUILDINGS USES INDUSTRY STANDARD DEFLECTION LIMITS AS SPECIFIED IN CSSI B15B - 15. IN GENERAL, WE DO NOT USE THE RECOMMENDED LIMIT SPECIFIED IN ANNEX D OF CSA \$16, WHICH IS A NON - MANDATORY PART OF THIS STANDARD.

SITE INSPECTIONS
CDN BUILDINGS DOES PERFORM GENERAL REVIEW OF CONSTRUCTION (SITE INSPECTIONS) FOR COMPONENTS SUPPLIED BY IT. THIS RESPONSIBILITY IS EXPLICITLY EXCLUDED FROM CDN BUILDINGS SCOPE OF THE CONTRACT POOLING MES OF WORK, UNLESS SPECIFIED IN THE CONTRACT DOCUMENTS FOR AN AGREED FEE.

EXISTING BUILDINGS
CDN BUILDINGS DOES NOT INVESTIGATE THE INFLUENCE OF THE STEEL BUILDING SYSTEM ON EXISTING BUILDINGS OR STRUCTURES. THE END CUSTOMER AND/OR THEIR DESIGN PROFESSIONAL MUST ENSURE CONDITIONS AS A RESULT OF THE PRESENCE OF THE STEEL BUILDING SYSTEM.

INDEPENDENT / SELF - SUPPORTING COMPONENTS
MEZZANINES, BLOCK WALLS, OR ANY OTHER COMPONENTS BY OTHERS THAT ARE IDENTIFIED AS INDEPENDENT OR SELF - SUPPORTING, MUST BE DESIGNED BY A PROFESSIONAL ENGINEER. THE ENGINEER MUST ENSURE THAT PROPER ISOLATION FROM THE CON BUILDING HAS BEEN PROVIDED TO AVOID STRUCTURAL DAMAGE DUE TO DIFFERENTIAL MOVEMENTS, OR INADVERTENTLY APPLYING LOADS TO THE CDN BUILDINGS STRUCTURE. CDN BUILDINGS ACCEPTS NO RESPONSIBILITY FOR THE DESIGN OF ANY INDEPENDENT/SELF - SUPPORTING COMPONENTS.

FIRE CODE COMPLIANCE
IT IS THE RESPONSIBILITY OF THE PROJECT DESIGN PROFESSIONAL AND BUILDER TO COMPLY WITH LOCAL FIRE CODE REGULATIONS INCLUDING CONSIDERATION OF, BUT NOT LIMITED TO, BUILDING USE AND OCCUPANCY, ALL BUILDING CONSTRUCTION MATERIALS, SEPARATION REQUIREMENTS, EGRESS REQUIREMENTS, FIRE PROTECTION SYSTEMS, ETC. THE BUILDER SHALL ADVISE CDN BUILDINGS OF ANY SPECIAL REQUIREMENTS TO BE FURNISHED BY CDN BUILDINGS

PRELIMINARY DRAWINGS
CDN BUILDINGS ISSUES PRELIMINARY DRAWINGS MARKED AS 'ISSUED FOR INFORMATION' FOR EACH PROJECT. INFORMATION PRESENTED ON PRELIMINARY DRAWINGS MAY DIFFER FROM DRAWINGS/DOCUMENTS PROVIDED BY OTHER FIRMS, AND ALSO FROM PERVIOUS CDN BUILDINGS DRAWINGS/DOCUMENTS. THE DEVIATIONS MAY BE DUE TO INTERPRETATIONS OF THE CONTRACT REQUIREMENTS, OR NECESSARY PROVISIONS FOR STRUCTURAL PERFORMANCE AND MANUFACTURING ABILITY. THE MOST RECENT SET OF DRAWINGS THAT IS SEALED BY A CDN BUILDINGS ENGINEER SHALL TAKE PRECEDENCE OVER ANY PREVIOUS DRAWINGS/DOCUMENTS. THE CUSTOMER SHALL PERFORM A

THOROUGH REVIEW OF ALL ITEMS SHOWN IN EACH DRAWING SET RECEIVED, IN ORDER TO CONFIRM ADHERENCE TO THE CONTRACT REQUIREMENTS.

APPROVAL IS REQUIRED IN ORDER TO PROCEED WITH MANUFACTURING. WHEN THE APPROVAL STAMP IS PRESENT, PLEASE SIGN AND DATE EACH DRAWING, AND CLEARLY INDICATE ANY CHANGES REQUIRED. FAILURE TO DO SO IN A TIMELY MANNER MAY RESULT IN PROJECT DELAYS. NOTE THAT CHANGES REQUESTED ON THE DRAWINGS ARE NOT BINDING UNLESS SUBSEQUENTLY ACKNOWLEDGED AND AGREED TO IN WRITING. APPROVAL OF CDN BUILDINGS DRAWINGS CONSTITUTES ACCEPTANCE OF OUR INTERPRETATION, AND FURTHER CONSTITUTES AGREEMENT THAT THE BUILDING AS SHOWN REPRESENTS THE TOTAL OF THE MATERIALS TO BE SUPPLIED. ANY CHANGE REQUESTS THAT OCCUR AFTER APPROVAL MAY RESULT IN ADDITIONAL COSTS AND DELAYS.

BUILDER/CUSTOMER MUST SECURE ALL REQUIRE APPROVALS AND PERMITS FROM THE APPROPRIATE AGENCIES AS REQUIRED

BOLT TIGHTENING
PROPER INSTALLATION AND INSPECTION OF ALL FASTENERS IS THE RESPONSIBILITY OF THE ERECTOR. ALL HIGH STRENGTH (A325, A490) BOLTS AND NUTS MUST BE TIGHTENED BY THE TURN — OF — NUT METHOD AS SPECIFIED IN THE INSTALLATION AND INSPECTION OF BOLTED JOINTS' CLAUSE OF CSA S16. INSPECTION OF HIGH STRENGTH BOLTED JOINTS BY OTHER THAN THE ERECTOR MUST BE SPECIFIED IN THE CONTRACT DOCUMENTS, AND THE ERECTOR IS RESPONSIBLE FOR ENSURING THAT INSTALLATION AND INSPECTION PROCEDURES ARE COMPATIBLE PRIOR TO THE START OF THE ERECTION.

**TABLE 8: NUT ROTATION FROM SNUG-TIGHT CONDITION** 

BOLT LENGTH\* TURN IP TO AND INCLUDING 4 BOLT DIAMETERS 1/3 OVER 4 DIAMETERS AND NOT EXCEEDING 8 DIAMETERS 1/2 **EXCEEDING 8 DIAMETERS OR 8 INCHES** 2/3 \*\* BOLT LENGTH IS MEASURED FROM THE UNDERSIDE OF THE HEAD TO THE EXTREME END OF POINT

<u>ERECTION – GENERAL</u> CDN BUILDINGS IS RESPONSIBLE FOR THE ERECTION OF THE STEEL BUILDING SYSTEM, THE SUPPLY OF ANY TOOLS OR EQUIPMENT, SUPERVISION FOR THE ERECTION OF THE STRUCTURE, OR ANY OTHER FIELD WORK FIELD ERECTION OF A STEEL BUILDING. AS IN ALL CONSTRUCTION PROJECTS. INVOLVES HAZARDS TO PERSONS WITHIN THE AREA OF THE CONSTRUCTION AND RISK OF DAMAGE TO THE PROPERTY ITSELF, CDN BUILDINGS DOES NOT FURNISH A GENERAL ERECTION MANUAL, HOWEVER FIELD ERECTION PROCEDURES CAN VARY BECAUSE OF MANY ITEMS INCLUDING LOCAL CONDITIONS, EQUIPMENT AVAILABILITY, THE TYPE OF BUILDING BEING ERECTED AND THE EXPERTISE OF THE PARTICULAR ERECTOR. THE ERECTOR, BY ENTERING INTO A CONTRACT TO ERECT THE BUILDING, HOLD ITSELF OUT AS SKILLED IN THE ERECTION OF STEEL BUILDING SYSTEMS, AND IS RESPONSIBLE FOR COMPLYING WITH ALL APPLICABLE MUNICIPAL, PROVINCIAL, AND FEDERAL CONSTRUCTION AND SAFETY REGULATIONS AS WELL AS ANY APPLICABLE REQUIREMENTS MUNICIPAL, PROVINCIAL, FEDERAL, AND INTERNATIONAL UNION RULES OR PRACTICES. THE ERECTION DRAWINGS FURNISHED BY CDN BUILDINGS ARE NOT INTENDED TO SPECIFY ANY PARTICULAR METHOD OF ERECTION TO BE FOLLOWED BY THE ERECTOR. THE ERECTOR IS ALSO RESPONSIBLE FOR SUPPLYING ANY SAFETY DEVICES SUCH AS FALL ARREST SYSTEMS. MAN – LIFTS, AND ANCHOR POINTS ETC. WHICH MAY BE REQUIRED TO SAFELY ERECT THE STEEL BUILDING SYSTEM. CDN BUILDINGS EXPRESSLY DISCLAIMS ANY RESPONSIBILITY FOR ANY INJURY TO PERSONS IN THE COURSE OF ERECTION OR DAMAGE TO THE PRODUCT ITSELF. ONLY EXPERIENCED PERSONS WHO ARE SKILLED AND QUALIFIED IN THE ERECTION OF STEEL BUILDINGS SHOULD BE PERMITTED TO FIELD - ERECT A BUILDING DUE TO THE HAZARDS OF THIS CONSTRUCTION ACTIVITY, ALL ERECTION EQUIPMENT AND DETAILED ERECTING PROCEDURES WILL BE DETERMINED BY AND INDEPENDENT QUALIFIED PROFESSIONAL ENGINEER RETAINED BY THE BUILDER AS

ERECTION TOLERANCES
ERECTION TOLERANCES ARE THOSE SET FORTH IN THE "DESIGN OF STEEL STRUCTURES" (CSA S16 LATEST

TEMPORARY BRACING DURING CONSTRUCTION
THE ERECTOR SHALL FURNISH TEMPORARY GUYS AND BRACING WHERE NEEDED FOR SQUARING,
PLUMBING, AND SECURING THE STRUCTURAL FRAMING AGAINST LOADS, SUCH AS WIND LOADS ACTING ON THE EXPOSED FRAMING, AS WELL AS LOADS DUE TO ERECTION EQUIPMENT AND OPERATION. THESE CONSTRUCTION LOADS CAN BE SIGNIFICANTLY HIGHER THAN LOADS WHICH WILL BE APPLIED ONCE THE BUILDING IS COMPLETED ERECTED, AND ACCORDINGLY, BRACING FURNISHED BY CDN BUILDINGS FOR THE STEEL BUILDING SYSTEM CANNOT BE ASSUMED TO BE ADEQUATE DURING ERECTION. COLUMN BASE PLATES ARE TYPICALLY PIN' CONNECTIONS, AND IT IS THEREFORE EXTREMELY DANGEROUS TO LEAVE ANY COLUMN AS 'FREE STANDING' (NO LATERAL SUPPORT AT THE TOP) FOR ANY LENGTH OF TIME, SPECIAL CARE MUST BE TAKEN WHEN COLUMNS ARE GROUTED, AS THEY TEND TO BE UNSTABLE UNTIL THE GROUT IS IN PLACE. TEMPORARY SUPPORTS SUCH AS TEMPORARY GUYS, BRACING, FALSEWORK, CRIBBLING OR OTHER ELEMENTS REQUIRE FOR THE ERECTIONS OPERATION SHALL BE DETERMINED AND FURNISHED AND INSTALLED BY THE ERECTOR

FABRICATION/DRAWING ERRORS
THE BUILDER/CUSTOMER IS RESPONSIBLE FOR CONTACTING CDN BUILDINGS MANAGEMENT TEAM TO ADVISE CDN BUILDINGS OF FABRICATION/DRAWING PROBLEMS AND CORRESPONDING FIELD CORRECTION COST ESTIMATES, CDN BUILDINGS WILL THEN BE RESPONSIBLE FOR PROVIDING THE BUILDER WITH WRITTEN APPROVAL TO PROCEED WITH APPROPRIATE FIELD CORRECTIONS. THIS WILL BE DONE IN A TIMELY MANNER. NOTE: IF THE BUILDER PROCEEDS WITH CORRECTIVE WORK WITHOUT CON BUILDINGS APPROVAL, THEY ARE DOING SO AT THEIR OWN RISK AND COST, CDN BUILDINGS WILL ONLY BE RESPONSIBLE FOR CLAIMS WHERE THE BUILDER/CUSTOMER DOCUMENTS THE PROBLEM, IT'S CORRECTION, AND REASONABLE COSTS FOR THE REPAIR AND SUBMITS SAME FOR PAYMENT WITHIN 15 DAYS OF THE OCCURRENCE.

DRAWING DISCREPANCIES
IN THE CASE OF DISCREPANCIES BETWEEN CDN BUILDINGS DRAWINGS AND DETAILS VERSUS THE PLANS FOR OTHER TRADES, THE CDN BUILDINGS PLANS GOVERN (CISC CODE OF STANDARD PRACTICE)

THE CORRECTION OF MINOR MISALIGNMENTS BY THE USE OF DRIFT PINS TO DRAW THE COMPONENTS INTO LINE, SHIMMING, MODERATE AMOUNTS OF REAMING, CHIPPING, WELDING, OR CUTTING AND THE REPLACEMENT OF MINOR SHORTAGES OF MATERIAL ARE A NORMAL PART OF ERECTION AND ARE NOT SUBJECT TO CLAIM. (CISC CODE OF STANDARD PRACTICE)

ALL FIELD WELDING SHALL BE DONE AT THE DIRECTION OF A DESIGN PROFESSIONAL AND DONE IN ACCORDANCE WITH CWB REQUIREMENTS BY WELDERS QUALIFIED TO PERFORM THE APPLICABLE WELDING PROCEDURE. USE MINIMUM 70ksl ELECTRODES. FIELD INSPECTION IS NOT BY CDN BUILDINGS.

- DELIVERIES AND SHORTAGES

  A. UNLESS OTHERWISE SPECIFIED, TERMS SHALL BE F.O.B. CDN BUILDINGS POINT OF MANUFACTURE. IF TRANSPORTATION CHARGES ARE INCORPORATED IN THE PRICE QUOTED, SUCH CHARGES ARE FREIGHT PREPAID UNLESS OTHERWISE SPECIFIED.
- DELIVERY SHALL BE DEEMED TO OCCUR WHEN THE GOODS ARE SHIPPED FROM THE POINT OF MANUFACTURE
- CDN BUILDINGS IS AUTHORIZED TO SHIP INSTALLMENTS. IF FOR ANY REASON THE DELIVERY IS DELAYED BY THE PURCHASER, STORAGE OR DEMURRAGE COSTS WILL BE BORNE BY THE PURCHASER
- DELIVERY DATES ARE APPROXIMATE ONLY, AND ANY ESTIMATED DELIVERY SCHEDULE, IF STATED SHALL BE DETERMINED FROM THE DATE CDN BUILDINGS RECEIVED COMPLETE AND SATISFACTORY INFORMATION NECESSARY TO MANUFACTURE THE GOODS. CDN BUILDINGS SHALL NOT, HOWEVER, BE LIABLE FOR ANY DELAY IN DELIVERY CAUSED BY CONDITIONS BEYOND CDN BUILDINGS REASONABLE CONTROL. IN ADDITION, THERE MAY BE DELAYS IN DELIVERY OF GOODS NOT NORMALLY CARRIED BY CDN BUILDINGS. ANY SUCH CAUSES OF DELAY EVEN THOUGH EXISTING ON THE DATE OF ORDER OR ON THE DATE OF STARTING OF MANUFACTURE SHALL EXTEND THE TIME OF CDN BUILDINGS PERFORMANCE BY THE LENGTH OF DELAYS OCCASIONED THEREBY, INCLUDING DELAYS REASONABLY INCIDENT TO THE RESUMPTION OF NORMAL PROCEDURES
- UNDER NO CIRCUMSTANCES SHALL CDN BUILDINGS BE LIABLE FOR ANY INDIRECT OF CONSEQUENTIAL DAMAGES WHATSOEVER.
- CON BUILDINGS WILL ENDEAVOR TO DELIVER THE GOODS ON THE REQUIRED DELIVERY DATE. THE CDN BUILDINGS TRUCK IS NOT CONSIDERED LATE IF DELIVERIES ARE WITHIN ONE HOUR OF THE SCHEDULED DELIVERY DATE. IF THE SHIPMENT IS BY CONTRACT CARRIER (FOB DESTINATION) IT IS THE RESPONSIBILITY OF THE CUSTOMER TO FILE CLAIMS WITH THE CARRIER. CDN BUILDINGS CANNOT ASSUME AND LIABILITY FOR THE CLAIM.
- IN THE EVENT THAT ANY SERVICES ARE TO BE PERFORMED BY CDN BUILDINGS SHALL BE DELAYED BY MORE THAN THIRTY (30) DAYS ON ACCOUNT FACTORS BEYOND CDN BUILDINGS CONTROL. THEN UPON NOTICE FROM CDN BUILDINGS, PURCHASER SHALL PAY CDN BUILDINGS THE COST OF ALL WORK, SERVICES AND MATERIALS TO THE DATE OF SUCH NOTICE.
  THE PURCHASER SHALL BE RESPONSIBLE TO INSPECT ALL GOODS RECEIVED PURSUANT HERETO, IF
- THE PURCHASER IS OF THE VIEW THAT PART OF THE GOODS ARE DAMAGED PREVENTING USE OF SAME, SUCH GOODS SHALL BE NOTED AS DAMAGED AND THE CDN BUILDINGS PROJECT MANAGEMENT TEAM SHALL BE NOTIFIED IMMEDIATELY TO DETERMINE WHAT RECTIFICATION IN CDN BUILDINGS SOLE ABSOLUTE DISCRETION IS NECESSARY. CDN BUILDINGS SHALL NOT ACCEPT CLAIMS FOR DAMAGE AFTER LOADING AT THE CDN BUILDINGS PLANT OR CAUSED DURING TRANSIT, UNLOADING OR HANDLING AT THE JOBSITE. FURTHER, CDN BUILDINGS SHALL NOT ACCEPT CLAIMS FOR VIABLE SHORTAGES UNLESS CDN BUILDINGS IS NOTIFIED WITH IN 48 HOURS OF TAKING DELIVERY AND ONE COPY OF THE PACKING LIST. WITH SHORTAGES PROPERLY NOTED, IS RETURNED TO CDN BUILDINGS WITHIN THE SAID 48 HOURS. CDN BUILDINGS SHALL NOT ACCEPT CLAIMS FOR SHORTAGES THAT ARE NOT VISIBLE UNLESS CDN BUILDINGS WITHIN FIFTEEN (15) DAYS OF TAKING THE DELIVERY AND ONE COPY OF THE PACKING LIST. WITH STORAGES PROPERLY NOTED, IS RETURNED TO CDN BUILDINGS WITHIN THE SAID FIFTEEN (15) DAYS. CDN BUILDINGS SHALL NOT BE RESPONSIBLE FOR ANY COST, EXPENSE, OR DAMAGE OF ANY KIND ARISING FROM THE USE OD DAMAGED OR OTHERWISE DEFECTIVE GOODS. CDN BUILDINGS WILL NOT ACCEPT THE COST OD EQUIPMENT (RENTAL OR DEPRECIATION). SMALL TOOLS, SUPERVISION, OVERHEAD OR PROFIT SUBJECT TO ANY CLAIM, ANY CLAIM MUST BE APPROVED BY THE CDN BUILDINGS PROJECT MANAGEMENT TEAM.

BY ACCEPTANCE OF THE MATERIALS OR SERVICES, THE BUILDER AND/OR CUSTOMER AGREES TO CDN BUILDINGS TERMS & CONDITIONS. AT NO TIME IS IT ACCEPTABLE TO DEDUCT A BACK CHARGE OR SHORTAGE FROM AN INVOICE. EACH CLAIM WILL BE ADJUDICATED ON ITS ON MERIT AND SETTLED ACCORDINGLY.



523 James St. Delhi, ON N4B 2C2

Office: (519) 582-8222 Fax: (519) 582-2098

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No.	Description	Date
1	Presentation Pkg for Review	21/08/19
2	Structural Drg Pkg for Review	21/09/07
3	Issued for Review/Permit -	
4	As Built Drawings	-

## ALBRECHT, BRIAN

Structural Notes 1



SN1		
Project number	21-706	
Date	2021/09/07	
Drawn by	RP	
Checked by	LDO	
Scale		

MATERIAL SPECIFICATIONS	WATER A	THE IN THE A SECOND CONTRACT OF THE INSTANCE O
PART	MATERIAL	FINISH
WIDE FLANGE, ANGLE, CHANNEL	G40.21 350W, ASTM A992 GR50	GALVANIZED
HSS	G40.21 350W, CLASS B OR C	GALVANIZED
PLATE/FLATBAR	G40.21 380W, ASTM A653 SS GR55, ASTM A653 HSLAS GR55 CLASS 1 OR 2	GALVANIZED
WEB PLATE	G40.21 380W, ASTM A653 SS GR55, ASTM A653 HSLAS GR55 CLASS 1 OR 2	GALVANIZED
COLD FORMED ZEE & CEE	G40.21 380W, ASTM A653 SS GR55, ASTM A653 HSLAS GR55 CLASS 1 OR 2	GALVANIZED
	ASTM A101 SS GR55, ASTM A101 HSLAS GR55 CLASS 1 OR 2	
COLD FORMED NOTCHED ZEE & HAT/CHAIR	G40.21 380W, ASTM A653 SS GR55, ASTM A653 HSLAS GR55 CLASS 1 OR 2	Z275(G90) PRE-GALV
STAND-OFF, PURLIN STABILIZER, FLANGE BRACE	ASTM A101 SS GR55, ASTM A101 HSLAS GR55 CLASS 1 OR 2	GALVANIZED
ROD BRACING	G40.21 350W, ASTM A529 GR50, ASTM A572 GR50	GALVANIZED
CABLE BRACING	ASTM A475 EHS 7 WIRE	CLASS A ZINC COATING
HIGH STRENGTH BOLTS < 1-1/2"	ASTM A325 type 1, ASTM A490 type 1	GALVANIZED
HIGH STRENGTH BOLTS > 1-1/2"	ASTM A354, GRADE BD	GALVANIZED
SECONDARY STRUCTURAL MEMBER BOLTS	SAE JS29, GRADE 8,2	JS500
ANCHOR RODS	G40.21 350W, ASTM A529 GR50 ASTM A572 GR50	GALVANIZED
EYE BOLTS	1030 CARBON STEEL	HOT DIP GALVANIZED
HILLSIDE/SLOPED WASHER	A47	GALVANIZED A153
BRACER HILLSIDE WASHER	ASTM A536 GR65	GREY ENAMEL
RTL PANEL	ASTM A792 SS GR50 CLASS 1 OR 4	AZ50 / AZM150 FOR PAINTED GALVALUME
HEX BOLT ASSEMBLIES	GRADE 5 STEEL	GALVANIZED
		AZ55 / AZM165 FOR BARE GALVALUME
SELF TAPPING SCREWS (TEK 3)	GRADE 2 STEEL	ZINC COAT
DIAMOND RIB 36 SHEET METAL PANEL	26 - 29 GA STRUCTURAL GRADE 80 STEEL ASTM 972	SMP STEEL-PAINT SYSTEM
TUFF RIB SHEET METAL PANEL	26 - 29 GA STRUCTURAL GRADE 80 STEEL ASTM 972	SMP STEEL-PAINT SYSTEM

STEEL FINISH
ALL STRUCTURAL MEMBERS OF THE STEEL BUILDING SYSTEM TO BE HOT DIP GALVANIZED TO ASTM A123 AND FASTENERS TO ASTM A153.

COLD FORMED ZEE/CEE MEMBER SIZES

DESIGN EXAMPLES: 08Z16; WHERE 08=SECTION DEPTH, Z=ZEE SECTION 16=16GA 10C12; WHERE 10=SECTION DEPTH, C=CEE SECTION, 12=12GA

PART	DEPTH	FLANGE WIDTH	LIP LENGTH	LIP ANGLE
06Z	6(152)	2.50(64)	0.95(24)	45
08Z	8(203)	2.80(71)	1.08(27)	45
09Z	09(229)	2.88(73)	1.08(27)	45
10Z	10(254)	3.02(77)	1.18(30)	45
12Z	12(305)	3.14(80)	1.18(30)	45
14Z	14(356)	3.14(80)	1.18(30)	45
06C	6(152)	2.26(57)	0.94(24)	90
08C	8(203)	2.94(75)	0.94(24)	90
09C	09(229)	3.08(78)	0.94(24)	90
10C	10(254)	3.26(83)	0.94(24)	90
12C	12(305)	3.38(86)	0.94(24)	90
14C	14(356)	3.50(80)	0.94(24)	90

DAMAGE TO MATERIAL FINISHES
MINOR ABRASIONS TO GALVANIZED FINISH, CAUSED BY HANDLING, LOADING, SHIPPING, UNLOADING AND ERECTION; ARE UNAVOIDABLE, AND ARE NOT SUBJECT TO CLAIM, TOUCH UP OF THESE MINOR ABRASIONS IS THE RESPONSIBILITY OF THE ERECTOR AND/OR THE END

GENERAL NOTES

1. INFORMATION ON THIS DRAWING IS INTENDED FOR CONSTRUCTION ONLY WHEN BEARING A CDN BUILDINGS ENGINEERS SIGNED

PROFESSIONAL SEAL AND WHEN FREE OF ANY NOTATIONS STATING OTHERWISE.
FOUNDATION DESIGN AND CONSTRUCTION IS NOT THE RESPONSIBILITY OF CDN BUILDINGS.

THE EMBEDMENT OF THE ANCHOR BOLTS IN THE CONCRETE IS THE RESPONSIBILITY OF THE FOUNDATION DESIGNER. THE FRAME

REACTIONS LISTED ARE THE MINIMUM LOADS TO BE DEVELOPED
THE BUILDING REACTION DATA REPORTS THE LOAD WHICH THIS BUILDING PLACES ON THE FOUNDATIONS

THE ENDWALL WIND LOAD REACTIONS INCLUDE REACTION FROM ENDWALL BRACING
COLUMN BASE PLATES ARE DESIGNED ASSUMING A MINIMUM SPECIFIED COMPRESSIVE STRENGTH (fc') OF CONCRETE OD 2,900 P.S.1 (20MPA) AT 28 DAYS.

ANCHOR BOLT DIAMETER, QUANTITY AND PLACEMENT SHOULD BE AS SHOWN ANCHOR BOLTS ARE TO BE ASTM A307 OR EQUAL ALL REACTIONS ARE IN KIPS OR KIP-FEET

MAXIMUM FRAME REACTIONS INCLUDE WIND AND SEISMIC REACTION FROM SIDEWALL BRACING. SEISMIC REACTION HAVE NOT BEEN AMPLIFIED BY Rd. Ro

FOUNDATION IS DESIGNED WITH THE ASSUMPTION THAT THE SOIL BEARING CAPACITY IS 3000 psf.

GEOTECHNICAL SOIL REPORT TO OTHERWISE STATE SOIL BEARING CAPACITY.

BASE LOAD DEFINITIONS FOR RIGID FRAMES

DEAD - SELFWEIGHT OF THE BUILDING SYSTEM.

COLLATERAL - MECHANICAL, ELECTRICAL, CEILINGS, SPRINKLER, ETC. ROOF\_LIVE - MINIMUM ROOF LIVE LOAD (NOT COMBINED WITH SNOW LOAD). FLOOR LIVE – LOADS INDUCED DUE TO INTENDED USE AND OCCUPANCY. CRANE – LOADS INDUCED FROM CRANES IN THE BUILDING. SNOW - GRAVITY LOADS DUE TO SNOW

WIND\_LEFT1 - WIND FROM THE LEFT TO RIGHT COMBINED WITH POSITIVE INTERNAL PRESSURE.
WIND\_RIGHT1 - WIND FROM THE RIGHT TO LEFT COMBINED WITH POSITIVE INTERNAL PRESSURE.
WIND\_LEFT2 - WIND FROM THE LEFT TO RIGHT COMBINED WITH NEGATIVE INTERNAL PRESSURE. WIND RIGHT2 - WIND FROM THE RIGHT TO LEFT COMBINED WITH NEGATIVE INTERNAL PRESSURE WIND\_LONG1 - WIND FROM NORMAL TO THE RIGID FRAME COMBINED WITH POSITIVE INTERNAL PRESSURE. WIND\_LONG2 - WIND DIRECTION REVERSED FROM LNWIND\_1COMBINDED WITH POSITIVE INTERNAL PRESSURE. SEISMIC LEFT - SEISMIC FORCE IN DIRECTION FROM LEFT TO RIGHT.

SEISMIC\_RIGHT - SEISMIC FORCE IN FREIGHT FROM RIGHT TO LEFT.

SEISMIC\_LONG - SEISMIC FORCE NORMAL TO THE RIGID FRAME.
FIUNB\_SL\_L - GRAVITY LOADS DUE TO PATTERNED SNOW LOAD FOR RAFTER DESIGN.
FIUNB\_SL\_R - GRAVITY LOADS DUE TO PATTERNED SNOW LOAD FOR RAFTER DESIGN
FIPAT\_SL - GRAVITY LOADS DUE TO UNBALANCED SNOW LOAD.

#### BASIC LOAD DEFINITIONS FOR ENDWALL FRAMES

DEAD - SELFWEIGHT OF THE BUILDING SYSTEM.
COLLATERAL - MECHANICAL, ELECTRICAL, CEILINGS, SPRINKLER, ETC. ROOF LIVE - MINIMUM ROOF LIVE LOAD (NOT COMBINED WITH SNOW LOAD).
FLOOR LIVE - LOADS INDUCED DUE TO INTENDED USE AND OCCUPANCY.
CRANE - LOADS INDUCED FROM CRANES IN THE BUILDING.

SNOW - GRAVITY LOADS DUE TO SNOW SNOW - GRAVITY LOADS DUE TO SNOW
WIND\_LEFT1 - WIND FROM THE LEFT TO RIGHT COMBINED WITH POSITIVE INTERNAL PRESSURE (RAFTER).
WIND\_RIGHT1 - WIND FROM THE RIGHT TO LEFT COMBINED WITH POSITIVE INTERNAL PRESSURE (RAFTER). WIND\_LEFT2 - WIND FROM THE LEFT TO RIGHT COMBINED WITH POSITIVE INTERNAL PRESSURE (WITH BRACING).
WIND RIGHT2 - WIND FROM THE RIGHT TO LEFT COMBINED WITH POSITIVE INTERNAL PRESSURE (WITH BRACING). WIND\_P - WIND PRESSURE(NORMAL (INWARD) TO ENDWALL).

WIND\_S - WIND SUCTION (NORMAL (OUTWARD) TO ENDWALL).
WIND LONG1 - WIND FROM NORMAL TO THE RIGID FRAME COMBINED WITH POSITIVE INTERNAL PRESSURE.

WIND\_LONG2 - WIND DIRECTION REVERSED FROM LNWIND\_ICOMBINDED WITH POSITIVE INTERNAL PRESSURE.
SEISMIC\_LEFT - SEISMIC FORCE IN DIRECTION FROM LEFT TO RIGHT.
SEISMIC\_RIGHT - SEISMIC FORCE IN FREIGHT FROM RIGHT TO LEFT.

SEISMIC\_LONG – SEISMIC FORCE NORMAL TO THE RIGID FRAME.
FIUNB\_SL\_L – GRAVITY LOADS DUE TO PATTERNED SNOW LOAD FOR RAFTER DESIGN.
FIUNB\_SL\_R – GRAVITY LOADS DUE TO PATTERNED SNOW LOAD FOR RAFTER DESIGN

FIPAT\_SL - GRAVITY LOADS DUE TO UNBALANCED SNOW LOAD.

# **CDN**BUILDINGS

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4	As Built Drawings	-
		-

#### Structural Notes 2

#### ALBRECHT, BRIAN

293 TOWNLINE ST. ST WILLIAMS ON NOE 1P0




#### SN<sub>2</sub>

Project number	21-706
Date	2021/09/07
Drawn by	RP
Checked by	LDO
Scale	


#### **CONTEXT MAP**

Geographic Township of SOUTH WALSINGHAM

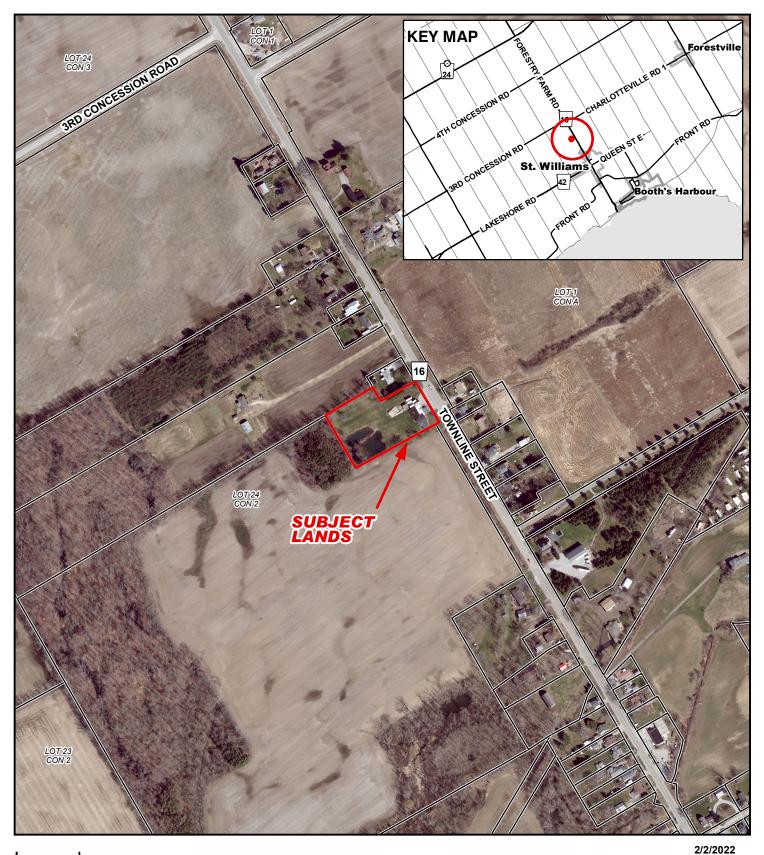

#### Legend




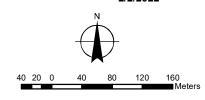

#### MAP B

#### **ZONING BY-LAW MAP**

Geographic Township of SOUTH WALSINGHAM

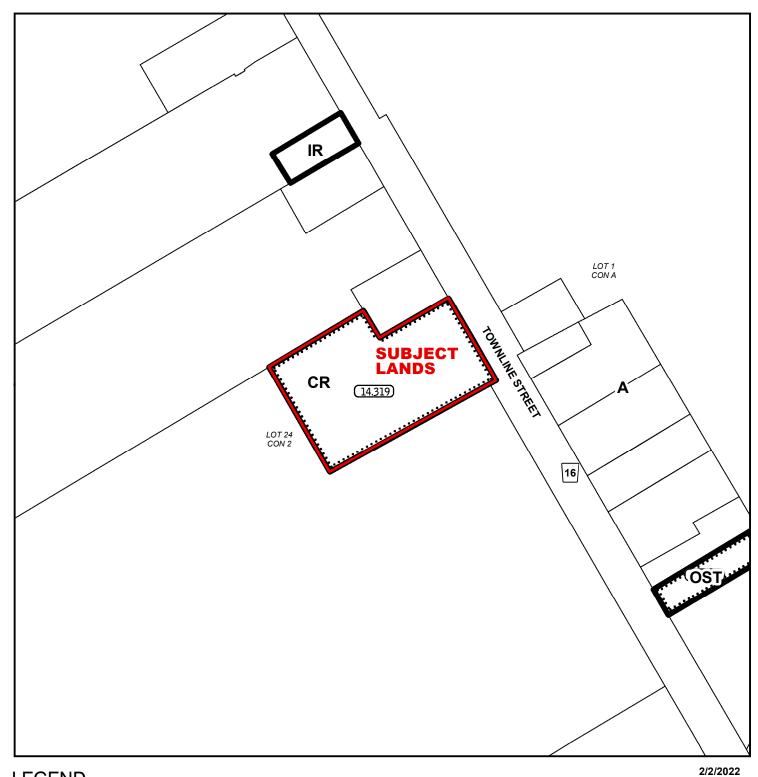

**LEGEND** 

Subject Lands

ZONING BY-LAW 1-Z-2014


(H) - Holding

A - Agricultural Zone

CR - Rural Commercial Zone


OST - Open Space Tent & Trailer Zone

IR - Rural Institutional Zone

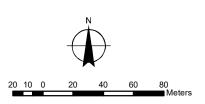



#### **CONCEPTUAL PLAN**

Geographic Township of SOUTH WALSINGHAM

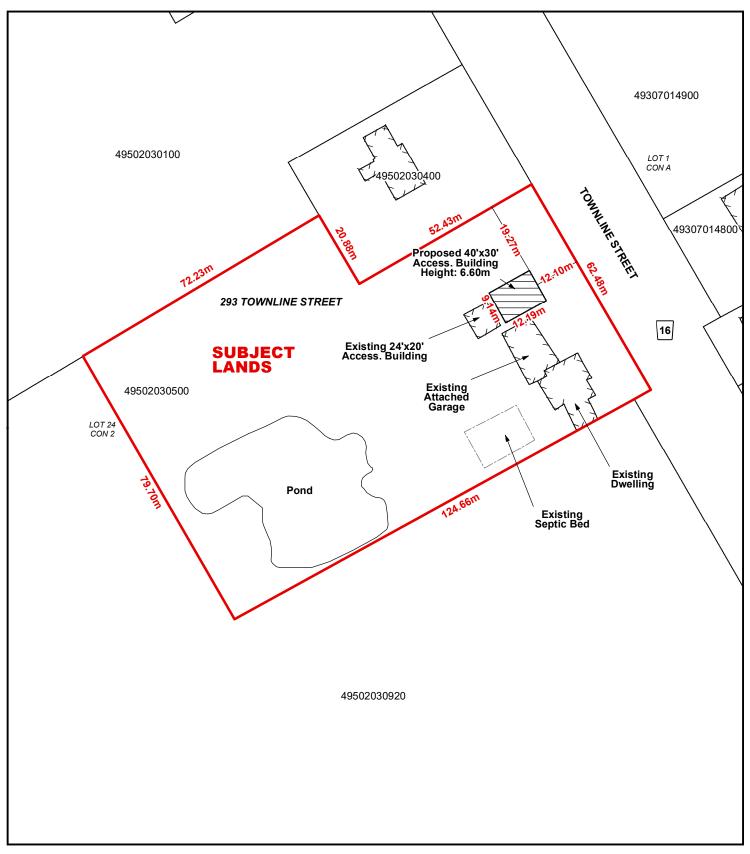




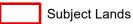

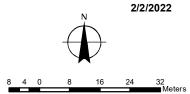

#### **CONCEPTUAL PLAN**

Geographic Township of SOUTH WALSINGHAM

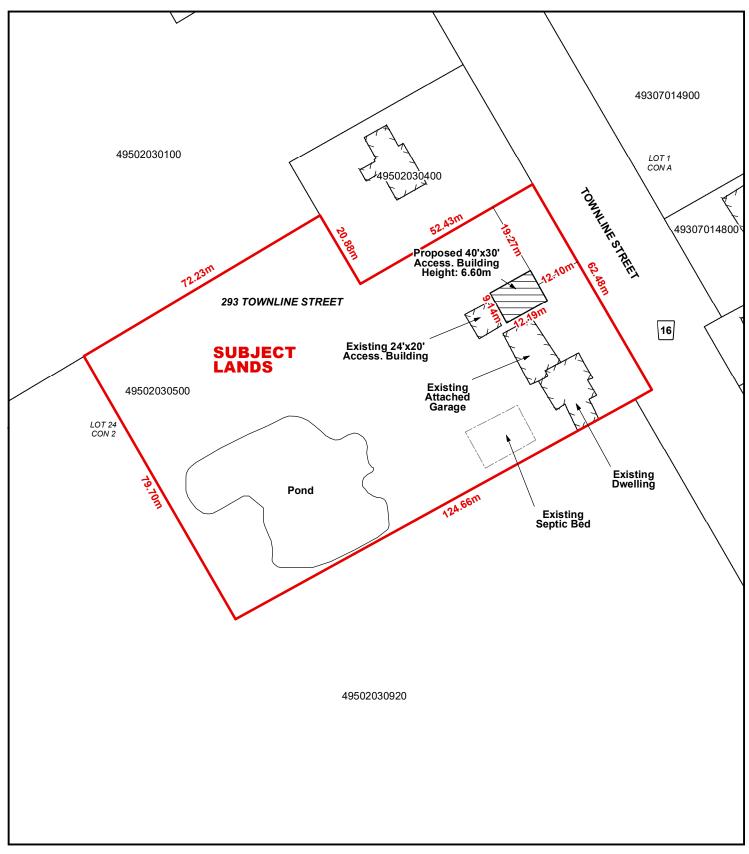

Legend

