For Office Use Only: File Number Related File Number	NPL2022152	Application Fee Conservation Authority Fee	Required Required
Pre-consultation Meeting Application Submitted results	mit - May 9 2022 y 27 2022	Well & Septic Info Provided Planner Public Notice Sign	New system to be constructed Jen
Check the type of plann	ing application(s) you are submitting.	
☐ Consent/Severance/E☐ Surplus Farm Dwellin☐ Minor Variance☐ Easement/Right-of-W	ng Severance and 2	ent Zoning By-law Amendme	nt
Property Assessment R	toll Number:	4931001	8800
A. Applicant Information	on	. 44	11
Name of Owner	Wayne	+ Mandy	Mawhiney
It is the responsibility of the ownership within 30 days	he owner or applica	ant to notify the planner o	
Address	105	Ordhance D	1r. (Lot 48)
Town and Postal Code	Turker	Point NOB	ELWO
Phone Number)	
Cell Number			
Email			
		, II	
Name of Applicant	1200	monet Home	5
Address	30	o3 treland	Rd.
Town and Postal Code	30	moe N3Y	154
Phone Number		19) 426-	7186
Cell Number			
Email			



Na			
1467	me of Agent		
Ad	dress		
To	wn and Postal Code		
Ph	one Number		
Се	ll Number		
En	nail	-	
all		notices in respect of	should be sent. Unless otherwise directed this application will be forwarded to the
	Owner	☐ Agent	☐ Applicant
B. 1.	Location, Legal De	scription and Prop	erty Information
			wnship, Concession Number, Lot Number
	Block Number and Ur	ban Area or Hamlet	wnship, Concession Number, Lot Number):
	Block Number and Ur	ban Area or Hamlet	wnship, Concession Number, Lot Number): ろ しいしせる
	Block Number and Ur	ban Area or Hamlet; PLAN 13 Urkey Po	wnship, Concession Number, Lot Number): ろ しいしせる
	Block Number and Ur	PLAN 13 LIKES Posess: 10	wnship, Concession Number, Lot Number): 3 ムひ せる
	Block Number and Ur CHR Municipal Civic Addre Present Official Plan	ban Area or Hamlet; PLAN [3] LAKES Posess:	wnship, Concession Number, Lot Number): 3 ムひ せる
	Block Number and Ur CHR Municipal Civic Addre Present Official Plan I Present Zoning:	ban Area or Hamlet, PLAN 13 LIKES Po- ess: 10 Designation(s):	wnship, Concession Number, Lot Number): 3 Lot UE -nt -ordnance Ave
	Block Number and Ur CHR Municipal Civic Addre Present Official Plan I Present Zoning:	ban Area or Hamlet; PLAN 13 LIKES Po- ess: 10 Designation(s): Vision or site specific	wnship, Concession Number, Lot Number 3 Lot UB -nt 5 Ordnance Ave. Residential



	Please describe all existing buildings or structures on the subject lands and whether they are to be retained, demolished or removed. If retaining the buildings or structures, please describe the type of buildings or structures, and illustrate the setback, in metric units, from front, rear and side lot lines, ground floor area, gross floor area, lot coverage, number of storeys, width, length, and height on your attached sketch which must be included with your application: Section Decline Decline Cetained Section Secti	~ ~ ~	plan)
	If an addition to an existing building is being proposed, please explain what it will be used for (for example a bedroom, kitchen, or bathroom). If new fixtures are proposed, please describe.		
	Please describe all proposed buildings or structures/additions on the subject lands. Describe the type of buildings or structures/additions, and illustrate the setback, in metric units, from front, rear and side lot lines, ground floor area, gross floor area, lot coverage, number of storeys, width, length, and height on your attached sketch which must be included with your application:	ro.	and)
7.	Are any existing buildings on the subject lands designated under the <i>Ontario</i> Heritage Act as being architecturally and/or historically significant? Yes No		
	If yes, identify and provide details of the building: ———————————————————————————————————		
8.	If known, the length of time the existing uses have continued on the subject lands:		
9.			
	Residential Use		
10	Are there any easements or restrictive covenants affecting the subject lands?		
	WYes □ No If yes, describe the easement or restrictive covenant and its effect: There is an easement p right of way (See Site p(an) As per Instrument NRS Revised October 2021	557	245
	Committee of Adjustment Development Application Page 3 of 13		

C. Purpose of Development Application

Note: Please complete all that apply. Failure to complete this section will result in an incomplete application.

1. Site Information (Please refer to Zoning By-law to confirm permitted dimensions)

	Existing	Permitted	Provision	Proposed	Deficiency
Lot frontage		15m	5,8,291)		
Lot depth	70.1m (230'-0")	NIA	NIA	2301-01	None
Lot width	10:973m (36'-0")	NIA	NIA	36'-0"	None
Lot area	768.6m² 8,273 sqf	1	5.8.2 a)	768.6m 8,273 sq.f	1. None
Lot coverage	20.3%	15%	5.8.2 h)	23.82%	8,82%
Front yard	7.44m	iom	5,8,2 C)	2,02m	3.98m
Rear yard	50m (166'-3")	9m	2.815 t)	(50-01) (45.7m)	None
Height	un known	9.1m	5.8.2 (9)	(291-5") 8.9m	None
Left Interior side yard	1.55m (5'-0")	1.2m	5.8.2 e);)	(4.63')	None
Right Interior side yard	0.84m (21-911)	l.Zm	5.8.2	1.33m (4.36')	None
Exterior side yard (corner lot)					
Parking Spaces (number)	5	-		2	
Aisle width	NIA	NIA	NIA	NIA	NIA
Stall size	NA	NIA	NIA	NIA	NIA
Loading Spaces	NIA	NIA	NIA	NIA	NIA
Other					



2.	Please explain why it is not possible to comply with the provision(s) of the Zoning
	By-law:
	Set back to 15% but Coverage for
	the cottage.
	The coffage.
3.	Consent/Severance/Boundary Adjustment: Description of land intended to be
	severed in metric units:
	Frontage:
	Depth:
	Width:
	Lot Area:
	Present Use:
	Proposed Use:
	Proposed final lot size (if boundary adjustment):
	If a boundary adjustment, identify the assessment roll number and property owner of
	the lands to which the parcel will be added:
	Description of land intended to be retained in metric units:
	Frontage:
	Depth:
	Width:
	Lot Area:
	Present Use:
	Proposed Use:
	Buildings on retained land:
4.	Easement/Right-of-Way: Description of proposed right-of-way/easement in metric
	units:
	Frontage:
	Depth:



Width:	
Area:	
Proposed Use:	
	velling Severances Only: List all properties in Norfolk County,
which are owned a	and farmed by the applicant and involved in the farm operation
Owners Name.	
Roll Number:	
Total Acreage: \	
Workable Acreage: $ackslash$	
Existing Farm Type:	(for example: corn, orchard, livestock)
Dwelling Present?:	□ Ves □ No If yes, year dwelling built
Date of Land Purchas	se:
Owners Name:	
Roll Number:	
Total Acreage:	
Workable Acreage:	
Existing Farm Type:	(for example: corn, orchard, livestock)
Dwelling Present?:	□ Yes □ No If yes, year dwelling built
Date of Land Purchas	se:
Owners Name:	
Roll Number:	
Total Acreage:	
Workable Acreage:	
Existing Farm Type:	(for example: corn, orchard, livestock)
Dwelling Present?:	☐ Yes ☐ No If yes, year dwelling built
Date of Land Purchas	se:



Qwners Name:	
Roll Number:	
Total Acreage:	
Workable Acreage:	
Existing Farm Type:	(for example: corn, orchard, livestock)
Dwelling Present?:	☐ Yes ☐ No If yes, year dwelling built
Date of Land Purcha	se:
Owners Name:	
Roll Number:	
Total Acreage:	
Workable Acreage:	
Existing Farm Type:	(for example: corn, orchard, livestock)
Dwelling Present?:	☐ Yes ☐ No If yes, year dwelling built
Date of Land Purcha	ase:
Note: If additional	space is needed please attach a separate sheet.
D. All Applications	: Previous Use of the Property
	an industrial or commercial use on the subject lands or adjacent
	No Unknown
If yes, specify the	e uses (for example: gas station, or petroleum storage):
	o believe the subject lands may have been contaminated by former or adjacent sites?□ Yes ☑ No □ Unknown
3. Provide the inform	mation you used to determine the answers to the above questions:
pers	sonal knowledge
1	



4.	. If you answered yes to any of the above questions in Section D, a previous use inventory showing all known former uses of the subject lands, or if appropriate, the adjacent lands, is needed. Is the previous use inventory attached? ☐ Yes ☐ No						
E.	E. All Applications: Provincial Policy						
1.	Is the requested amendment consistent with the provincial policy statements issued under subsection 3(1) of the <i>Planning Act, R.S.O. 1990, c. P. 13</i> ? ☐ Yes ☐ No						
	If no, please explain:						
2.	It is owner's responsibility to be aware of and comply with all relevant federal or provincial legislation, municipal by-laws or other agency approvals, including the Endangered Species Act, 2007. Have the subject lands been screened to ensure that development or site alteration will not have any impact on the habitat for endangered or threatened species further to the provincial policy statement subsection 2.1.7? Yes No						
	If no, please explain:						
3.	Have the subject lands been screened to ensure that development or site alteration will not have any impact on source water protection? ☐ Yes ☐ No						
	If no, please explain:						
	Note: If in an area of source water Wellhead Protection Area (WHPA) A, B or C please attach relevant information and approved mitigation measures from the Risk Manager Official.						



4.	All Applications: Are any of the following uses or features on the subject lands or within 500 metres of the subject lands, unless otherwise specified? Please check boxes, if applicable.
	Livestock facility or stockyard (submit MDS Calculation with application)
	☐ On the subject lands or ☐ within 500 meters – distance
	Wooded area □ On the subject lands or □ within 500 meters – distance
	Municipal Landfill ☐ On the subject lands or ☐ within 500 meters – distance
	Sewage treatment plant or waste stabilization plant ☐ On the subject lands or ☐ within 500 meters – distance
	Provincially significant wetland (class 1, 2 or 3) or other environmental feature ☐ On the subject lands or ☑ within 500 meters – distance
	Floodplain ☑ On the subject lands or ☐ within 500 meters – distance
	Rehabilitated mine site ☐ On the subject lands or ☐ within 500 meters – distance
	Non-operating mine site within one kilometre ☐ On the subject lands or ☐ within 500 meters – distance
	Active mine site within one kilometre ☐ On the subject lands or ☐ within 500 meters – distance
	Industrial or commercial use (specify the use(s)) ☐ On the subject lands or ☐ within 500 meters – distance
	Active railway line ☐ On the subject lands or ☐ within 500 meters – distance
	Seesonal wetness of lands ☐ On the subject lands or ☐ within 500 meters – distance
	Erosion ☑ On the subject lands or □ within 500 meters – distance
	Abandoned gas wells ☐ On the subject lands or ☐ within 500 meters – distance



F.	All Applications: Servicing and Access			
1.	Indicate what services are available or proposed:			
	Water Supply			
			Communal wells	
	☐ Individual wells		Other (describe below)	
	Sewage Treatment			
			Communal system	
	☐ Septic tank and tile bed in good working order		Other (describe below)	
	Storm Drainage			
	☐ Storm sewers		Open ditches	
	☐ Other (describe below)			
2.	Existing or proposed access to subject lands:			
	Municipal road		Provincial highway	
	☐ Unopened road		Other (describe below)	
	Name of road/street:			
	105 ordnance Ave	<i>-</i> ~		
G.	All Applications: Other Information			
	Does the application involve a local business? □	Yes	s 🖾 No	
	If yes, how many people are employed on the sub			
	yee,eay people are empleyed en are eas	joot		
2.	Is there any other information that you think may be	seful in the review of this		
	application? If so, explain below or attach on a se	par	ate page.	
	There is an Exist	Fin	a Easement D	
	right of way for	n	eighbours to use	
	There is an Exist right of way for	92	access to their co	Hage



H. Supporting Material to be submitted by Applicant

In order for your application to be considered complete, folded hard copies (number of paper copies as directed by the planner) and an **electronic version (PDF) of the site plan drawings, additional plans, studies and reports** will be required, including but not limited to the following details:

- 1. Concept/Layout Plan
- 2. All measurements in metric
- 3. Existing and proposed easements and right of ways
- Parking space totals required and proposed
- 5. All dimensions of the subject lands
- 6. Dimensions and setbacks of all buildings and structures
- 7. Location and setbacks of septic system and well from all existing and proposed lot lines, and all existing and proposed structures
- 8. Names of adjacent streets
- 9. Natural features, watercourses and trees

In addition, the following additional plans, studies and reports, including but not limited to, may also be required as part of the complete application submission:

On-Site Sewage Disposal System Evaluation Form (to verify location and condition)

Environmental Impact Study

Geotechnical Study / Hydrogeological Review

Minimum Distance Separation Schedule

Record of Site Condition

Your development approval might also be dependent on Ministry of Environment Conservation and Parks, Ministry of Transportation or other relevant federal or provincial legislation, municipal by-laws or other agency approvals.

All final plans must include the owner's signature as well as the engineer's signature and seal.



acknowledges and agrees that it is their solicitor's responsibility on behalf of the owner for the registration of postponements of any charges in favour of the County.

Permission to Enter Subject Lands

Permission is hereby granted to Norfolk County officers, employees or agents, to enter the premises subject to this application for the purposes of making inspections associated with this application, during normal and reasonable working hours.

Freedom of Information

For the purposes of the Municipal Freedom of Information and Protection of Privacy Act, I authorize and consent to the use by or the disclosure to any person or public body any information that is collected under the authority of the Planning Act, R.S.O. 1990, c. P. 13 for the purposes of processing this application.

Owner/Applicant/Agent Signature

J. Owner's Authorization

If the applicant/agent is not the registered owner of the lands that is the subject of this application, the owner must complete the authorization set out below.

I/We **Julian Jayan Make Market** registered owner(s) of the lands that is the subject of this application.


I/We authorize for Butting horning of the to make this application on my/our behalf and to provide any of my/our personal information necessary for the processing of this application. Moreover, this shall be your good and sufficient authorization for so doing.

*Note: If property is owned by an Ontario Ltd. Corporation, Articles of Incorporation are required to be attached to the application.

Revised October 2021 Committee of Adjustment Development Application

K. Declaration	
solemnly declare that:	Alorfolk County, Mouhoe of Ontario
all of the above statements and the statements of transmitted herewith are true and I make this sol- believing it to be true and knowing that it is of the under oath and by virtue of <i>The Canada Evidend</i>	emn declaration conscientiously same force and effect as if made
Declared before me at: Norfolk County, Frontice	Owner/Applicant/Agent Signature
In the Province of Ontarb	Owner/Applicant/Agent Oignature
This 3rd day of March	
A.D., 20_22	
Mat ans	
A Commissioner, etc. Mathan A. Kolomaya	



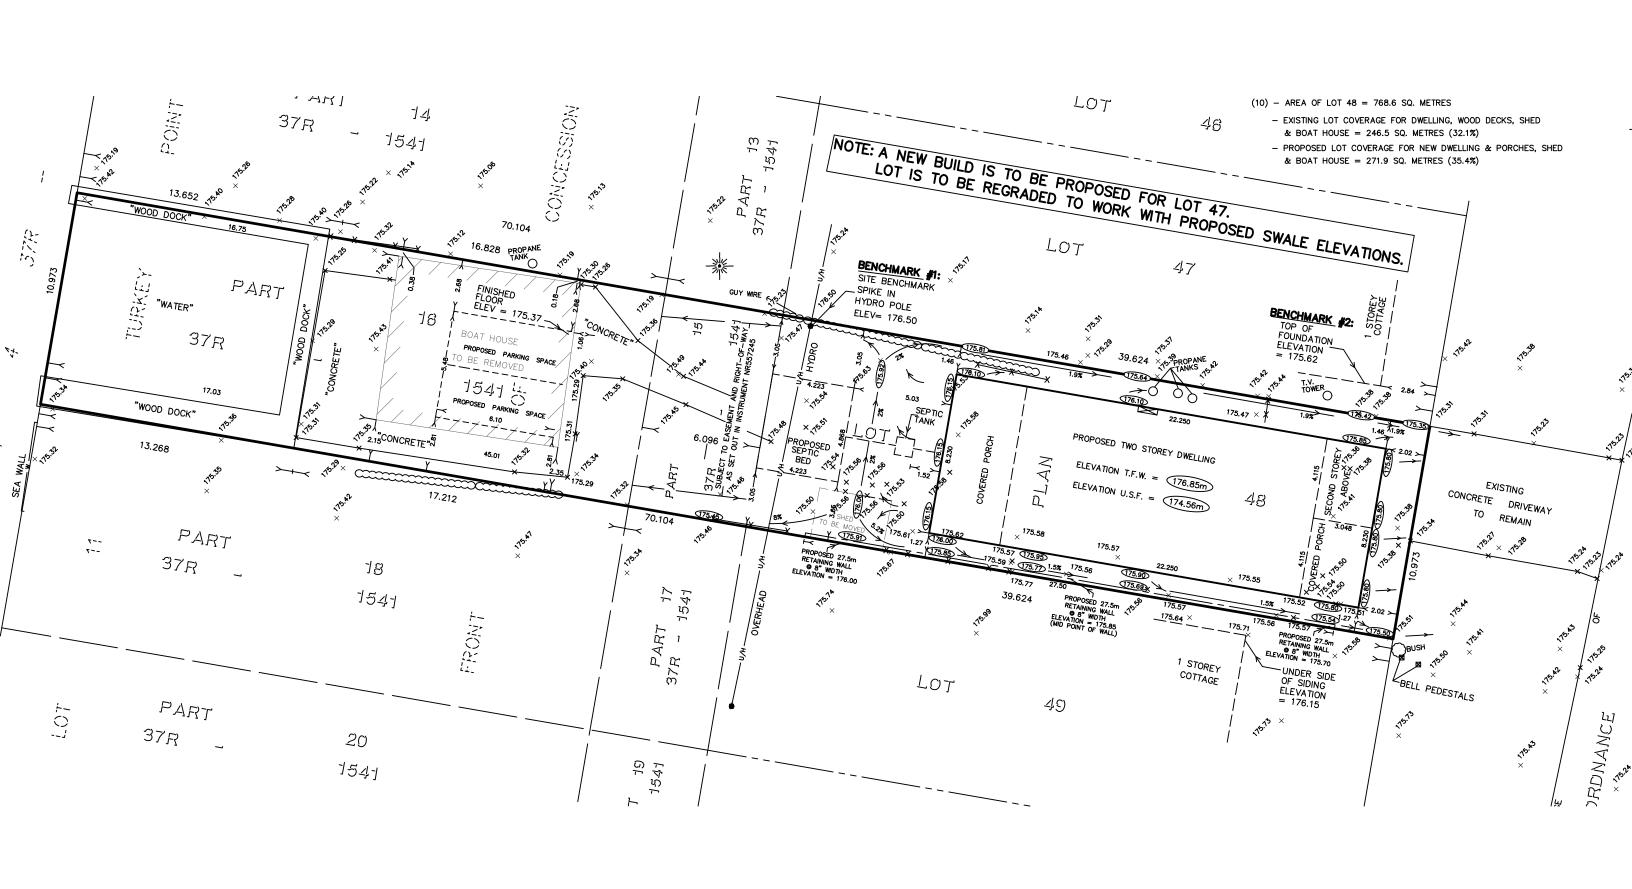





PROMINENT HOMES CUSTOM COTTAGE

105 Ordnance Ave, Turkey Point

PROMINENT HOMES COVER SHEET DRAWN BY SAM BUNTING BCIN #: 37074 DATE APRIL 8TH 2022 SCALE NT9 SHEET NO. APRIL 8TH 2022 SCALE NT9

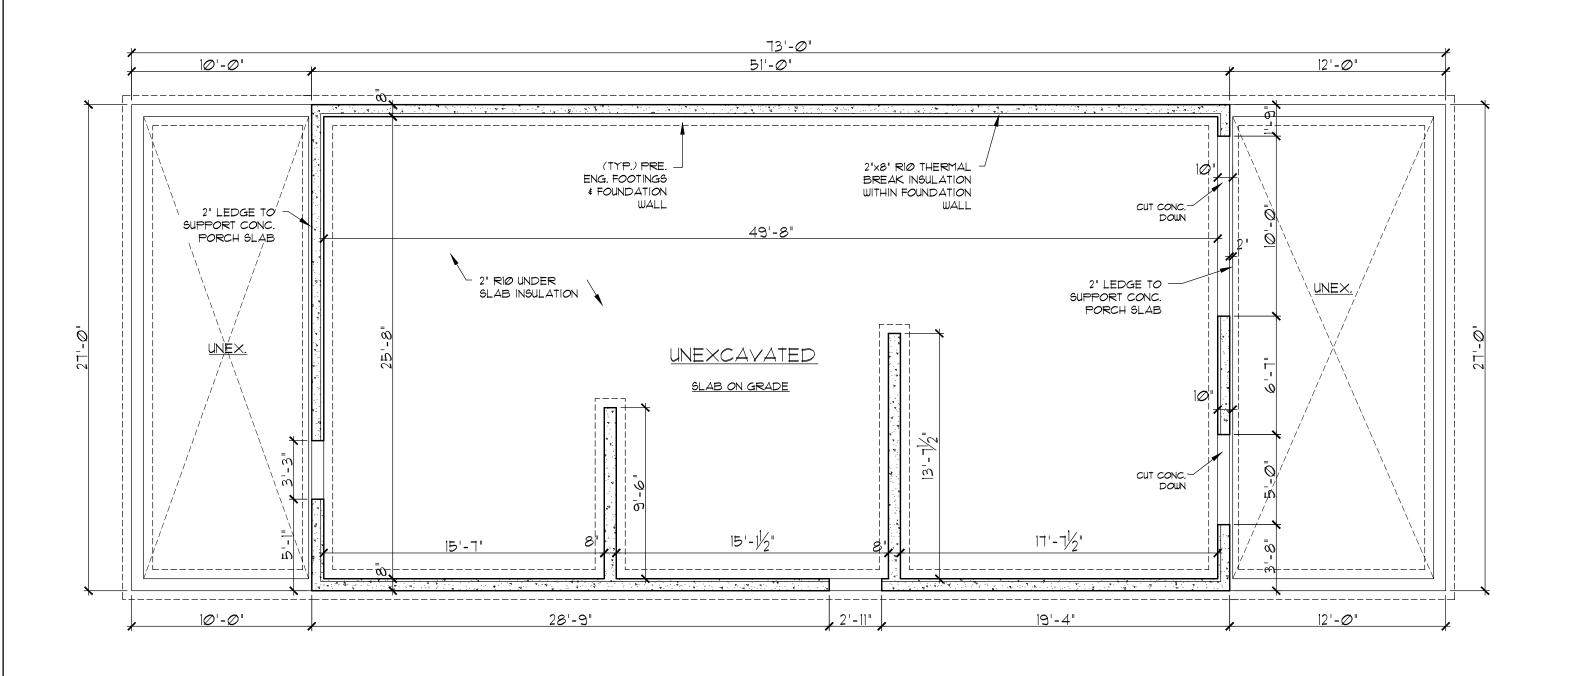


PROMINENT HOMES				
	BASET	MENT	PLAN	
ADDRESS	46 LAKESIDE DE	R. PEACOCK	(POINT	
DRAWN BY	SAM BUNTING	BCIN #:	37Ø74	SHEET No.
DATE	APRIL 8TH 2 <i>0</i> 22	SCALE	1/4" =1'-0"	<u></u>

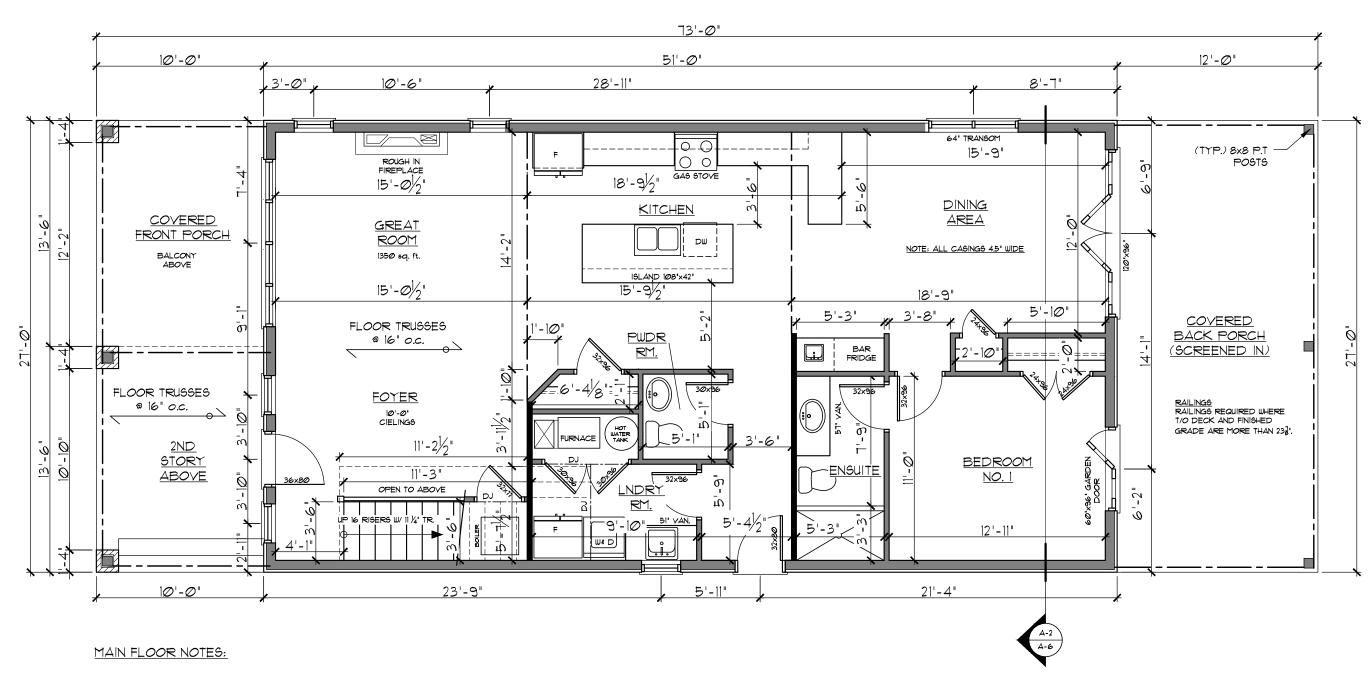


- 1. FLOOR TRUSSES ON MAIN FLOOR
- 2. WIDER CASING (4.5"x2")
- 3. NO SLIDERS
- 4. 32" DOORS 96" HIGH
- 5. 10' CIELING
- 6. GAS STOVE
- 1. CONDUIT PIPE UDER COTTAGE FOR FUTURE ACCESS
- 8. SERVICE FOR BOTH FRONT AND BACK YARD LIGHTING AND WATER TAPS


PROMINENT HOMES				
	ist FLC	DOR	PLANS	
ADDRESS	105 ORDNA	NCE AVE.	LOT 48	
DRAWN BY	SAM BUNTING	BCIN #:	37Ø74	SHEET No.
DATE	APRIL 8TH 2 <i>0</i> 22	SCALE	Y ₄ " =1'-0"	$\int A = 2$

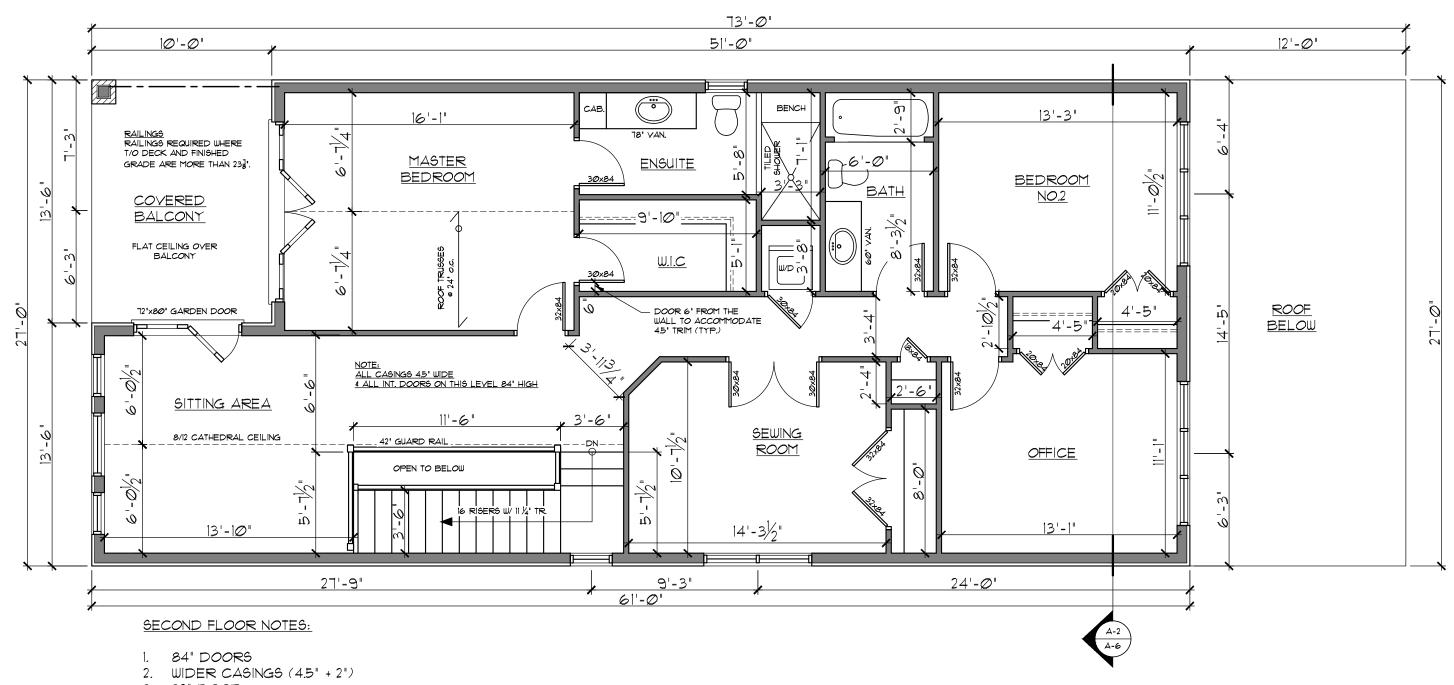

- 3. 32" DOOR
- 4. LIGHTS IN CLOSETS
- 5. 9' CIELINGS

PROMIN	VENT HOMES	
2nd FL	OOR PLANS	
ADDRESS 105 ORDNÁ	NCE AVE. LOT 48	
DRAWN BY SAM BUNTING	BCIN #: 37Ø74	SHEET No.
DATE APRIL 8TH 2022	SCALE	A = 3

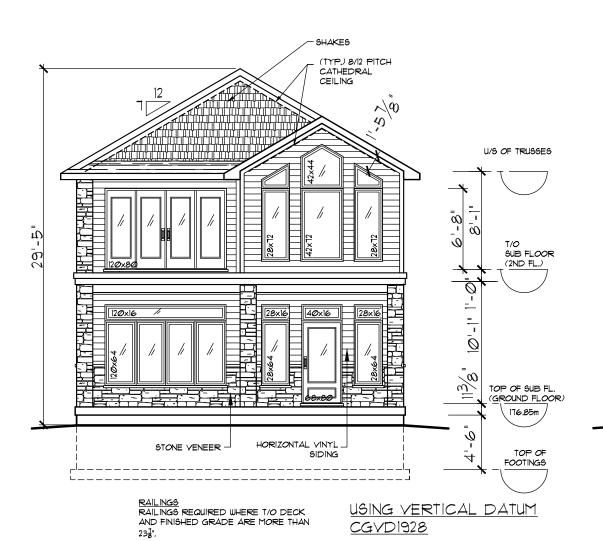

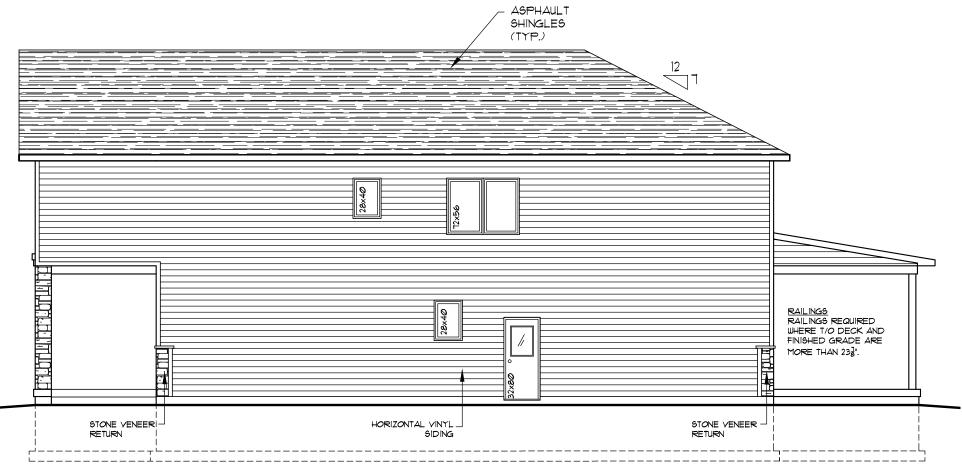

PROMINENT HOMES


FRONT & RIGHT SIDE ELEY.

SHEET No.


DRAWN BY GAM BUNTING BCIN #: 37074

SAM BUNTING 31074


E APRIL 8TH 2022 SCALE 1'-0"

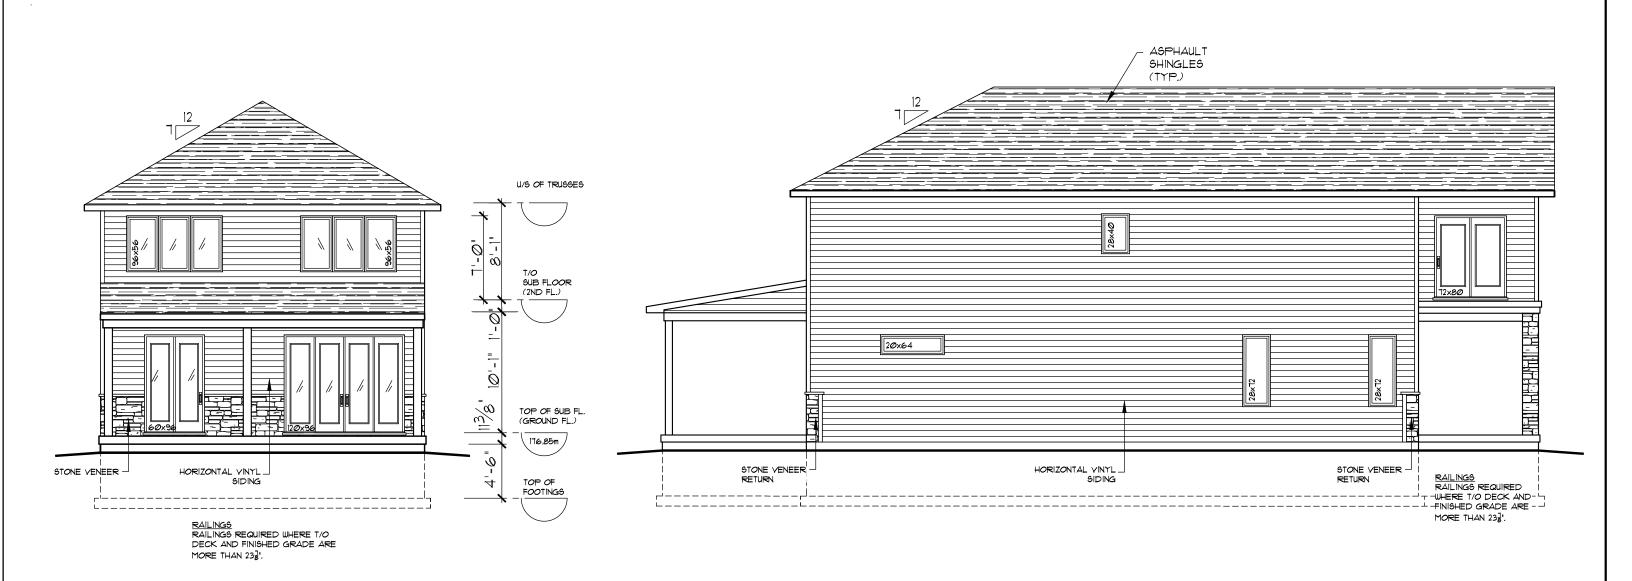

PROMINENT HOMES REAR & LEFT SIDE ELEV. ADDRESS 46 LAKESIDE DR. PEACOCK POINT DRAWN BY SAM BUNTING BCIN #: 31074 DATE APRIL 8TH 2022 SCALE 1/4" = 1'-0" SHEET No. A = 5

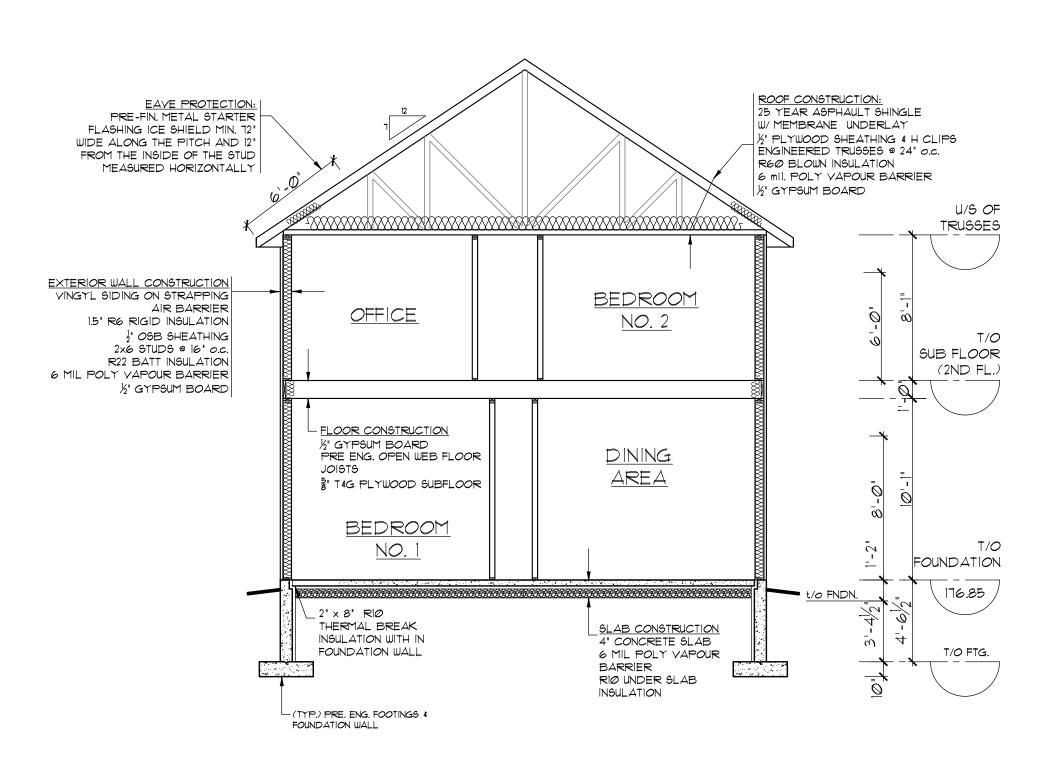

PROMIN	VENT HOMES	
BUILDI	NG SECTION	
ADDRESS 46 LAKESIDE DE	R PEACOCK POINT	
DRAWN BY SAM BUNTING	BCIN #: 37Ø74	SHEET No.
DATE APRIL 8TH 2 <i>0</i> 22	SCALE /2" =1'-0"	A-6

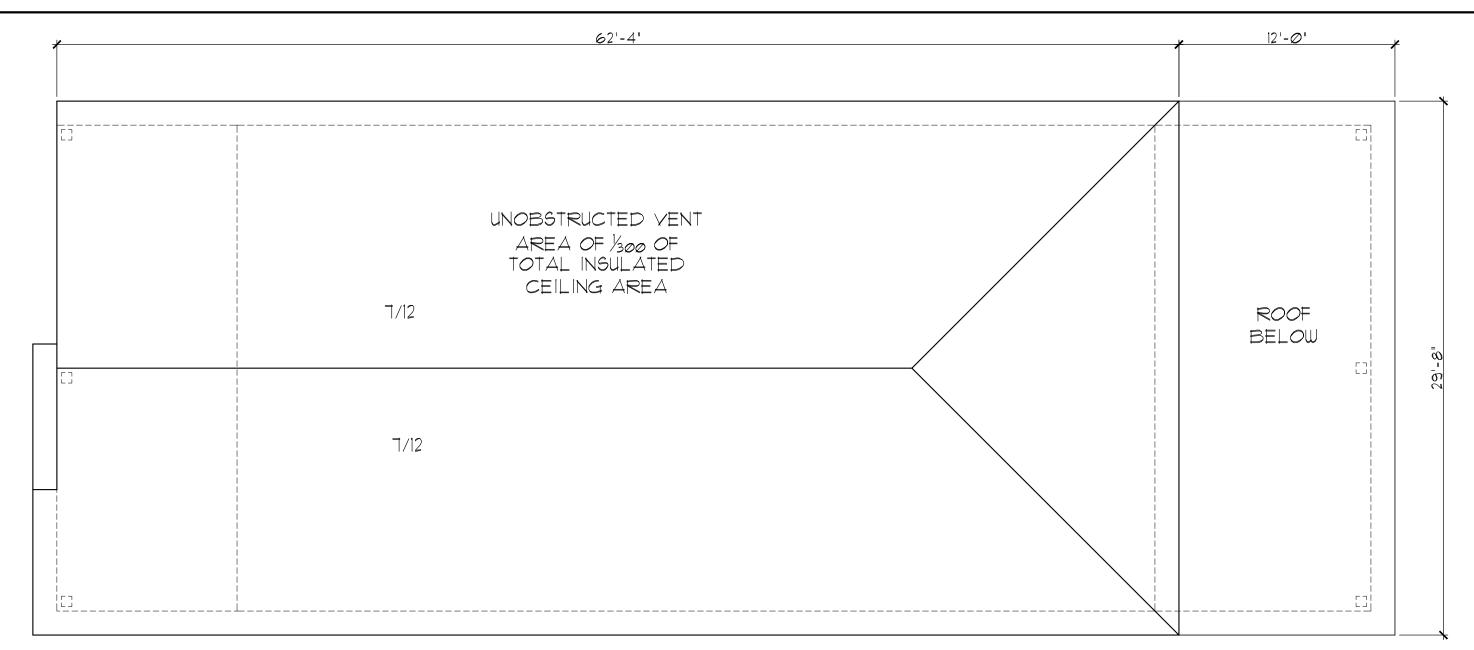

1'-4" OVER HANG UNLESS NOTED OTHERWISE

WOOD LINTEL SCHEDULE FORMING PART OF SENTENCE O.B.C. 9.23.12.3			
LINTEL SIZES (in)	MAXIMUM SPAN SUPPORTING ROOF (SSL - 1.5 kPA) AND CEILING ONLY (S-P-F No. 1 & 2)		
(11)	EXT. WALL	INT. WALL	
2 - 2×4	3'-7"	3'-Ø'	
2 - 2×6	5'-6"	4'-5"	
2 - 2×8	6'-7'	5'-4"	
2 - 2×10	8'-1"	6'-8"	
2 - 2×12	9'-5"	7'-8"	
SPANS ARE CALCULATED BASED ON MAX. SUPPORTED JOIST OR RAFTER LENGTH OF 16'-0" AND A MAX. SUPPORTED TRUSS LENGTH OF 32'-1'.			
ALL HEADERS SUPPORTING SPANS THAT EXCEED THE ALLOWED SPANS, ARE TO BE			

PRE-ENGINEERED LYL HEADERS

WOOD LINTEL SCHEDULE FORMING PART OF SENTENCE O.B.C. 9.23,12.3			
LINTEL SIZES	MAXIMUM SPAN SUPPORTING ROOF (SSL - 1.5 kPA) AND CEILING ON GABLE END ONLY (S-P-F NO. 1 & 2)		
	EXT. WALL	INT, WALL	
2 - 2×4	3'-T'	3'-Ø"	
2 - 2×6	5'-6"	4'-5"	
2 - 2×8	6'-7"	5'-4"	
2 - 2x1Ø	8'-1"	6'-8"	
2 - 2×12	9'-5"	7'-8"	
SPANS ARE CALCULATED FOR GABLE END WALLS THAT SUPPORT ONLY 2'-0" OF ROOF & CEILING, BUT DO NOT SUPPORT ROOF JOISTS,			

ROOF RAFTERS & ROOF TRUSSES

ALL HEADERS SUPPORTING SPANS THAT EXCEED THE ALLOWED SPANS, ARE TO BE PRE-ENGINEERED LYL HEADERS

PROMINENT HOMES					
ROO	OF PLAN				
ADDRESS 46 LAKESIDE DE	R PEACOCK POINT				
DRAWN BY SAM BUNTING	BCIN #: 37Ø74	SHEET No.			
DATE APRIL 8TH 2022	SCALE /4" =1'-0"				



Long Point Region Conservation Authority

PERMIT No. LPRCA-43/22

FOR DEVELOPMENT, INTERFERENCE WITH WETLANDS & ALTERATIONS TO SHORELINES & WATERCOURSES

(CONSERVATION AUTHORITIES ACT - ONTARIO REGULATION 178/06, UNDER O.REG.97/04)

4 Elm Street Tillsonburg, ON N4G 0C4 Phone (519) 842-4242 Fax (519) 842-7123 www.lprca.on.ca

Wayne & Mandy Mawhiney		Telephone:	519-871-6491
22 Colin Avenue		Postal Code:	N4G 0E5
Tillsonburg, ON			
Prominent Homes		Telephone: Postal Code:	519-426-9186 N3Y 4K4
363 Ireland Road			
Simcoe, ON			
rks: 105 Ordnance Avenue; 33	.10.493.100.1	8800	
Plan:	133	Municipality:	Norfolk County
Demolish the existing residential	structure and	construct a replace	ment 268 m ² residential structure and
septic system.			
	22 Colin Avenue Tillsonburg, ON Prominent Homes 363 Ireland Road Simcoe, ON rks: 105 Ordnance Avenue; 33 8 Plan: Demolish the existing residential	22 Colin Avenue Tillsonburg, ON Prominent Homes 363 Ireland Road Simcoe, ON rks: 105 Ordnance Avenue; 33.10.493.100.1 8 Plan: 133 Demolish the existing residential structure and	22 Colin Avenue Postal Code: Tillsonburg, ON Prominent Homes Telephone: 363 Ireland Road Postal Code: Simcoe, ON rks: 105 Ordnance Avenue; 33.10.493.100.18800 8 Plan: 133 Municipality: Demolish the existing residential structure and construct a replaced

This permit shall be subject to the following conditions:

The Applicant and owner, by acceptance of and in consideration of the issuance of this permit, agrees to the following conditions:

GENERAL CONDITIONS: (SEE REVERSE SIDE OF PERMIT)

SPECIFIC CONDITIONS:

1. Locations and dimensions of proposed works must be as indicated on the enclosed copy of the work permit application dated March 7, 2022 and the associated information.

DATE: March 14, 2022 to March 14, 2024

GENERAL CONDITIONS:

- 1. This permit does not preclude any approvals required by any other laws or regulations.
- 2. Temporary sediment & erosion control measures shall be installed around any disturbed and/or exposed ground or excavated material stockpiles, remain in place until the site has been suitably stabilized, and must be monitored regularly to ensure effectiveness. Remedial/Emergency measures must be taken at any sign of failure. This step is considered necessary to prevent the undesirable migration of silt.
- 3. The Conservation Authority should be contacted within 48 hours prior to the commencement of construction.
- 4. Authorized representatives of the Long Point Region Conservation Authority may at any time enter onto the lands which are described herein in order to make any surveys, examinations or inspections which are required for the purpose of insuring that the work(s) authorized by this permit are being carried out according to the terms of this permit.
- 5. It is the responsibility of the permittee to ensure the development is located within the extent of the property boundaries owned by the proponent.
- This permit is not assignable.
- 7. The project shall be carried out generally as per the plans submitted in support of the application as they may be amended by conditions of this permit.
- 8. This approval does not guarantee the soundness of the proposed work and it is the responsibility of the permittee to monitor and maintain the construction activity to ensure the integrity of the work.
- 9. The applicant agrees to maintain all existing drainage patterns.
- 10. Any activity or development other than that identified in this permit application must be reviewed by the LPRCA; at which time, staff will determine if additional approvals or an amended permit will be required.
- 11. Permits are valid for two years. No notice will be issued on expiration of the permit and it is the responsibility of the permittee to ensure a valid permit is in effect at the time work is occurring.

Permit Application – Schedule A REGULATION OF DEVELOPMENT, INTERFERENCE WITH WETLANDS AND ALTERATIONS TO SHORELINES AND WATERCOURSES (R.R.O. 1990 REG.178/08) Application # LPRCA -Applicant/ Owner's Name: Waynes Mandy Mailing Address: P.O. Box Apartmenl/Unit # N4GOES Primary Phone: Email: WWMowhiney @ AOL. COM Agent's Name: Check if same as above Mailing Address: Street Address P.O. Box Apartment/Unit # 34 4K4 ONACIO City/Town Postal Code Primary Phone: \5191426 9186 Alternate Phone: Samo phomes. Ca Lot: 48 Concession/Plan: Municipal Address: 105 Street Address Tax Assessment Roll Number: 188 Proposed work: (Check all appropriate boxes) Place, dump, or remove fill
Site grading
Construct a new building or structure
Alter or renovate an existing building or structure Ist Floor; Znd Floor Proposed square footage: Existing square footage: Construct a septic system Construct erosion control or shoreline protection ☐ Construct new or replace existing watercourse crossing ☐ Other: (please describe) PROPOSED COMPLETION DATE: I understand that the information contained in this application form is accurate to the best of my knowledge and that the staff of the Long Point Region Conservation Authority (LPRCA) will undertake a detailed inspection of the subject lands as part of the application process.

Page 1 of 6

Agent Signature

111013141111111
Subject Property
Property Location 105 Ordnance Ave. Lot 48 Turkey Pair Municipal Address or Lot and Concession or Lot and Plan
3
MunicipalityCommunity
22
I've Stableton Magne Marchanges (1). Markay
Herebyauthorize Prominent Homes
To provide as my agent any required authorizations or consents, to submit the enclosed application to the Long Point Region
Conservation Authority, and to appear on my behalf at any hearing(s) of the application and to provide any information or material
required by the Board relevant to the application for the purposes of obtaining permission to develop, interfere with a wetland or
alter a shoreline or watercourse in accordance with the requirements of Ontario Regulation 178/06 as amended.
Dr. Va
2 1/Manney
Signature of Owner: March 19/2

APPLICATION FORM INSTRUCTIONS

Owner

The legal owner(s) of the property where the proposed development or alteration will be carried out.

Applicant

If the applicant is not the same as the property owner, written authorization is required from all property owners on whose property the proposed work will be carried out. The authorization(s) must be submitted with the application.

Agent

If the applicant has assigned another party as an agent to act on the applicant's behalf for the project, written authorization from the applicant is required so stating.

Quantity of Fill Approximate quantity expressed in cubic metres, cubic yards, truck loads (12 yards) or tandem truck loads (18 yards)

Floor area

For residential development, area of living space including full height basement and additional storeys, but not including attached garage, non-habitable crawl space, open breezeways, decks or porches.

APPLICATION CHECKLIST

<u>Submission:</u> LPRCA permit applications along with supporting information may be submitted in person to our office, or by fax, email or mail.

Office Use Only
Application # LPRCA
List Issued:

<u>Pre-consultation</u>: Please contact LPRCA staff regarding the requirements specific to your proposal. Also, please make sure your contractors and consultants contact LPRCA staff before completing detailed drawings or technical studies.

<u>Complete application</u>: A complete application package includes (check all applicable):

Applicable	Submitted		
✓		A completed, signed and dated application form;	
✓		Written authorization (if the applicant is not the owner of the property where the work is being done)	
✓		Written authorization (if the property owner is assigning another party as an agent for the project);	
\checkmark		Application fee (see fee schedule, fees subject to change without notice);	
✓		A scaled and detailed site plan;	
✓		A scaled cross-sectional drawing and floor plans;	
provided an	id readable o	all project drawings, reports, unless otherwise requested. Hardcopy drawings must be n sheets no larger than 11" x 17". Electronic submission of drawings and reports is preferred. clude (either as part of the illustration or as notes).	
\checkmark		Legal description of the property (e.g. roll number, lot, concession, municipality);	
\checkmark		Scale, date, and directional arrow;	
\checkmark		Dimensions of the property (a copy of a legal survey may be required);	
✓		Location, dimensions and geodetic elevations of all existing and proposed structures, grading, filling, excavating, and the distance to any waterbody(s) (e.g. wetlands, streams, lakes), valleys, steep slopes on or adjacent to the property;	
✓		Location and type of sediment and erosion control measures (e.g. silt fence) and soil stabilization measures (e.g. seeding, sodding, planting)	
Technical re	eports: One o	or more of the following technical reports <u>may</u> be required (as advised by LPRCA staff).	
		Design drawings and description of the design elements for flood-proofing measures, stamped and certified by a qualified professional engineer (for development in floodplains and flood hazard areas)	
		Slope stability study and erosion analysis, prepared by a qualified professional with expertise in geotechnical engineering, to determine the stable top-of-bank, the minimum development setback to address the potential erosion hazards, and associated foundation, construction, grading and drainage recommendations, in accordance with the Provincial Technical Guidelines (for development in erosion hazard areas)	
		Coastal engineering assessment prepared by a qualified professional with expertise in coastal engineering in accordance with LPRCA's Shoreline Management Plan and the Provincial Technical Guidelines addressing hydrodynamic forces affecting the design and indicating how the aggravation of erosion on neighbouring properties is avoided (for shoreline alterations).	
		Environmental Impact Study (EIS) clearly indicating that there will be no negative impact to the form or function of the wetland to the satisfaction of LPRCA (for development near wetlands)	
		Hydraulic analysis by a qualified professional engineer addressing flood conveyance, storage-discharge, and changes in flood levels on-site and on adjacent properties (for development in floodplains, watercourse alterations).	
		Complex and large-scale proposals may require additional technical studies and plans.	
For Offi	ice Use Only		
	ion Submitted		
	te Application:		
	ion Fee:	Paid:	
Board A	pproval Requi	red Date of Board Meeting:	

GENERAL CONDITIONS OF PERMIT

- 1. This permit does not absolve the permittee of the responsibility of obtaining necessary permission from applicable federal and provincial agencies or local municipalities.
- 2. The permittee agrees by acceptance of the permit:
 - a) to indemnify and save harmless, the Long Point Region Conservation Authority and its officers, employees, or agents, from and against all damage, injury, loss, costs, claims, demands, actions and proceedings, arising out of or resulting from any act or omission of the permittee or of any of his agents, employees or contractors relating to any of the particular terms or conditions of this permit.
 - b) that this permit shall not release the permittee from any legal liability or obligation and remains in force subject to all limitations, requirements, requirements and liabilities imposed by law.
 - c) to provide certification of conformance to ensure compliance with the intent of the permit. This certification must be provided by an accredited professional and is to be submitted as may be specified in the permit.
- 3. Authorized representatives of the Long Point Region Conservation Authority will be granted entry at any time into lands and buildings which are the subject of this permit application in order to make such surveys, examinations, investigations, inspections or other arrangements which such representatives deem necessary.
- 4. The project shall be carried out generally as per the plans submitted in support of the application as they may be amended by conditions of this permit.
- 5. Any activity or development other than that identified in this permit application must be reviewed by the LPRCA; at which time, staff will determine if additional approvals or an amended permit will be required.
- 6. The Long Point Region Conservation Authority may cancel this permit or may change any of the conditions at any time and without prior notice if it is determined that:
 - a) the works are not in conformance with the intent of the permission granted;
 - b) the information presented to obtain a permit is false;
 - c) the works or method of construction has detrimental impacts on the environment.
- 7. Temporary sediment & erosion control measures shall be installed around any disturbed and/or exposed ground or excavated material stockpiles, remain in place until the site has been suitably stabilized, and must be monitored regularly to ensure effectiveness. Remedial/Emergency measures must be taken at any sign of failure.
- 8. The applicant agrees to maintain all existing drainage patterns except as expressly identified in this permit.
- 9. It is the responsibility of the permittee to ensure the development is located within the extent of the property boundaries owned by the proponent.
- 10. This approval does not guarantee the soundness of the proposed work and it is the responsibility of the permittee to monitor and maintain the construction activity to ensure the integrity of the work.
- 11. This permit shall not be assigned (non-transferable).
- 12. Permits are valid for two years. No notice will be issued on expiration of the permit and it is the responsibility of the permittee to ensure a valid permit is in effect at the time work is occurring.
- 13. The Conservation Authority should be contacted within 48 hours prior to the commencement of construction.
- 14. The Long Point Region Conservation Authority may make copies of Schedule A, as required, for the purposes of assessing the proposal and, where approved, to form part of the permit issued.

NOTICE OF COLLECTION

Pursuant to section 29(2) of the Municipal Freedom of Information and Protection of Individual Privacy Act, 1989, the personal information contained on this form is collected under the legal authority of the Conservation Authorities Act, R.S.O. 1980, c85, as amended. This information is used to assess applications for and, where approved, issue comment. The name of the applicant, location of the work and a description of the project may be published in LPRCA documents, including agendas, reports and meeting minutes which are posted on the LPRCA website. Questions about the collection of personal information should be directed to the Freedom of Information Coordinator, Long Point Region Conservation Authority, 4 Elm Street, Tillsonburg, Ontario, N4G 0C4, (519) 842-4242.



The Corporation of Norfolk County

By-Law 2017-04

Lot Grading and Drainage

THIS FORM IS TO BE SUBMITTED WITH EVERY LOT GRADING PLAN
Municipal Address: 105 Ordnance Avenue, Turkey Point
And/or
PIN:
SELECT THE ONE PURPOSE FOR SUBMITTING THIS FORM:
Proposed Grading Plan for Infill Lot:
I, Kim Husted ,a Qualified Person, submit the attached Proposed Grading Plan, under my seal to confirm that the Plan provides drainage in accordance with the Ontario Building Code and applicable Municipal regulations for the works to be constructed that are the subject of the Building Permit Application to which this is attached.
☐ Proposed Grading Plan within a Plan of Subdivision:
I,, a Qualified Person, submit the attached Proposed Grading Plan, under my seal to confirm that the Plan conforms in all respects with the Master Grading Plan in the Plan of Subdivision Master Grading Plan, registered as:


name of the Plan of Subdivision and Registration Number).

IN ANY INSTANCE ABOVE NOTING "UNDER MY SEAL", AFFIX SEAL BELOW:

WIND HOS		
Mary # 207 p		
* And		
SEAL (Qualified Person)		
777		. *
(Sign and date over the seal)		
Name: KIM HUSTED	0.1.5	•

License Number: 1582

This form approved by the County Official under delegated authority under Norfolk County By-Law 2017-04

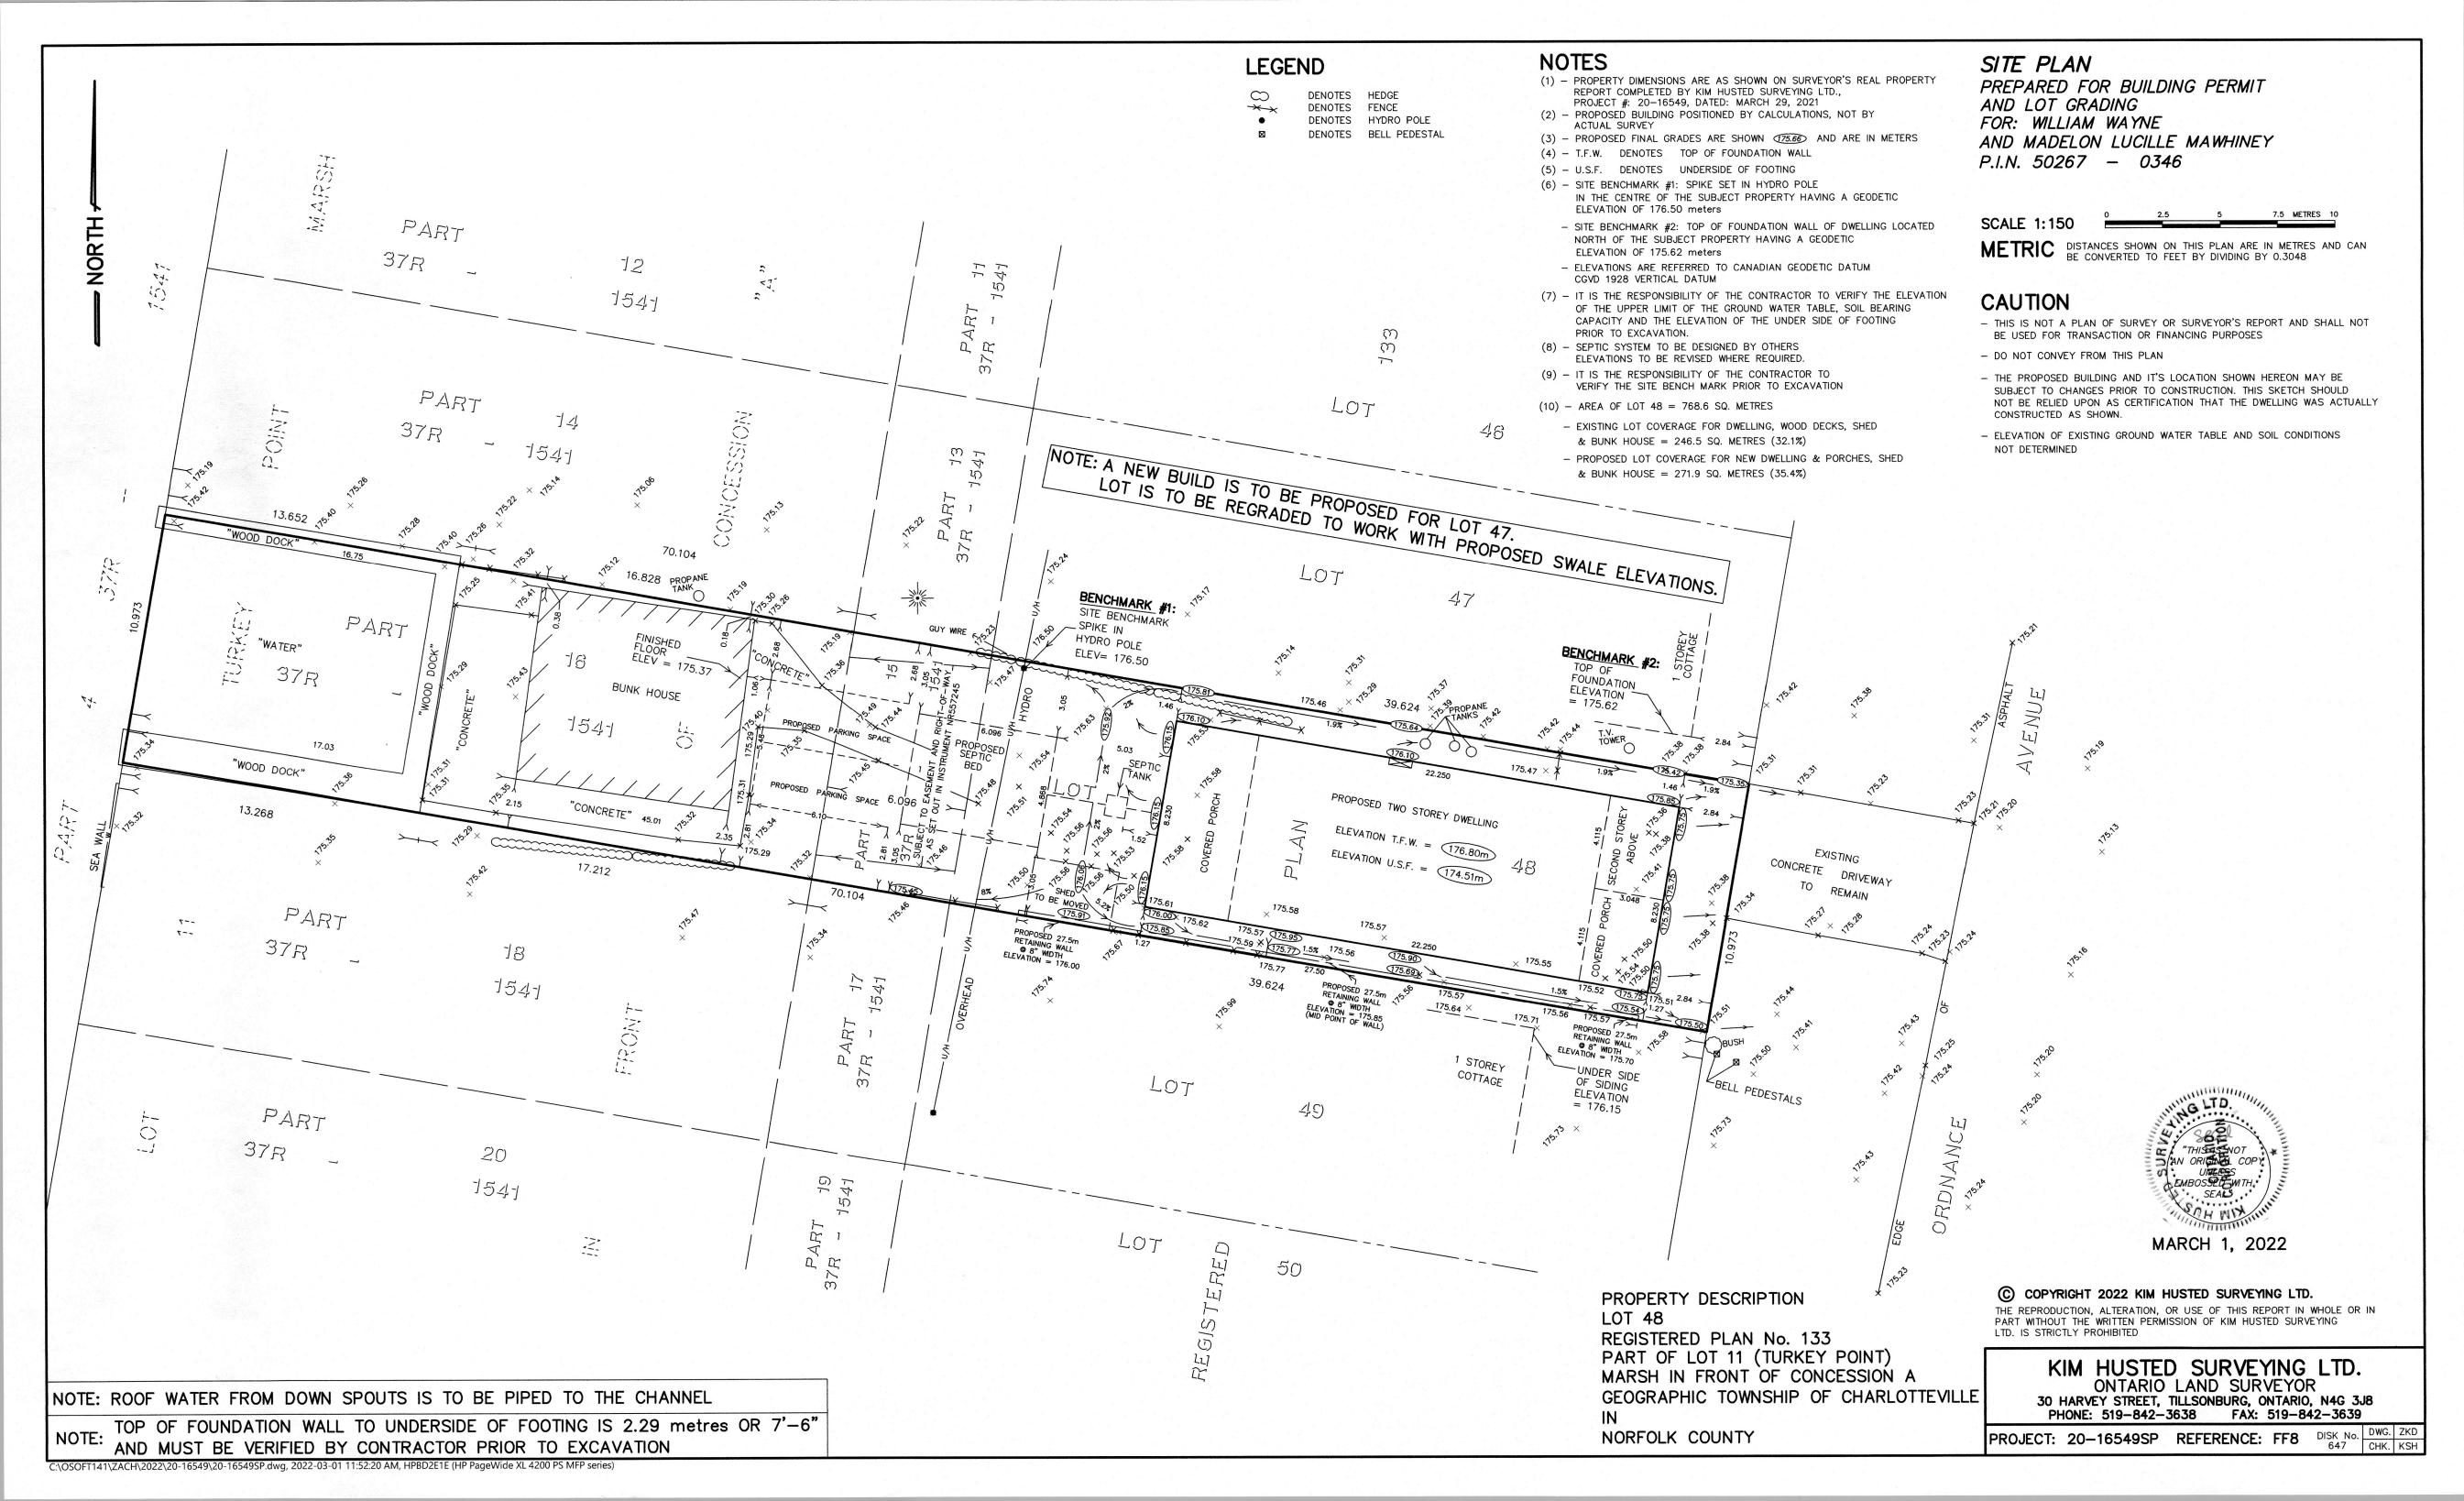




PROMINENT HOMES CUSTOM COTTAGE


105 Ordnance Ave, Turkey Point

	DRAWING INDEX
SH #	DRAWING NAME
A-1 A-2 A-3 A-4 A-5 A-6	FOUNDATION PLAN 1st FLOOR PLAN 2nd FLOOR PLAN FRONT & RIGHT SIDE ELEVATIONS REAR & LEFT SIDE ELEVATIONS BUILDING CROSS-SECTION
A-7	ROOF PLAN

PROMINENT HOMES				
COVER SHEET				
DRAWN BY	M BUNTING E	BCIN #:	37Ø74	SHEET No.
DATE MAR	CH 8TH 2022	SCALE	NTS	$\triangle - \emptyset$

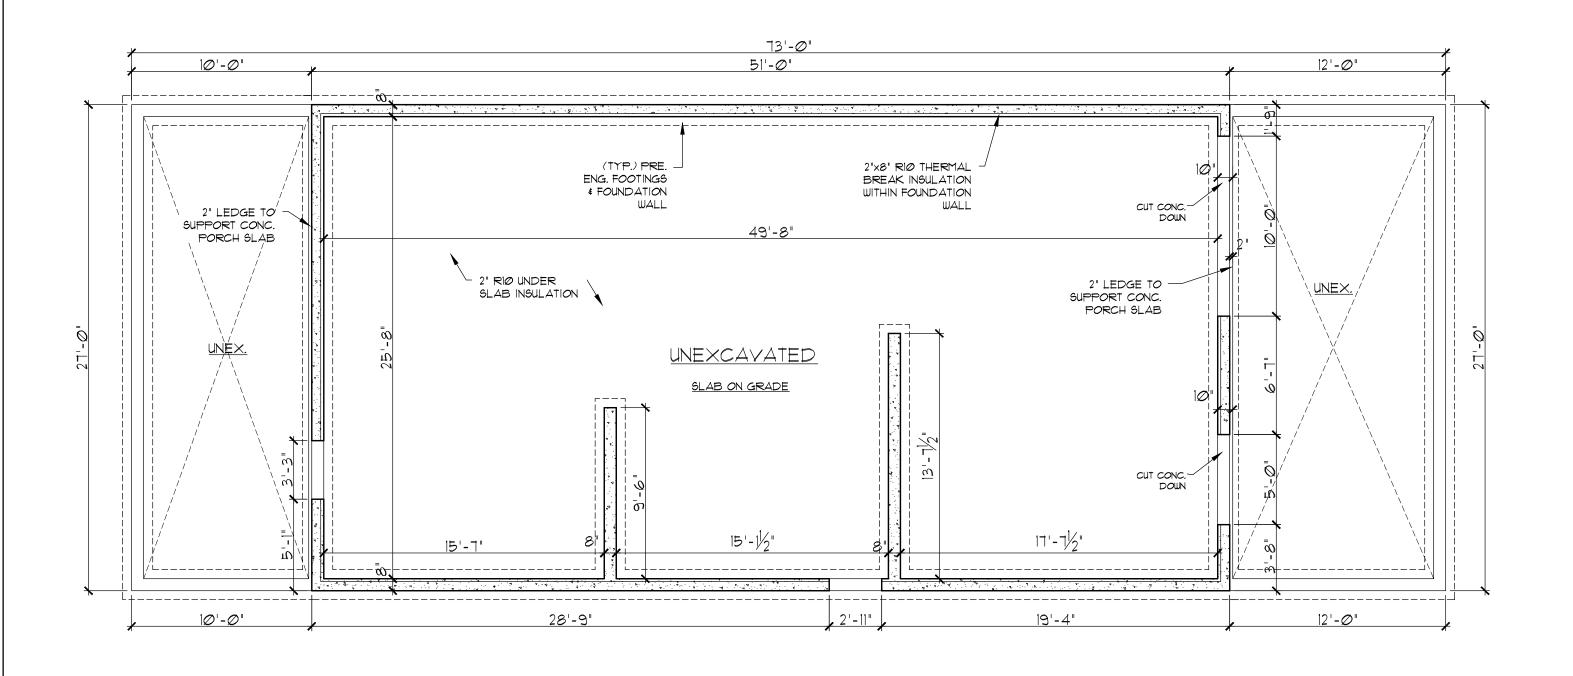


PROMINENT HOMES			
E	BASEMEN	T PLAN	
ADDRESS 46 LA	AKESIDE DR. PEACO	OCK POINT	
DRAWN BY SAM E	BUNTING BCIN #:	37 0 74	SHEET No.
DATE MARCH	8TH 2022 SCALE	1/4" = 1'-0"	<u> </u>

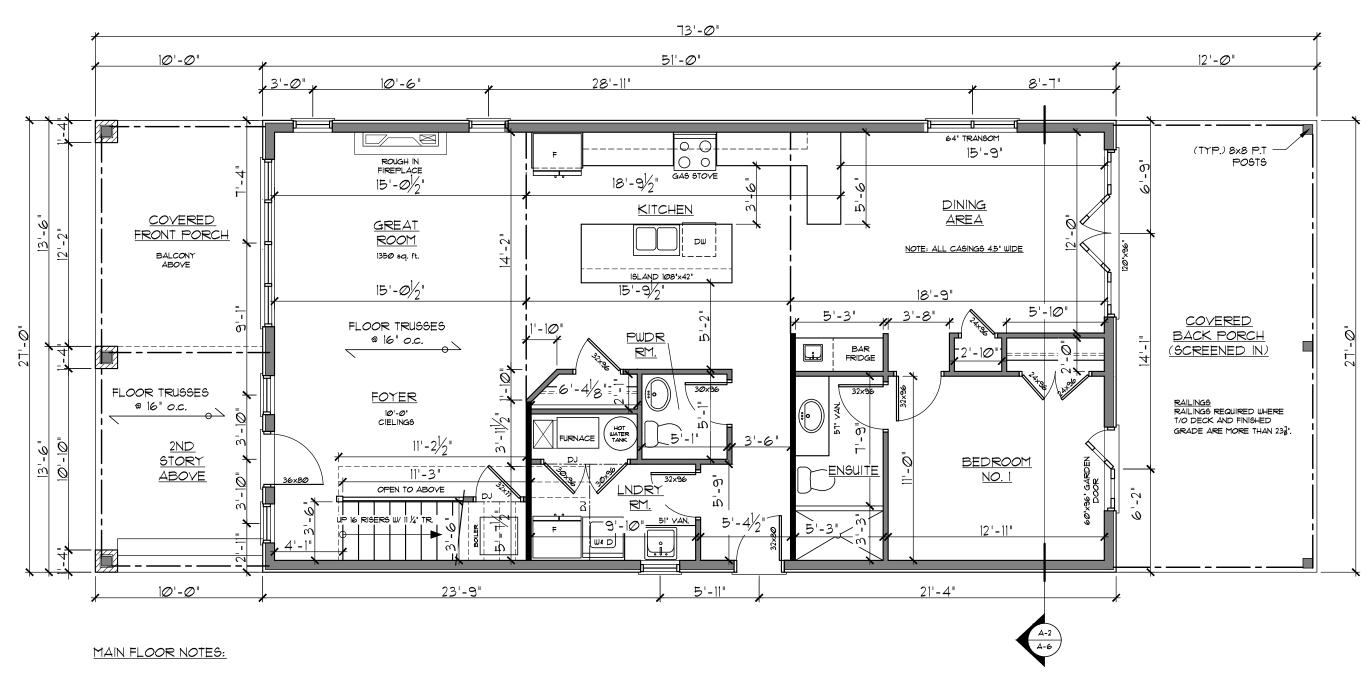


- 1. FLOOR TRUSSES ON MAIN FLOOR
- 2. WIDER CASING (4.5"x2")
- 3. NO SLIDERS
- 4. 32" DOORS 96" HIGH
- 5. 10' CIELING
- 6. GAS STOVE
- 1. CONDUIT PIPE UDER COTTAGE FOR FUTURE ACCESS
- 8. SERVICE FOR BOTH FRONT AND BACK YARD LIGHTING AND WATER TAPS


PROMINENT HOMES			
1st FLC	DOR PLANS		
ADDRESS 105 ORDNA	NCE AVE. LOT 48		
DRAWN BY SAM BUNTING	BCIN #: 37Ø74	SHEET No.	
DATE MARCH 8TH 2022	SCALE /4" =1'-@"	A=2	

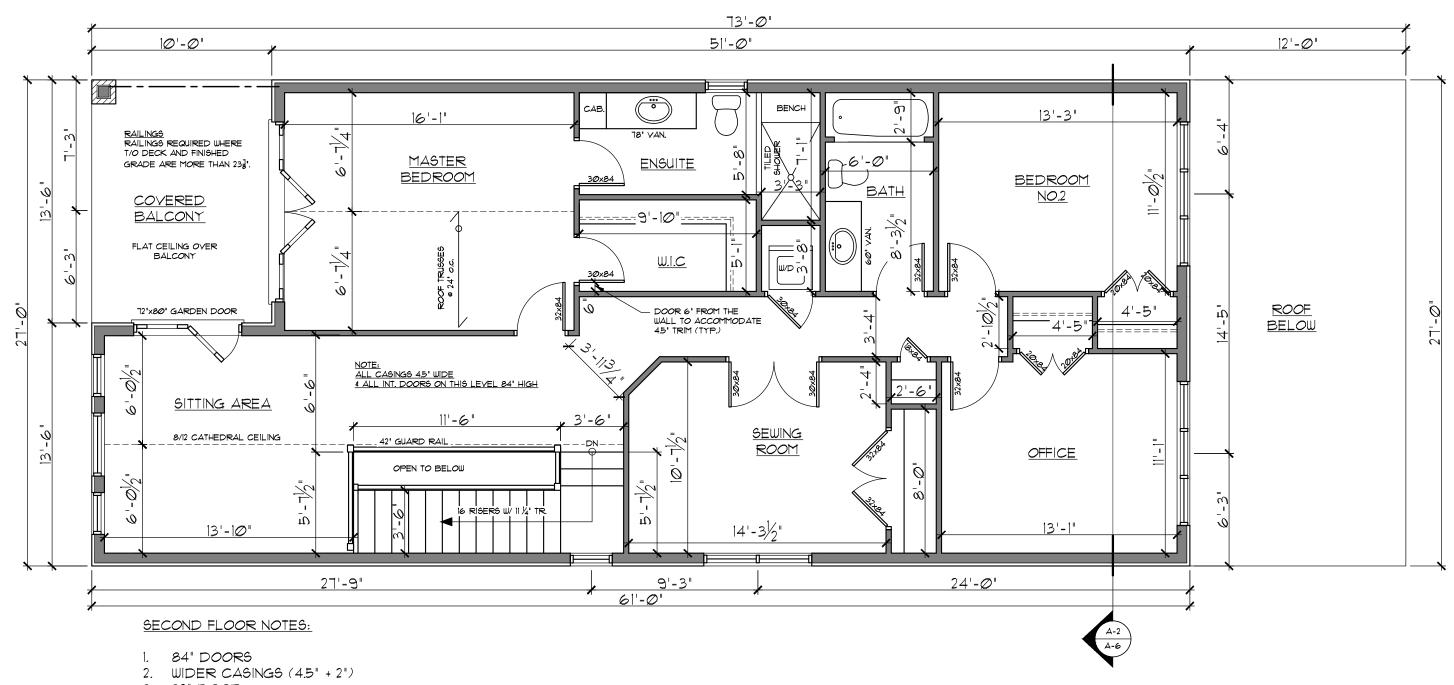

- 3. 32" DOOR
- 4. LIGHTS IN CLOSETS
- 5. 9' CIELINGS


PROMINENT HOMES			
2nd FLo	DOR F	PLANS	
DDRESS 105 ORDNA	NCE AVE. LOT	48	
RAWN BY SAM BUNTING	BCIN #:	37074	SHEET No.
MARCH 8TH 2022	SCALE y	√4" =1'-Ø"	A-3

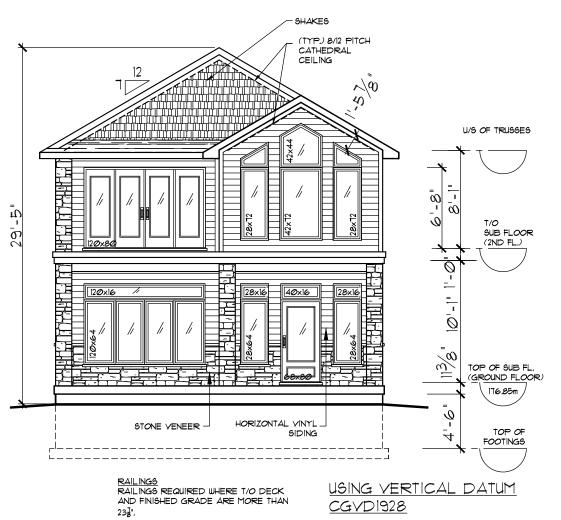

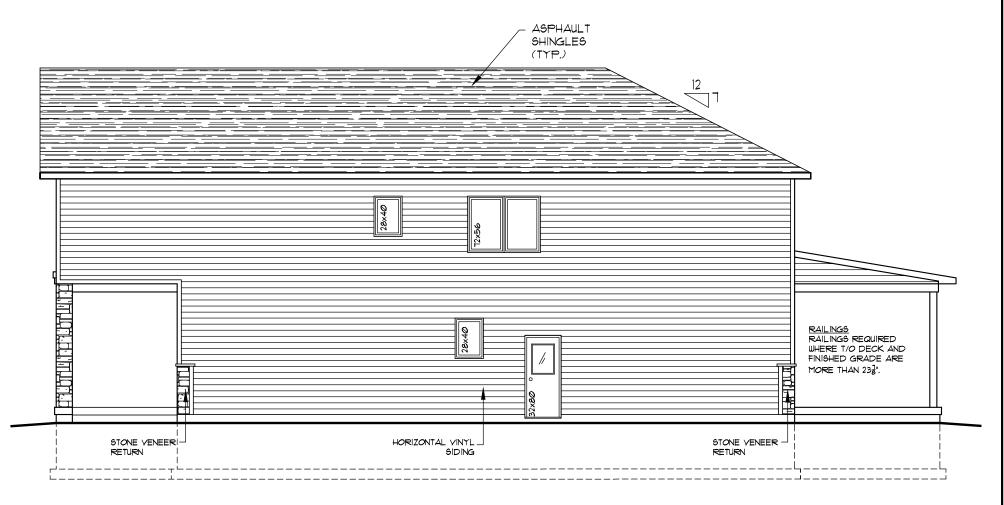


USING VERTICAL DATUM CGVD1928


> PROMINENT HOMES FRONT & RIGHT SIDE ELEY. 46 LAKESIDE DR. PEACOCK POINT SHEET No. SAM BUNTING 37Ø74 MARCH 8TH 2022 /s" =1'-Ø"

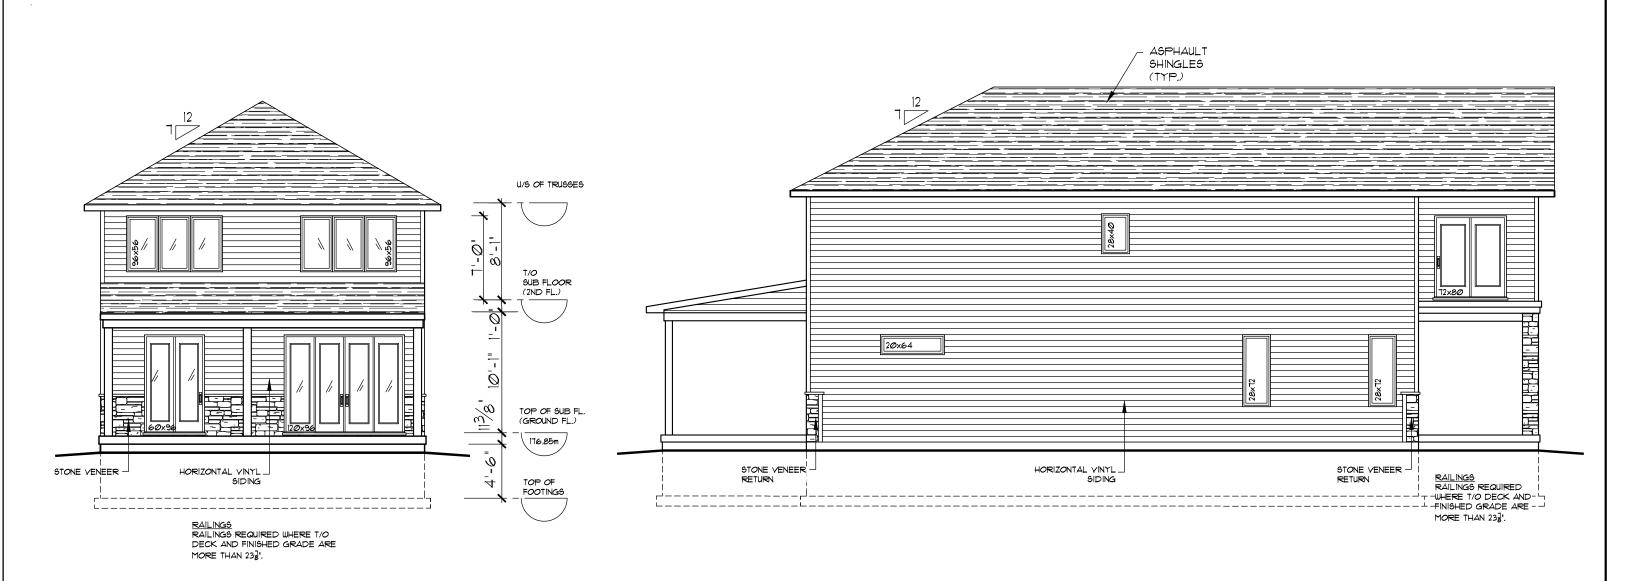

PROMINENT HOMES REAR & LEFT SIDE ELEV. ADDRESS 46 LAKESIDE DR. PEACOCK POINT DRAWN BY SAM BUNTING BCIN #: 37074 SHEET NO. DATE MARCH 8TH 2022 SCALE 14" =1'-0"

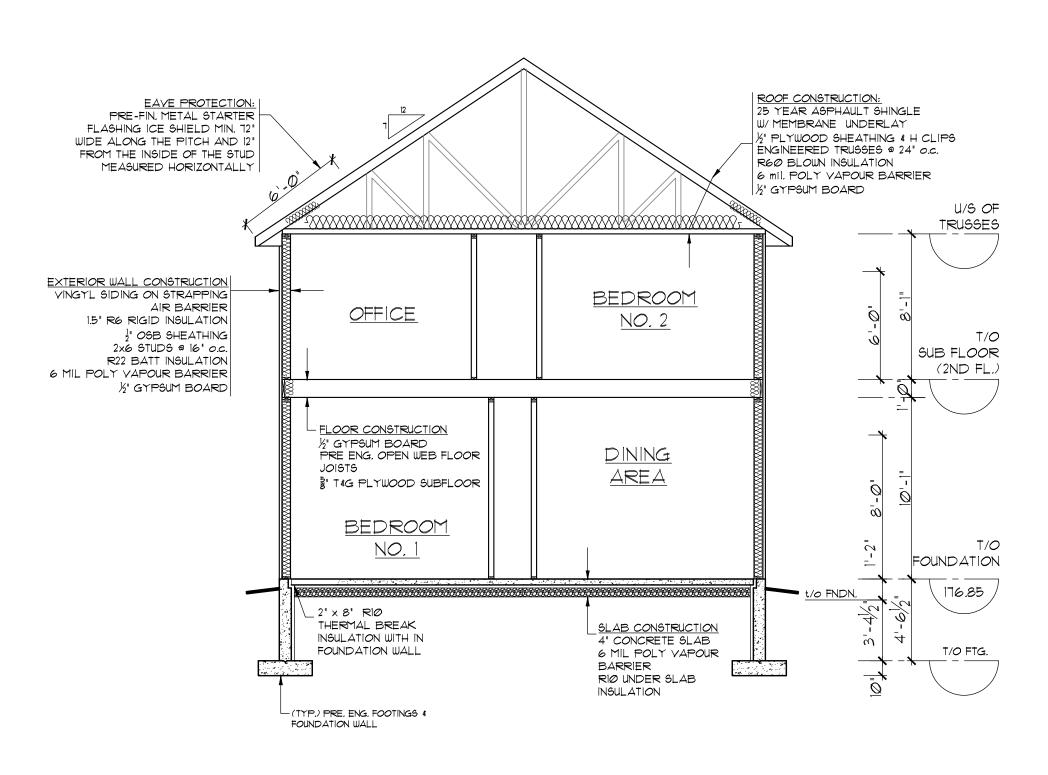

PROMIN	VENT HOMES	
BUILDI	NG SECTION	
ADDRESS 46 LAKESIDE DE	R PEACOCK POINT	
DRAWN BY SAM BUNTING	BCIN #: 37Ø74	SHEET No.
DATE MARCH 8TH 2022	SCALE /8" =1'-0"	A-6

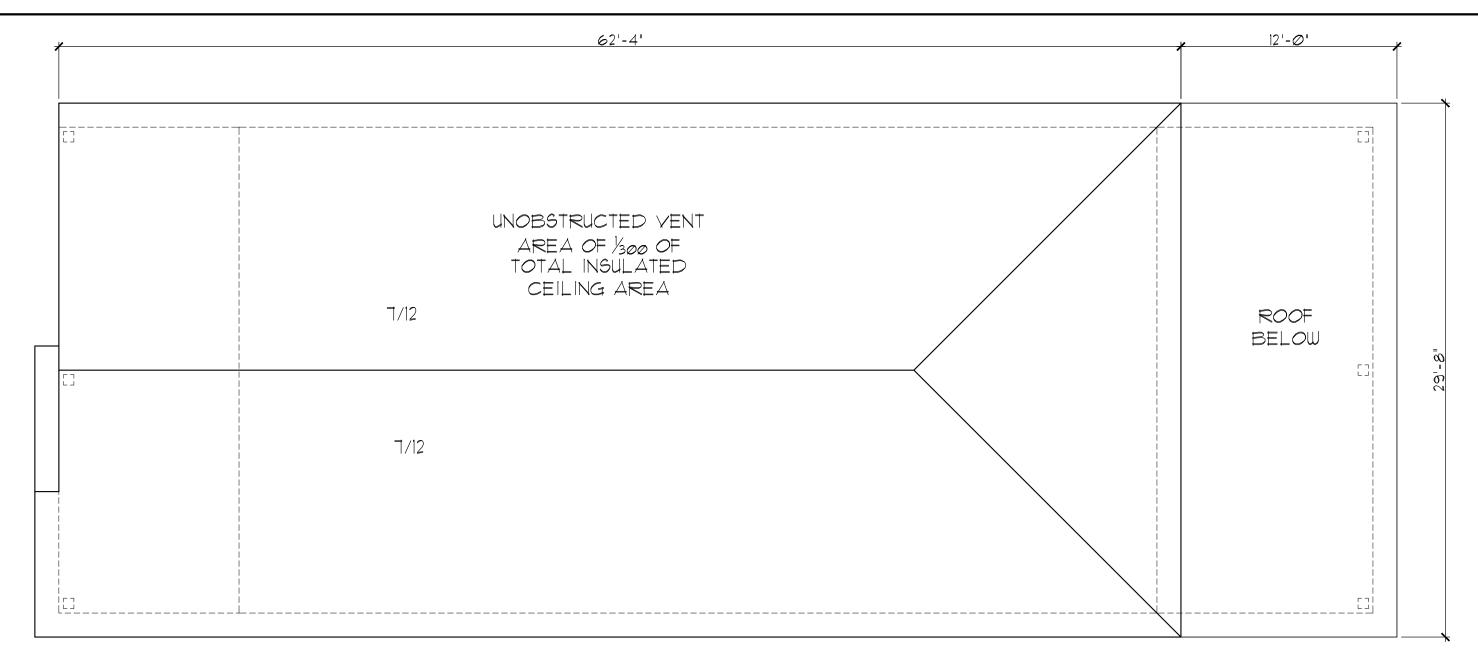

1'-4" OVER HANG UNLESS NOTED OTHERWISE

	WOOD LINTEL SCHEDULE FORMING PART OF SENTENCE O.B.C. 923.12.3					
LINTEL SIZES (in)	<u>MAXIMUM SPAN</u> SUPPORTING ROOF (SSL - 1.5 kPA) AND CEILING ONLY (S-P-F No. 1 & 2)					
(11)	EXT. WALL	INT. WALL				
2 - 2×4	3'-7"	3'-Ø'				
2 - 2×6	5'-6"	4'-5"				
2 - 2×8	6'-7'	5'-4"				
2 - 2×10	8'-1"	6'-8"				
2 - 2×12	2 - 2×12 9'-5" T'-8"					
SPANS ARE CALCULATED BASED ON MAX. SUPPORTED JOIST OR RAFTER LENGTH OF 16'-0" AND A MAX. SUPPORTED TRUSS LENGTH OF 32'-1'.						
ALL HEADERS SUPPORTING SPANS THAT EXCEED THE ALLOWED SPANS, ARE TO BE						


PRE-ENGINEERED LYL HEADERS

WOOD LINTEL SCHEDULE FORMING PART OF SENTENCE O.B.C. 9.23,12,3				
LINTEL SIZES (in)	MAXIMUM SPAN SUPPORTING ROOF (SSL - 1,5 kPA) AND CEILING ON GABLE END ONLY (S-P-F NO. 1 4 2)			
	EXT. WALL	INT, WALL		
2 - 2×4	3'-T'	3'-Ø"		
2 - 2×6	5'-6"	4'-5"		
2 - 2×8	6'-7' 5'-4"			
2 - 2x1Ø	- 2x Ø 8'- " 6'-8"			
2 - 2×12 9'-5' 7'-8'				
SPANS ARE CALCULATED FOR GABLE END WALLS THAT SUPPORT ONLY 2'-0" OF ROOF & CEILING, BUT DO NOT SUPPORT ROOF JOISTS,				

ROOF RAFTERS & ROOF TRUSSES

ALL HEADERS SUPPORTING SPANS THAT EXCEED THE ALLOWED SPANS, ARE TO BE PRE-ENGINEERED LYL HEADERS

PROMIN	VENT HOMES			
RO	OF PLAN			
ADDRESS 46 LAKESIDE DR. PEACOCK POINT				
DRAWN BY SAM BUNTING	BCIN #: 37Ø74	SHEET No.		
DATE MARCH 8TH 2022	SCALE /4" =1'-0"	<u> </u>		

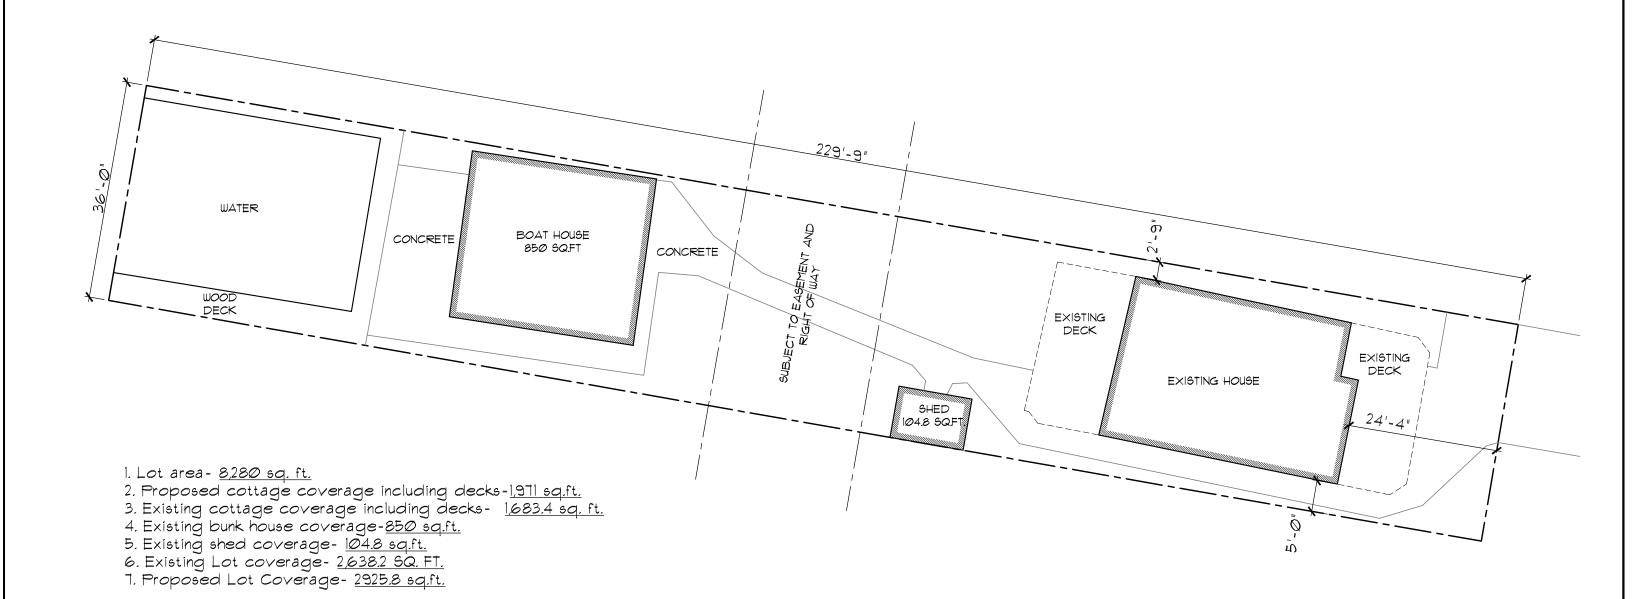

PROMINENT HOMES

SITE PLAN

DRAWN BY SAM BUNTING BCIN #: 37074 SHEET No.


DATE MARCH 8TH 2022 SCALE 36" = 1'-0"



Dedrick Bros. Excavating Ltd.

RR #1 DELHI ONTARIO N48 2W4 PHONE (519) 161 2049 FAX (519) 582-4187

March 08, 2022

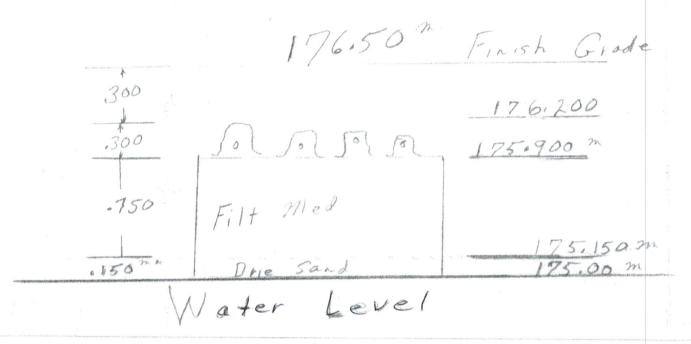

ELEVATIONS are Reference Kim Husted Surveying LID- Mey are CGVD. 1928 Vertical Patum

> Jary Dedrick BCIN 16930, 12191



The Corporation of Norfolk County

By-Law 2017-04

Lot Grading and Drainage

THIS FORM IS TO BE SUBMITTED WITH EVERY LOT GRADING PLAN
Municipal Address: 105 Ordnance Avenue, Turkey Point
And/or
PIN: 50267-0346
SELECT THE ONE PURPOSE FOR SUBMITTING THIS FORM:
Proposed Grading Plan for Infill Lot:
,a Qualified Person, submit the attached Proposed Grading Plan, under my seal to confirm that the Plan provides drainage in accordance with the Ontario Building Code and applicable Municipal regulations for the works to be constructed that are the subject of the Building Permit Application to which this is attached.
Proposed Grading Plan within a Plan of Subdivision:
I,, a Qualified Person, submit the attached Proposed Grading Plan, under my seal to confirm that the Plan conforms in all respects with the Master Grading Plan in the Plan of Subdivision Master Grading Plan, registered as:
name of the Plan of Subdivision and Registration Number).

IN ANY INSTANCE ABOVE NOTING "UNDER MY SEAL", AFFIX SEAL BELOW:

1	•
Marcha & 202	
WIN HILE	,
11, 16, 11, 10, 1	1,
5 - 6000	"A.
in S score	~ "-
1 1 0 1	2 5
EMONTHE 207	
EN LIMONOR TOY	W -
2 0-1	E - A.
mP /	III
三片 元四 1/1	JUL 111
3 . 35 1:	CK / II
E ONL	元 作 1 1 1 1 1 1 1 1 1 1 1 1 1 1 1 1 1 1
2 . 0 //	- LIVE
12 2 /2.1K	3/1
W. B.	11
3 C 17 D	1
SEAL TOURING	ad Diamana
COLUMN TOURSHAME	ed Person)

(Sign and date over the seal)

Name: KIN HUSTED O.L.S.

License Number: 1582

This form approved by the County Official under delegated authority under Norfolk County By-Law 2017-04

Application for a Permit to Construct or Demolish This form is authorized under subsection 8(1.1) of the Building Code Act, 1992

	For use by	Principa	Authority				
Application number:	Permit number (if different):						
Date received:	Roll number:						
Application submitted to: NORFOI (Name of municipalit	_K COUNT		ard of health or co	onservatio	n authority)	S	
A. Project information							
Building number, street name					Unit number	Lot/con.	
105 Ordnance Av.						48	
Municipality	Postal code		Plan number/o	other des	cription		
Turkey Point						-	
Turkey Point Project value est. \$			Area of work ((m ²)			
B. Purpose of application							
New construction Addition texisting b		☐ Alter	ation/repair		Demolition [Conditional Permit	
Proposed use of building	Curr	ent use of	building			1	
Cottage					4		
New Septic System For New Co	ttage						
C. Applicant Applicant is:	Owner or		☐ Authorized	d agent o	of owner		
Last name	First name	<u> </u>	Corporation o	CONTRACTOR NAME OF TAXABLE PARTY.			
DEDRICK	Larry		Dedri	ick Bro	Bros. Excavating Ltd.		
Street address 370 Lynedoch Road	1				Unit number	Lot/con. 5 11	
Municipality DELHI	Postal code N4b 2W4		Province ONTARIO		E-mail dbel@	kwic.com	
Telephone number (519) 582 2069	Fax () None				Cell number (519) 761 2	069	
D. Owner (if different from applicant)		·					
Last name	First name		Corporation o	r partner	ship		
M <mark>aw</mark> hiney	wayne & N	Mandy					
Street address			Annual art of the second annual second second second second		Unit number	Lot/con.	
Type text here			g			*1	
Municipality	Postal code		Province		E-mail	3	
Telephone number	Fax Cell number ()		and an administration of the second of the s				

E. Builder (optional)							
Last name	First name	Corporation or partne	rship (if a	applicable)			
Street address	1		Unit r	number	Lot/	con.	
Municipality	Postal code	Province	E-ma	il			
Telephone number ()	Fax ()		Cell r	number)			
F. Tarion Warranty Corporation (Ontar	o New Home Warı	ranty Program)					
i. Is proposed construction for a new hor Plan Act? If no, go to section G.	me as defined in the C	Ontario New Home Warranti	es		Yes		No
ii. Is registration required under the Onta	rio New Home Warrai	nties Plan Act?			Yes		No
iii. If yes to (ii) provide registration numbe	r(s):						
i) Attach Schedule 1 for each individual who re	views and takes response	onsibility for design activitie	S			•	
ii) Attach Schedule 2 where application is to cor			0.				
H. Completeness and compliance with	applicable law						
i) This application meets all the requirements of Building Code (the application is made in the applicable fields have been completed on the schedules are submitted).	correct form and by	the owner or authorized age	ent, all	₹ `	Yes		No
Payment has been made of all fees that are required, under the applicable by-law, resolution or						No	
							No
						No	
iv) The proposed building, construction or demo	olition will not contrave	ene any applicable law.		₩,	Yes	V	No No
I. Declaration of applicant							
Larry Dedrick				de	clare	that:	
(print name)							
The information contained in this appli documentation is true to the best of my If the owner is a corporation or partner	y knowledge.				her atta	ached	
Mar. 09,2022	10	rruDedrick					
Date	Signature	rry Dedrick e of applicant					

Personal information contained in this form and schedules is collected under the authority of subsection 8(1.1) of the *Building Code Act, 1992*, and will be used in the administration and enforcement of the *Building Code Act, 1992*. Questions about the collection of personal information may be addressed to: a) the Chief Building Official of the municipality or upper-tier municipality to which this application is being made, or, b) the inspector having the powers and duties of a chief building official in relation to sewage systems or plumbing for an upper-tier municipality, board of health or conservation authority to whom this application is made, or, c) Director, Building and Development Branch, Ministry of Municipal Affairs and Housing 777 Bay St., 2nd Floor. Toronto, M5G 2E5 (416) 585-6666.

Schedule 2: Sewage System Installer Information

A. Project Information			3.4	
Building number, street name 105 Ordnance Av.			Unit number	Lot/con.
Municipality Turkey Point	Postal code	Plan number/ other desc	cription	
P. Sowana austem installer				
B. Sewage system installer			installing repairing	continuo alconing or
Is the installer of the sewage system eng emptying sewage systems, in accordance	e with Building C	ode Article 3.3.1.1, Division		, servicing, cleaning or
Yes (Continue to Section C) No (Continue to Section E) Installer unknown at time of application (Continue to Section E)				
C. Registered installer information	on (where answ	ver to B is "Yes")		
Name dbel@kwic.com			BCIN	16930
Street address 370 LYNEDOCH R	OAD		Unit number	Lot/con. 6 11
Municipality Delhi	Postal code N4B 2W4	Province Ontaria	E-mail dbel@k	wic.com
Telephone number (519) 582 2069	Fax () None	9	Cell number (519) 761 20	069
D. Qualified supervisor informati	on (where ans	wer to section B is "Ye		
Name of qualified supervisor(s) Larry Dedrick		Building Code Identification	on Number (BCIN)	12191
Dennis Dedrick				12194
E. Declaration of Applicant:				
				d.
LARRY DEDRICK			4	declare that:
(print name)				
☐ I am the applicant for the perm shall submit a new Schedule 2				ime of application, I
<u>OR</u>				
☐ I am the holder of the permit to construct the sewage system, and am submitting a new Schedule 2, now that the installer is known.				
I certify that:				
The information contained in thi	s schedule is tru	e to the best of my knowled	ge.	
2. If the owner is a corporation or	partnership, I hav			ership.
Mar. 09,2022	Mar. 09,2022 Larry Dedrick			
Date		Signature of applicant		



January 2014, Form supersedes 2008

SEWAGE PERMIT WORKSHEET

SEWAGE SYSTEM SPECIFICATIONS

Location of Septic System (civic address) 105 Ordnance Av.				
Owner of Property: wayne & Mandy Mawhiney	1			
Propose to install Class4	Sewage system to serve Cottage (house, bunkhouse, restaurant, office, commercial)			

SEWAGE FLOW CALCULATIONS

DESCRIPTION	TOTAL#	FIXTURE UNITS	TOTAL
Water closet (toilet)	1	x 4.0	4
Each sink or wash basin	3	x 1.5	4.5
Bath tub or shower		x 1.5	
Dishwasher	1	x 1.0	1
Clothes washing machine	1	x 1.5	1.5
Single or Double Laundry Tubs	1	x 1.5	1.5
Floor Drain Do Not Connect To S	eptic System	x 3.0	
Water Softener Do Not Connect To	Septic System	x 1.5	
Other Groups	3	x 6	18
17.7		TOTAL FIXTURE UNITS	= 30.5

 $30.5 \text{ Fix } -20 = 10.5 \times 50 = 525 \text{ I/d}$

RESIDENTIAL		OTHER (ie: bunkhouse, office , restaurant)
Total finished area: (sqm)	(sq ft)	Total finished area: (sqm) (sqft)
# of bedrooms: 3		# of employees:
Water softener discharge: Do Not Cnnect Into Septic System	(L/day)	Water softener discharge: (L/day)
Daily flow rate (DFR): 2125	(L/day)	Daily flow rate (DFR): (L/day)
Tank size (2 x DFR): 5900	(L/day)	Tank size (3 x DFR): (L/day)

INSTALLER TO COMPLETE THE FOLLOWING:

Subsurface Conditions Encountered

Rock & G G.W.T	Depth (m)	Soil Type				
Water Level	-0-	Topsoil				
A1 4 05	-0.25-					
At 1.25 m	-0.50-	Sand				
	-0.75-					
	-1.0-					
	-1.25-					
	-1.50-					

Describe existing soil conditions: sand	
Soils Analysis completed by:	
Norfolk Soils Analysis	
Confirmed Percolation Rate: (T time) 6	
, ,	
Gradation Reports submitted: Sand Y/N	

NORFOLK SOILS ANALYSIS

(a division of 002068251 Ontario Inc.) 55 Gibson Drive, Simcoe ON N3Y3L1, 519 410 6111, email: norfolksoils@gmail.com

January 31, 2022

Invoice 2022005

To: D

Dedrick Bros. Excavating Ltd

370 Lynedoch Road Delhi, ON N4B 2W4

Project: Soils Analysis: Property Owner; Wayne and Mandy Mawhiney, 511 McDowell 105 Ordance Avenue, Turkey Point ON, Norfolk County

Soils analysis in accordance with Section 8.2.1.2 of the Ontario Building Code, The Unified soil Classification System, and ASTM D6913 of which the distribution graph representing the sample provided is attached.

Based on the testing of the materials as provided for testing, It is our opinion that the **Percolation Rate is T = 6 min/cm.** The drainage characteristics of the soil for the proposed septic system appears to be suitable for an in-ground leeching bed system.

The Laboratory Classification of the soils SP – Poorly graded sands, with fines <12% specifically 3.11% of soil passing the No #200 sieve.

The Coefficient of Uniformity = 2.10 Coefficient of Curvature = 1.06

I trust this meets with your requirements for the soil sample provided.

Yours Truly,

D Free

D. R. Free, MBA, CPA, CET BCIN 109582



Encls


NORFOLK SOILS ANALYSIS

Sieve Analysis Data Sheet

ASTM D422-63(2007)

Project Name:	SA2022	005	Tested By:	DRF	Date:	2022-01-31
Location:	511 McDowell 105 Ordance Avenue, Turkey Point ON, Norfolk County		Checked By:	DRF BCIN 109582	Date:	2022-01-31
Client	Dedrick Bros. Excavating Ltd 370 Lynedoch Road Delhi, ON N4B 2W4		Property Owner	Wayne and Ma	andy Mawhiney	
Boring No:	NA		Test Number:	1	-	
sample Depth: NA		Gnd Elev.:	NA			
USCS Soil Classification:		SP - I	Poorly Graded S	Sands with fines <	12%	
	AASHTO Soil C	Classification		Α-	1-a	
Weight of Container (g): 76.4				Weight of Con	tainer & Soil (g):	991.4
Weight of Dry Sample (g): 747.2				Moisture	Content %	18.3%

Sieve Number	Diameter (mm)	Mass of Sieve (g)	Mass of Sieve & Soil (g)	Soil Retained (g)	Soil Retained (%)	Soil Passing (%)
#4	4.75	749.6	750.8	1.2	0.2	99.8
#10	2.00	670.0	673.7	3.7	0.5	99.5
#16	1.18	653.0	657.9	4.9	0.7	99.2
#30	0.85	582.6	670.4	87.8	11.8	87.4
#50	0.43	561.6	1018.6	457.0	61.2	26.3
#100	0.25	529.2	670.1	140.9	18.9	7.4
#200	0.075	513.1	541.6	28.5	3.8	3.6
Pan		283.1	306.3	23.2	3.1	0.0
			TOTAL:	747.2	100.0	

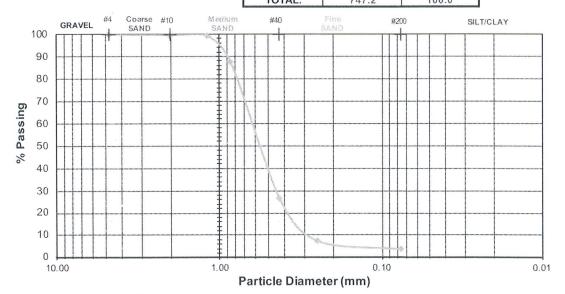

Grain Size Distribution Curve Results:



% Gravel: 0.400 % Sand: 96.495 % Fines: 3.105

Fines: 3.105 100.000 **D**₁₀: 0.300 **D**₃₀: 0.450 **D**₆₀: 0.630 C_u: 2.10 C_c: 1.058

Notice to Reader & Limitations:

These test results are unique to this soil sample and for the client as identified on the date for which the tests were performed. These test results cannot be used by any other party other than the client stated above within the text of this report without the consultants prior written approval.



January 2014, Form supersedes 2008

SEWAGE PERMIT WORKSHEET

			SEWAG	GE SYST	EM SPECIFICATIONS	8
Location of Sep	otic System (civic ac	ldress)			
Owner of Propo	erty:		na hannakur ar siri -ne British di Anna shirik			
Propose to install Class					Sewage system to serv (house, bunkhouse, restau	ve <u>SFJ</u> Irant, office, comm ê rcial)
			SEW	AGE FLC	OW CALCULATIONS	
DESC	RIPTION		AND THE PROPERTY OF THE PROPER	TAL#	FIXTURE UNITS	TOTAL
Water closet (t	oilet)			ACCUSTOMENTO STORY OF STREET	x 4.0	And a discontinuo de se cuada de discontinuo de la dela dela dela dela dela dela compositoria del dela dela dela dela dela dela dela
Each sink or wa	ish basin		ATERITA E ROCCIO E CHICARE E MOTO COCCION I	4	x 1.5	1.5
Bath tub or sho	wer				x 1.5	1,5
Dishwasher					× 1.0	and the state of the state of the control of the state of
Clothes washin	g machine		OEGO ESTA VARIATA A COLO PARTARDA COS		× 1.5	en la come de la come de la come de Tella de la come de
Single or Doub	le Laundry T	ubs	AND SOLD THE STATE OF THE STATE OF	1	x 1.5	1.5
Floor Drain					x 3.0	
Water Softene	^				x 1.5	
Other Group			1	11	x 6	18
	szemiadovakazalatos zajópat körkértekéteketeketeketeketeketeketek	and the contract of the contra	ng againting agus an bhí in giù tha thairt ag shi an thairt ag shi an thairt ag shi an thairt ag shi an thairt	e aprochectacione no electronico de con-	TOTAL FIXTURE UNITS	envie envi
nco-sean-dular resident de describações à sea seis softwaren de someren do construir de	RESIDEN	TIAL	ngan densayen agalang masakan ekelan atawa	nergi etmi, timotovi arija kirika karija ari si deti.	OTHER (ie: bunkhous	se, office , restaurant)
Total finished a	area: 185,	(sqm)	200	(sq ft)	Total finished area:	(sqm) (sqft)
# of bedrooms		Up.		enteriorite de montre sonne formatien (en montre de l'anne	# of employees:	make of the Antice was the Antice course A Lamb Care of the Antice course of the Antice Care of the Antice C
Water softene	r discharge:	coofe incurrence assert resconding	uzwa kozwaza nakoloka kilo do koloki kilo k	(L/day)	Water softener discha	rge: (L/day)
Daily flow rate	(DFR): 2,	000		(L/day)	Daily flow rate (DFR):	(L/day)
Tank size (2 x [/	- Accessore dichercherchercherchercherchercherchercher	and the second s	(L/day)	Tank size (3 x DFR):	(L/day)
	outremente de le constitue de la constitue de	INST	ALLER	TO CON	APLETE THE FOLLOWING	Bethrichte Eucklapikolation see die serchlussen Anterlands road Anterlands webenstellender untsternableau scheigen op sympakunsel. 8 8 More
Subsurface Condi		- Andrews			1	
Rock & G G.W.T	Depth (m) -0- -0.25-	Soil Typ	e	1 1	Describe existing soil condit Soils Analysis completed by	
	-0.50- -0.75- -1.0- -1.25- -1.50-			1 1	Confirmed Percolation Rate Gradation Reports submitte	, and the second

Date	Received:	



PROPOSE TO CONSTRUCT: **CLASS 1,2,3** Privy Composting Chemical Electrical Other_____ CLASS 1 **CLASS 2: GREY WATER PIT** □Concrete Block □Rock □Other Wall Structure: Soil: □ Existing □ Imported (describe) Length:_____Width: _____Height: _____ Type of Cover: _____ **Dimension of Pit: CLASS 3: CESSPOOL** Describe: **CLASS 4: TANK** ☐ Distribution Box Using Existing \sqrt{N} ew Govn't approved: \sqrt{C} Concrete \square Polyethylene Size (L): $\frac{5900}{N}$ Pump or siphon req'd: Head: _____Runtime: ____Horsepower: _____Size of pump(L)____ CLASS 4: LEACHING BED/ABSORPTION TRENCH list type: _____ height: _____ Dug into existing soil ☐ Imported Soil (proof of filter material must be provided) Length of Tile: (m) (ft) # of runs of tile: _____ CLASS 4: FILTER BED (proof of filter material to be provided prior to backfill) □Pump or siphon req'd: Head: _____Runtime: ____Horsepower: _____Size of pump(L)____ Effective Area 28.33 (sgm) Contact Area 15 (sgm) Loading Rate: 10 Height Raised: ______ #of runs of tile: _____ Length of tile _____ (m) _____ (ft) CLASS 4: TREATMENT UNIT (attach Building Material Evaluation Committee Report (BMEC) Pump or siphon reg'd: Head: _____ Horsepower: _____ Size of pump(L)____ Manufacturer & Model: _____ Daily Flow Rate _____(L) Primary Tank Size (L) Secondary Tank Size (L)

CLASS 5: HOLDING TANK (audio visual alarm, and a pump out contract is required)

Manufacturer & Model: ______ Size _____

Date Received:	
Date Received.	




SEPTIC SYSTEM LOCATION PLAN

OWNER wayne & Mandy Mawhiney EVALUATOR Larry Dedrick	
PROPERTY ADDRESS 105 Ordnance Av., Turkey Point	
Covered Porch 176.125 The 5,900 L Tank	
176.12 5,900 L Tank 4.535	Ź
28.33 n.2	
← 3 ^m + m + m + m + m + m + m + m + m + m +	5.15 3
South Edge of Easement	
316 4.868 3.316 5.5 m	
Easement	
B.2.1.6. ON-SITE	
Table 8.2.1.6.A sarances for Ire and of Sentence Col	
R.2.1.6. Te Minimum Clea Forming Par Forming Par Forming Par Stucture Object Stucture Ford Fo	
1 1 1 1 1 1 1 1 1 1 1 1 1 1 1 1 1 1 1	


CONTEXT MAP

Geographic Township of CHARLOTTEVILLE

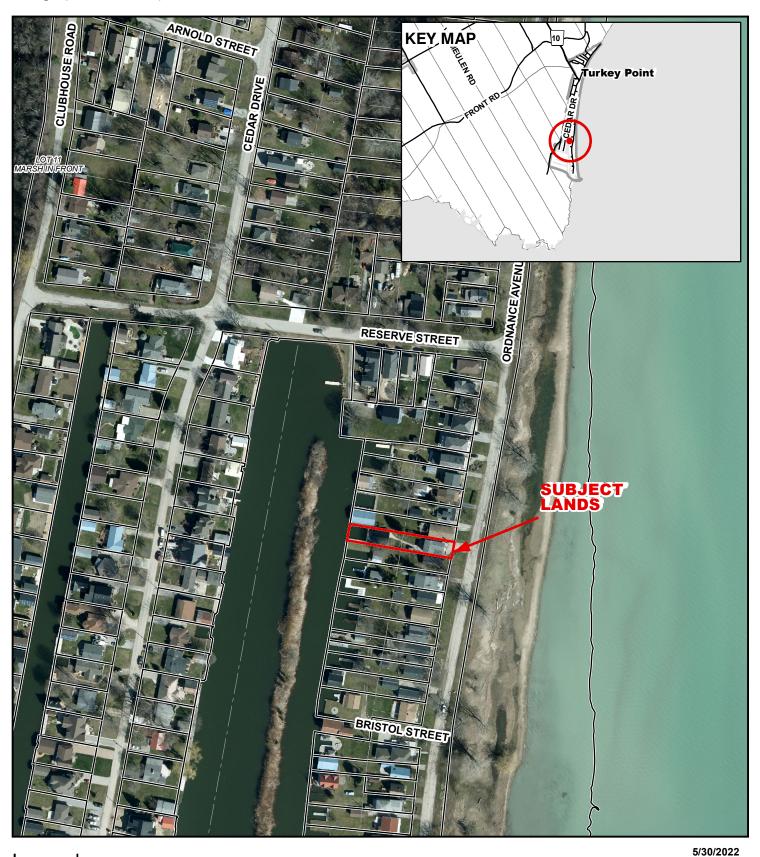

Legend



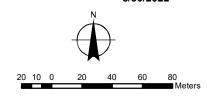

MAP B

ZONING BY-LAW MAP

Geographic Township of CHARLOTTEVILLE



LEGEND

Subject Lands

Adjacent Lands

Wetland

LPRCA Generic RegLines


ZONING BY-LAW 1-Z-2014

(H) - Holding

HL - Hazard Land Zone

PSW - Provincially Significant Wetland Zone


RR - Resort Residential Zone

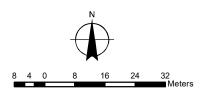


MAP C ANPL2022152


CONCEPTUAL PLAN

Geographic Township of CHARLOTTEVILLE

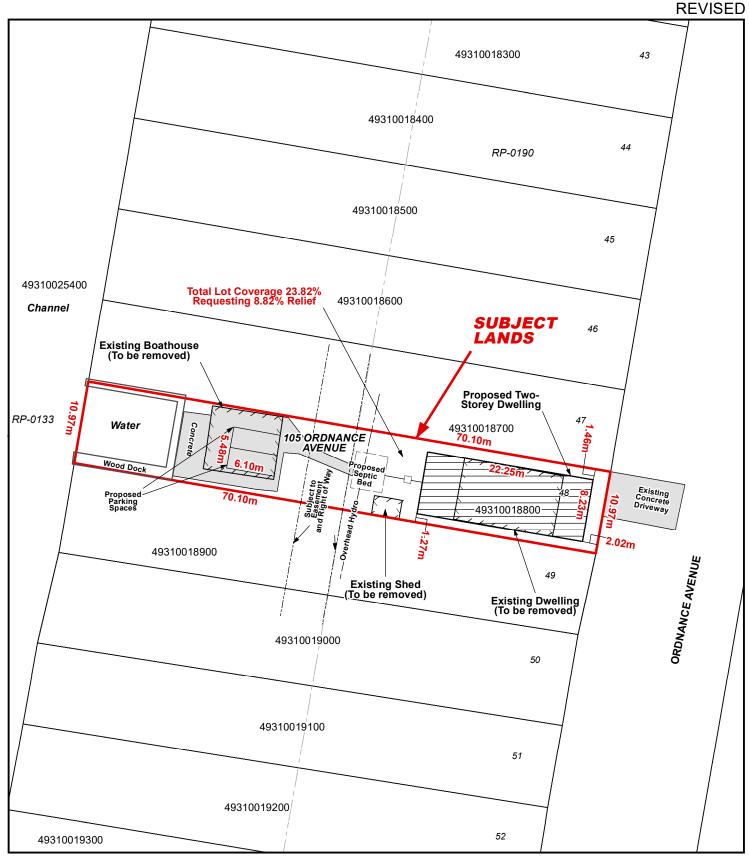


Legend

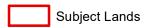

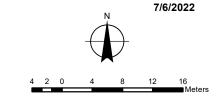

CONCEPTUAL PLAN

Geographic Township of CHARLOTTEVILLE

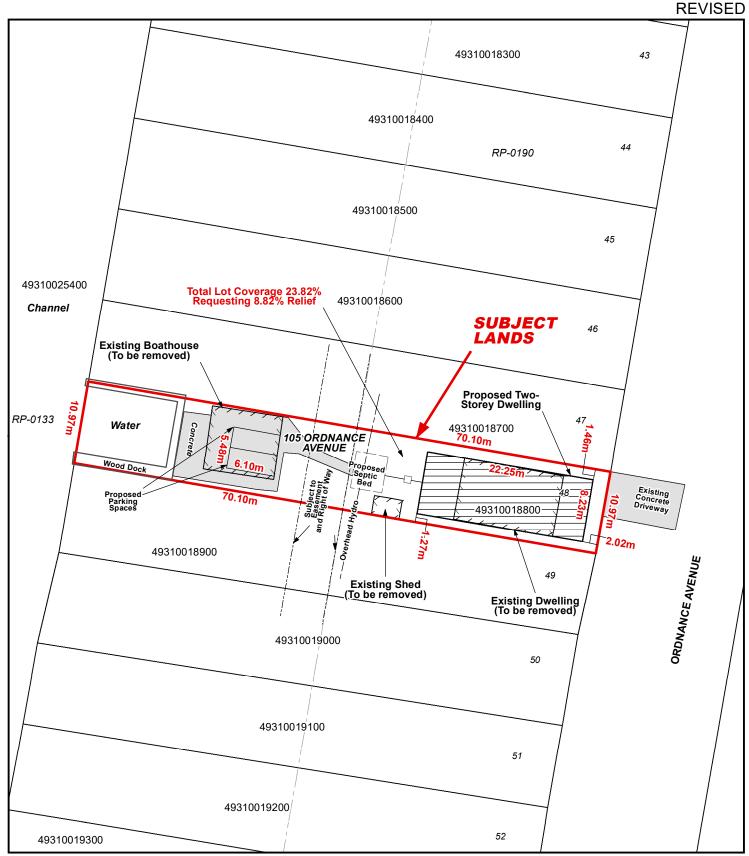

Legend

