For Office Use Only: File Number Related File Number Pre-consultation Meeting Application Submitted Complete Application	Application Fee Conservation Authority Fee Well & Septic Info Provided Planner Public Notice Sign
Check the type of plan	nning application(s) you are submitting.
	/Boundary Adjustment ing Severance and Zoning By-law Amendment // Way
Property Assessment	Roll Number: 49311044400
A. Applicant Informati	
Name of Owner	Kim & Karen Coulter
It is the responsibility of ownership within 30 day	the owner or applicant to notify the planner of any changes in so of such a change.
Address	25 Cedar Drive
Town and Postal Code	Turkey Point NOE 1PO
Phone Number	+1 (905) 320-7271
Cell Number	Same as above
Email	Kcoulter 5@me. Com; Karen 9754@ichoud.
Name of Applicant	Claude Dalm
Address	6 Cedar Street
Town and Postal Code	Ingersell NJC 1A7
Phone Number	519-550-1307
Cell Number	Some as above
Email	_design@dalm.ca



Name of Agent	_ (laude	Dalm	
Address	_ 6 Ccla	- Street	
Town and Postal Code	Ingerse	U NSC	1A7
Phone Number	519-550		
Cell Number	519-550	- 1307	
Email	design co	lab, ca	
Please specify to whom all correspondence and owner and agent noted a	all communications should notices in respect of this a above.	be sent. Unless ot be for be sent.	herwise directed, warded to the
□ Owner	Agent	☐ Applicant	
	corintian and Durant L		
Legal Description (inc Block Number and Ur	le in front of	p, Concession Num	A PT WT
B. Location, Legal De 1. Legal Description (incomplete and Ur F. Charlottey:	clude Geographic Townshi ban Area or Hamlet): It in front of	p, Concession Num	A PT WT
B. Location, Legal De 1. Legal Description (incomplete and Ur F. Charlottey:	Blude Geographic Townshinds an Area or Hamlet): 12 in front of PT LOT G AN	p, Concession Num	A PT LOT LAU1 PARTS 2
B. Location, Legal De 1. Legal Description (incomplete and Ur F. Charlottey: PLAU 135	PT LOT G AN	Concession Num Concession No RP 37RG Drive, Tu	A PT WT 1941 PARTS 2 arkey Point
B. Location, Legal De 1. Legal Description (incomplete Number and Ur F. Charlottevil PLAU 135 Municipal Civic Addre	Slude Geographic Townshirban Area or Hamlet): 18 in front of PT LOT G AN 25 Cedag Designation(s): Resa	Concession Num Concession No Rp 37RG	A PT WT 1941 PARTS 2
B. Location, Legal De 1. Legal Description (incomplete Number and Ur F. Charlottevil PLAU 135 Municipal Civic Addre Present Official Plan I Present Zoning:	clude Geographic Townshirban Area or Hamlet): 18 in front of PT LOT G AN 25 Cedas Designation(s): Resa	p, Concession Num Concession Oncession Oncession Oncession To 37RG Drive, To t Resident destial (A PT LOT 1941 PARTS 2 rtcey Point and Designa RR)
B. Location, Legal De 1. Legal Description (incomplete Number and Ur F. Charlottevil PLAU 135 Municipal Civic Addre Present Official Plan I Present Zoning:	clude Geographic Townshirban Area or Hamlet): 12 in front of PT LOT GAN SS: 25 Cedas Designation(s): Resair Resort Res	p, Concession Num Concession Oncession Oncession Oncession To 37RG Drive, To t Resident destial (A PT LOT 1941 PARTS 2 rtcey Point and Designa RR)
B. Location, Legal De 1. Legal Description (incomplete Number and Ur PLAU 135 Municipal Civic Addre Present Official Plan I Present Zoning: 2. Is there a special prov Yes X No If yes, 3. Present use of the sub	clude Geographic Townshirban Area or Hamlet): 12 in font of PT Lot of AM SS: 25 Cedag Designation(s): Resart Resart Res ision or site specific zone please specify:	p, Concession Num (on cession 1) RP 37RG Drive, To t Resident dential (on the subject lands	A PT LOT LANT PARTS 2 LICENT POINT Lad Designa RR)
B. Location, Legal De 1. Legal Description (incomplete Number and Ur PLAN LOCAL 135 Municipal Civic Addre Present Official Plan Description Present Zoning: 2. Is there a special proving Yes X No If yes,	clude Geographic Townshirban Area or Hamlet): 12 in font of PT Lot of AN ss: 25 Cedag Designation(s): Resart Resart Res ision or site specific zone please specify:	p, Concession Num (on cession 1) RP 37RG Drive, To t Resident dential (on the subject lands	A PT LOT LANT PARTS 2 LICENT POINT Lad Designa RR)



whether they are to be retained, demolished or removed. If retaining the building structures, please describe the type of buildings or structures, and illustrate the setback, in metric units, from front, rear and side lot lines, ground floor area, gr floor area, lot coverage, number of storeys, width, length, and height on your attached sketch which must be included with your application: Single of the control of the cont	е
5. If an addition to an existing building is being proposed, please explain what it w used for (for example a bedroom, kitchen, or bathroom). If new fixtures are proposed, please describe. The the addition will be used for a how theatre and office space.	vill be
6. Please describe all proposed buildings or structures/additions on the subject la Describe the type of buildings or structures/additions, and illustrate the setback metric units, from front, rear and side lot lines, ground floor area, gross floor are coverage, number of storeys, width, length, and height on your attached sketch which must be included with your application: Proposed 1-Storey addition to be built blue Cottage and shed with footprint of 43.1 m² height of addition from grade to milput of coff. 7. Are any existing buildings on the subject lands designated under the Ontario Heritage Act as being architecturally and/or historically significant? Yes □ No If yes, identify and provide details of the building:	Proposed is 6.43m
8. If known, the length of time the existing uses have continued on the subject land	ds:
9. Existing use of abutting properties: Resort Residential - Seasonal (ottages	
10. Are there any easements or restrictive covenants affecting the subject lands?	
Yes \(No \) If yes, describe the easement or restrictive covenant and its effect there is a hydro ensemble at the back of probutit will be moved in the fall. Hydro one is next the lines. Revised April	openty Supposed
NOT/OIK Committee of Adjustment Development Appli	il 2023 lication 3 of 13

C. Purpose of Development Application

Note: Please complete all that apply. Failure to complete this section will result in an incomplete application.

1. Site Information (Please refer to Zoning By-law to confirm permitted dimensions)

	Existing	Permitted	Provision	Proposed	Deficiency
Lot frontage	15.429m				
Lot depth	81.686m				
Lot width	14.71m				
Lot area	1075.6m^2				
Lot coverage	20.1%	15%	5.8.2 h)	24.1%	4%
Front yard	6m	6m	5.8.2 c)	N/A	
Rear yard	31.67m	9m	5.8.2 f)	N/A	
Height	5.82m	9.1m	5.8.2 g)	8.18m	
Left Interior side yard	1.36m	1.2m	5.8.2 e)	1.36m	
Right Interior side yard	3.37m	1.2m	5.8.2 e)	5.1m	
Exterior side yard (corner lot)					
Parking Spaces (number)					
Aisle width					
Stall size					
Loading Spaces					
Other					



7	2. Please explain why it is not possible to comply with the provision(s) of the Zoning
	By-law:
	The proposed addition exceeds the allowable 100 coverage of 15%. The owners need more
	They to a hour office & scotall since the suit
	become their permanent residence.
N/H 3	. Consent/Severance/Boundary Adjustment: Description of land intended to be
	severed in metric units: Frontage:
	Depth:
	Width:
	Lot Area:
	Present Use:
	Proposed Use:
	Proposed final lot size (if boundary adjustment):
	If a boundary adjustment, identify the assessment roll number and property owner of
	the lands to which the parcel will be added:
	Description of land intended to be retained in metric units: Frontage:
	Depth:
	Width:
	Lot Area:
	D
	D
	Proposed Use:
	Buildings on retained land:
(IA	
3/1/4.	Easement/Right-of-Way: Description of proposed right-of-way/easement in metric units:
	Frontage:
	Depth:
	- Dopul



	Width:
	Area:
	Proposed Use:
7	 Surplus Farm Dwelling Severances Only: List all properties in Norfolk County, which are owned and farmed by the applicant and involved in the farm operation
â	Owners Name:
	Roll Number:
1	Total Acreage:
1	Workable Acreage:
I	Existing Farm Type: (for example: corn, orchard, livestock)
1	Dwelling Present?: ☐ Yes ☐ No If yes, year dwelling built
[Date of Land Purchase:
7 V E	Roll Number: Fotal Acreage: Workable Acreage: Existing Farm Type: (for example: corn, orchard, livestock) Dwelling Present?: Yes No If yes, year dwelling built
	Date of Land Purchase:
F	Owners Name: Roll Number: otal Acreage:
	Vorkable Acreage:
	xisting Farm Type: (for example: corn, orchard, livestock)
D	welling Present?: Yes No If yes, year dwelling built
D	ate of Land Purchase:



Roll Number:
Total Acreage:
Workable Acreage:
Existing Farm Type: (for example: corn, orchard, livestock)
Dwelling Present?: ☐ Yes ☐ No If yes, year dwelling built
Date of Land Purchase:
Owners Name:
Roll Number:
Total Acreage:
Workable Acreage:
Existing Farm Type: (for example: corn, orchard, livestock)
Dwelling Present?: ☐ Yes ☐ No If yes, year dwelling built
Date of Land Purchase:
Note: If additional space is needed please attach a separate sheet.
D. All Applications: Previous Use of the Property
 Has there been an industrial or commercial use on the subject lands or adjacent lands? ☐ Yes ☒ No ☐ Unknown
If yes, specify the uses (for example: gas station, or petroleum storage):
 Is there reason to believe the subject lands may have been contaminated by forme uses on the site or adjacent sites? ☐ Yes ☐ No ☐ Unknown
2. Provide the information you used to determine the answers to the above questions:



4.	If you answered yes to any of the above questions in Section D, a previous use inventory showing all known former uses of the subject lands, or if appropriate, the adjacent lands, is needed. Is the previous use inventory attached? ☐ Yes ☐ No				
E.	All Applications: Provincial Policy				
1.	Is the requested amendment consistent with the provincial policy statements issued under subsection 3(1) of the <i>Planning Act, R.S.O.</i> 1990, c. P. 13? ★ Yes □ No				
	If no, please explain:				
2.	provincial legislation, municipal by-laws or other agency approvals, including the Endangered Species Act, 2007. Have the subject lands been screened to ensure that development or site alteration will not have any impact on the habitat for endangered or threatened species further to the provincial policy statement subsection 2.1.7? Yes X. No N/A If no, please explain: Doesn't apply. The proposed add tion will be built because Servetures where are no existing habitats.				
3.	Have the subject lands been screened to ensure that development or site alteration will not have any impact on source water protection? ☐ Yes ✗ No				
	If no, please explain: Doesn't apply, Proposed is built between Structures on proposed and away from any surrice wate Note: If in an area of source water Wellhead Protection Area (WHPA) A, B or C please attach relevant information and approved mitigation measures from the Risk Manager Official.				



4	All Applications: Are any of the following uses or features on the subject lands or within 500 metres of the subject lands, unless otherwise specified? Please check boxes, if applicable.
NA	Livestock facility or stockyard (submit MDS Calculation with application)
10/11	☐ On the subject lands or ☐ within 500 meters – distance
	Wooded area ☐ On the subject lands or within 500 meters - distance Forced Rehind
NIA	Wooded area □ On the subject lands or within 500 meters – distance Forcst Rehind Property > 100 ft from real of exist 120d
NIA	Sewage treatment plant or waste stabilization plant ☐ On the subject lands or ☐ within 500 meters – distance
	Provincially significant wetland (class 1, 2 or 3) or other environmental feature On the subject lands or within 500 meters – distance
VIA	Floodplain ☐ On the subject lands or ☐ within 500 meters – distance
1	Rehabilitated mine site ☐ On the subject lands or ☐ within 500 meters – distance
	Non-operating mine site within one kilometre ☐ On the subject lands or ☐ within 500 meters – distance
	Active mine site within one kilometre ☐ On the subject lands or ☐ within 500 meters – distance
s ils	Industrial or commercial use (specify the use(s)) ☐ On the subject lands or ☐ within 500 meters – distance
	Active railway line ☐ On the subject lands or ☐ within 500 meters – distance
	Seasonal wetness of lands ☐ On the subject lands or ☐ within 500 meters – distance
	Erosion ☐ On the subject lands or ☐ within 500 meters – distance
	Abandoned gas wells ☐ On the subject lands or ☐ within 500 meters – distance



	All Applications: Servicing and Access	CC 5128 Vin (SAV)		
1.	Indicate what services are available or proposed: Water Supply	Available but not affected by proposed addition		
	Municipal piped water	☐ Communal wells		
	☐ Individual wells	☐ Other (describe below)		
	Sewage Treatment			
	☐ Municipal sewers	☐ Communal system		
	□ Septic tank and tile bed in good working order ##################################			
	Storm Drainage			
	☐ Storm sewers	☐ Open ditches		
	□ Other (describe below) NA			
2.	Existing or proposed access to subject lands:			
69	Municipal road	☐ Provincial highway		
	☐ Unopened road	☐ Other (describe below)		
	Name of road/street: Cedar Drive			
i.	All Applications: Other Information			
	Does the application involve a local business? \Box \	res No		
If yes, how many people are employed on the subject lands?				
	Is there any other information that you think may be useful in the review of this application? If so, explain below or attach on a separate page.			



H. Supporting Material to be submitted by Applicant

In order for your application to be considered complete, folded hard copies (number of paper copies as directed by the planner) and an **electronic version (PDF) of the site plan drawings, additional plans, studies and reports** will be required, including but not limited to the following details:

- Concept/Layout Plan
- 2. All measurements in metric
- 3. Existing and proposed easements and right of ways
- 4. Parking space totals required and proposed
- 5. All dimensions of the subject lands
- Dimensions and setbacks of all buildings and structures
- Location and setbacks of septic system and well from all existing and proposed lot lines, and all existing and proposed structures
- 8. Names of adjacent streets
- 9. Natural features, watercourses and trees

In addition, the following additional plans, studies and reports, including but not limited to, may also be required as part of the complete application submission:

On-Site Sewage Disposal System Evaluation Form (to verify location and condition)

Environmental Impact Study

Geotechnical Study / Hydrogeological Review

Minimum Distance Separation Schedule

Record of Site Condition

Your development approval might also be dependent on Ministry of Environment Conservation and Parks, Ministry of Transportation or other relevant federal or provincial legislation, municipal by-laws or other agency approvals.

All final plans must include the owner's signature as well as the engineer's signature and seal.



I. Transfers, Easements and Postponement of Interest

The owner acknowledges and agrees that if required it is their solicitor's responsibility on behalf of the owner for the registration of all transfer(s) of land to the County, and/or transfer(s) of easement in favour of the County and/or utilities. Also, the owner further acknowledges and agrees that it is their solicitor's responsibility on behalf of the owner for the registration of postponements of any charges in favour of the County.

Permission to Enter Subject Lands

Permission is hereby granted to Norfolk County officers, employees or agents, to enter the premises subject to this application for the purposes of making inspections associated with this application, during normal and reasonable working hours.

Freedom of Information

For the purposes of the Municipal Freedom of Init I authorize and consent to the use by or the disclinformation that is collected under the authority of 13 for the purposes of processing this application	osure to any person or public body an f the Planning Act, R.S.O. 1990, c. P.
Owner/Applicant/Agent Signature	Date
J. Owner's Authorization	
If the applicant/agent is not the registered owner of application, the owner must complete the authorized when the complete the	zation set out below.
/We authorize my/our behalf and to provide any of my/our perso processing of this application. Moreover, this sha authorization for so doing.	nal information necessary for the
Owner	Date

*Note: If property is owned by an Ontario Ltd. Corporation, Articles of Incorporation are required to be attached to the application.


Owner



Date

K. Declaration		
1. Clande	Dahn of.	Ingersoll, ON
solemnly declare that:		0
transmitted herewith are tru	ie and I make this s nowing that it is of t	s contained in all of the exhibits solemn declaration conscientiously the same force and effect as if made ence Act.
Declared before me at:		B 1
- Simcoe,	DNT	- CHALL
In NorFOLK	Courry	Owner/Applicant/Agent Signature
This 18^{16} day of 4	NOTE DOJS	
A.D., 20 <u>35</u>		
- MAOC	Sherry Ann Mott, a Commissioner, etc., for the Corporation Expires March 16 2	Province of Ontario.
A Commissioner, etc.	Expires March 16, 20	026,



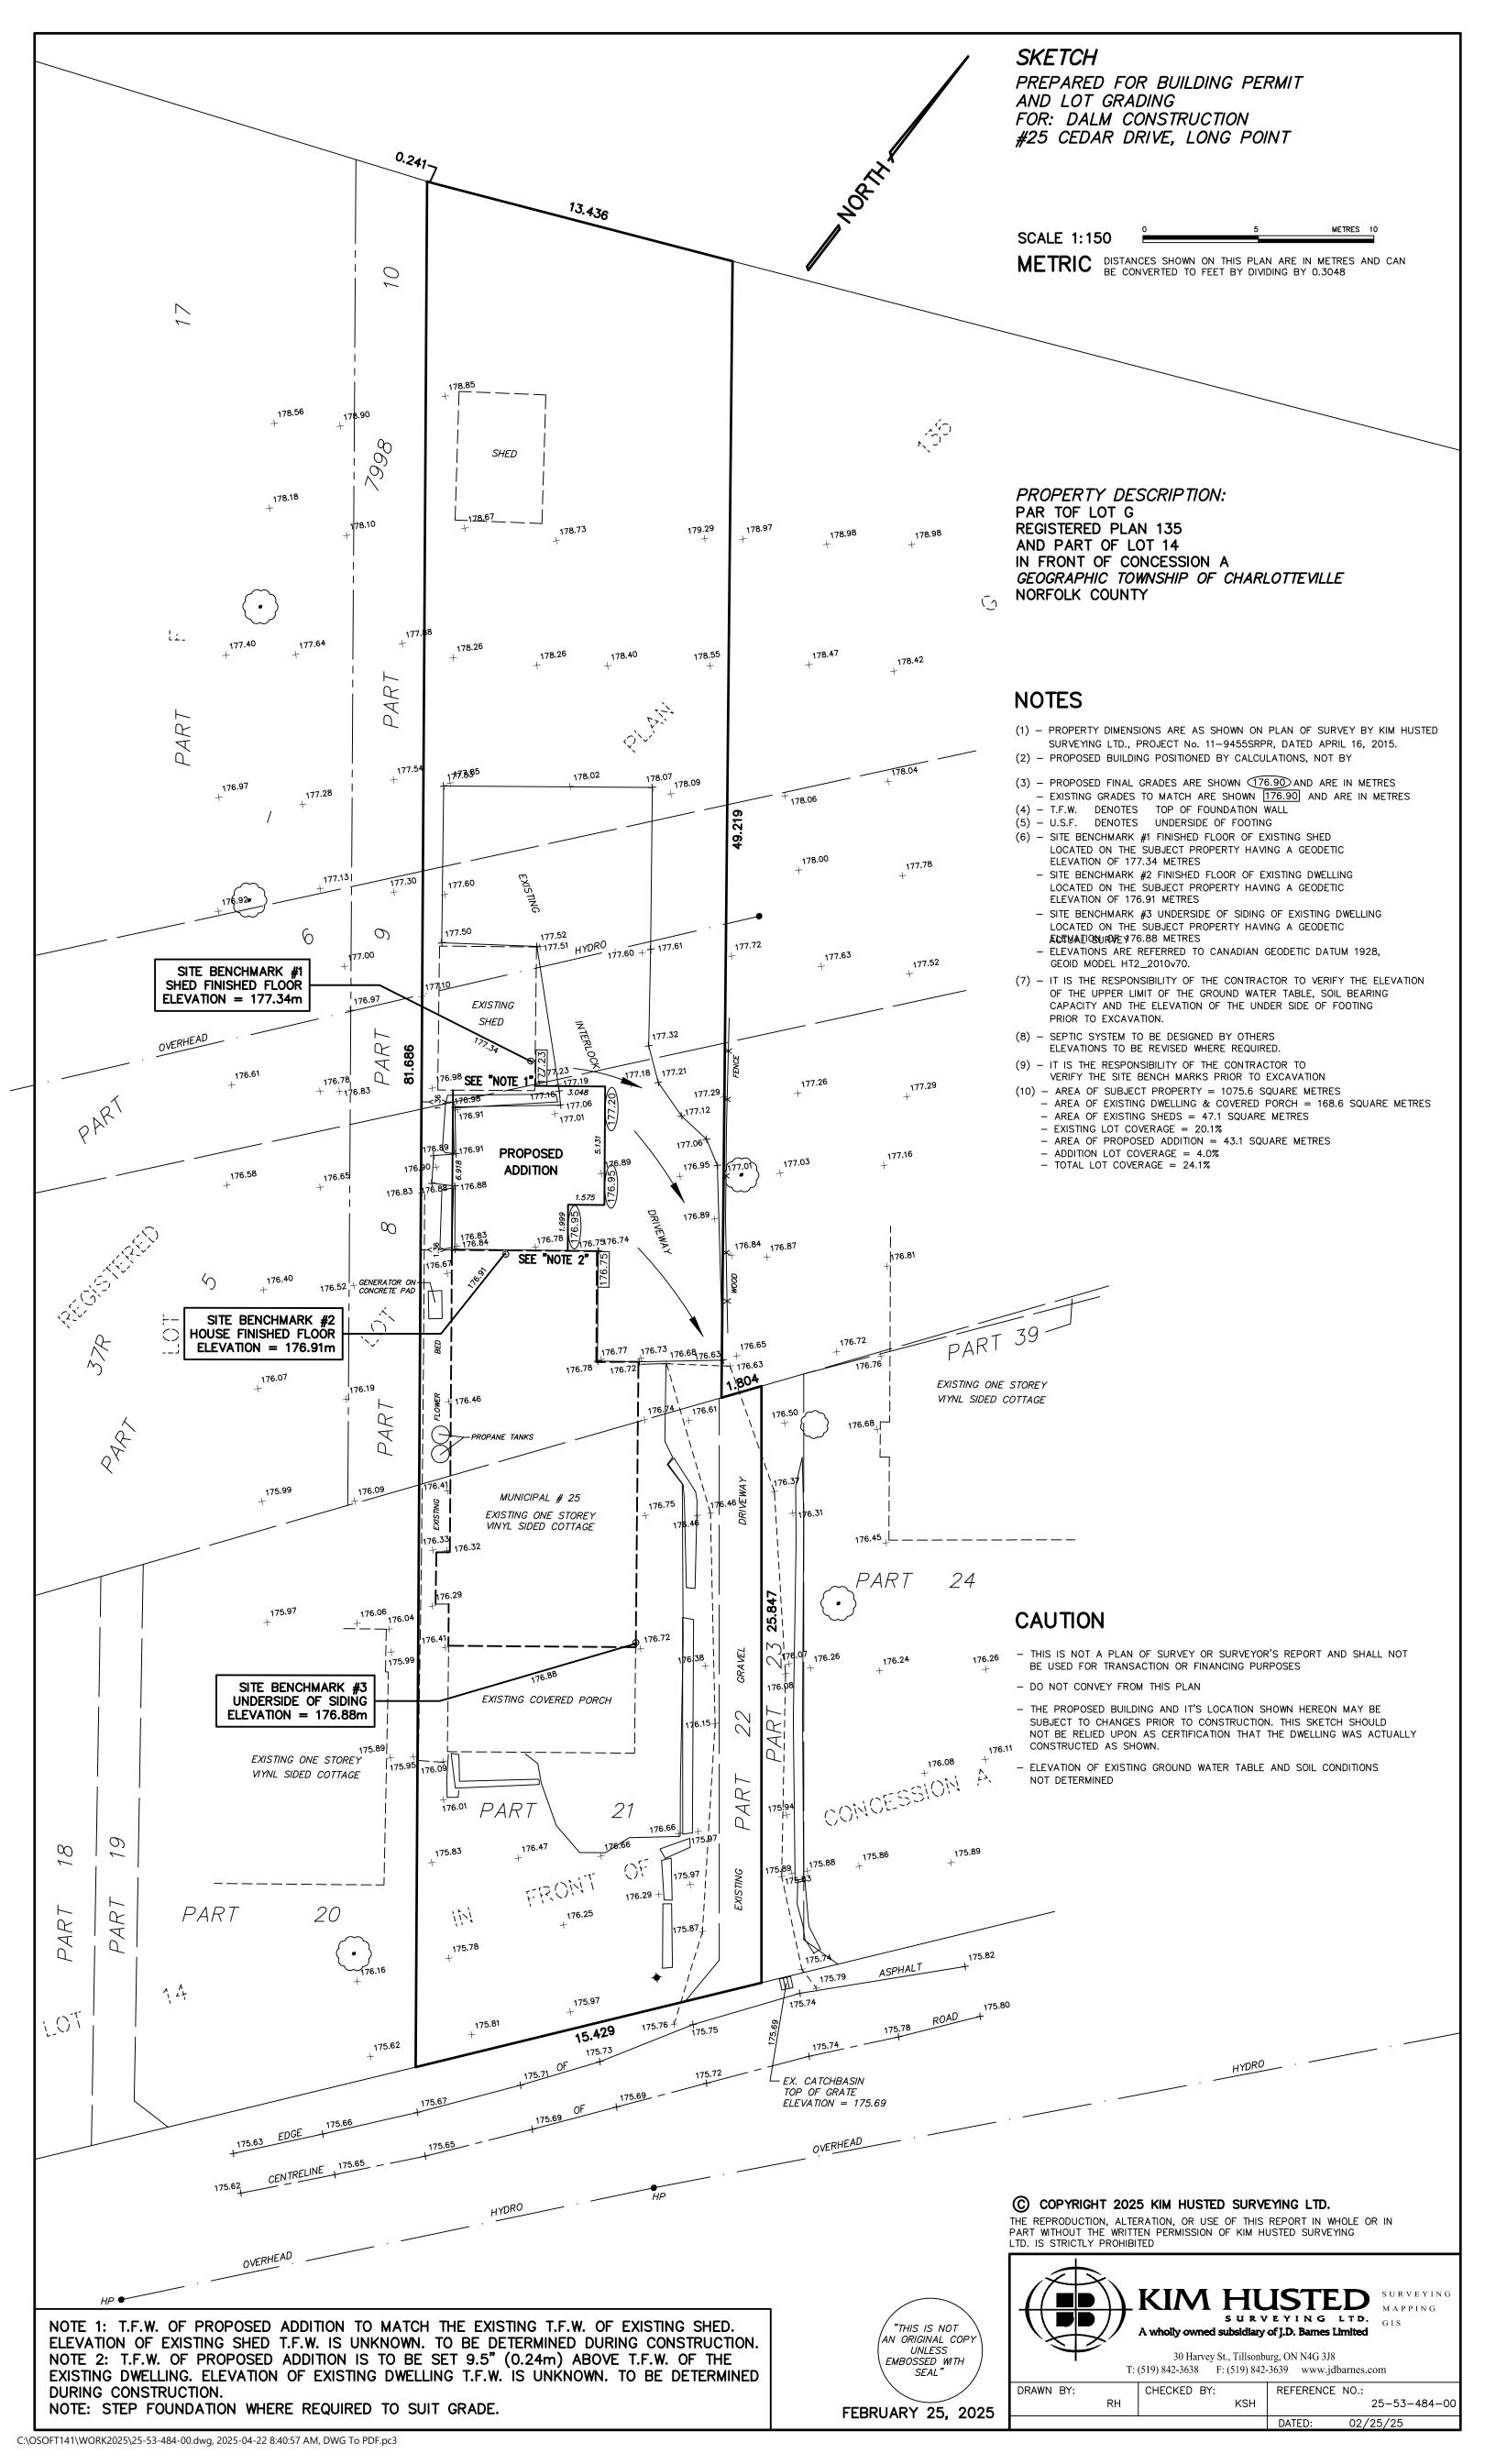



Long Point Region Conservation Authority

PERMIT No. LPRCA-94/25

PROHIBITED ACTIVITES, EXEMPTIONS AND PERMITS (CONSERVATION AUTHORITIES ACT - ONTARIO REGULATION 41/24)

4 Elm Street Tillsonburg, ON N4G 0C4 Phone (519) 842-4242 Fax (519) 842-7123 www.lprca.on.ca

Applicant:	Kim and Karen Coulter	Telephone:	905-320-7271
Address:	12 Stoneridge Crescent Niagara on	Email:	Kcoulter5@me.com
	the Lake. L0S 1P0	_	
Agent:	Claudius Dalm	Telephone:	519-550-1307
Address:	6 Cedar Street, Ingersoll	Email:	design@dalm.ca
		_	
			·
Location/Address of	works: 25 Codar Drivo 221040211044400		
Location/Address of	works: 25 Cedar Drive. 331049311044400		
Location/Address of	works: 25 Cedar Drive. 331049311044400 14 Concession:	A Municipality:	Norfolk County
Lot:	14 Concession:	<u> </u>	
	14 Concession:	<u> </u>	
Lot:	14 Concession:	<u> </u>	
Lot:	14 Concession:	<u> </u>	
Lot:	14 Concession:	<u> </u>	

This permit is valid on the above location only for the period of:

DATE: June 6, 2025 to June 6, 2027

This permit shall be subject to the following conditions:

The Applicant and owner, by acceptance of and in consideration of the issuance of this permit, agrees to the following conditions:

GENERAL CONDITIONS: (SEE REVERSE SIDE OF PERMIT)

SPECIFIC CONDITIONS:

1. Locations and dimensions of proposed works must be as indicated on the enclosed copy of the work permit application dated May 1, 2025 and the associated information.

GENERAL CONDITIONS:

- 1. This permit does not preclude any approvals required by any other laws or regulations.
- 2. Temporary sediment & erosion control measures shall be installed around any disturbed and/or exposed ground or excavated material stockpiles, remain in place until the site has been suitably stabilized, and must be monitored regularly to ensure effectiveness. Remedial/Emergency measures must be taken at any sign of failure. This step is considered necessary to prevent the undesirable migration of silt.
- 3. The Conservation Authority should be contacted within 48 hours prior to the commencement of construction.
- 4. Authorized representatives of the Long Point Region Conservation Authority may at any time enter onto the lands which are described herein in order to make any surveys, examinations or inspections which are required for the purpose of insuring that the work(s) authorized by this permit are being carried out according to the terms of this permit.
- 5. It is the responsibility of the permittee to ensure the development is located within the extent of the property boundaries owned by the proponent.
- This permit is not assignable.
- 7. The project shall be carried out generally as per the plans submitted in support of the application as they may be amended by conditions of this permit.
- 8. This approval does not guarantee the soundness of the proposed work and it is the responsibility of the permittee to monitor and maintain the construction activity to ensure the integrity of the work.
- 9. The applicant agrees to maintain all existing drainage patterns.
- 10. Any activity or development other than that identified in this permit application must be reviewed by the LPRCA; at which time, staff will determine if additional approvals or an amended permit will be required.
- 11. Permits are valid for two years. No notice will be issued on expiration of the permit and it is the responsibility of the permittee to ensure a valid permit is in effect at the time work is occurring.



Long Point Region Conservation Authority

4 Elm Street, Tillsonburg, ON N4G 0C4 Tel: (519) 842-4242 Fax: (519) 842-7123

Email: planning@lprca.on.ca Website: www.lprca.on.ca

Permit Application - Schedule A

PROHIBITED ACTIVITIES, EXEMPTIONS AND PERMITS (O. Reg. 41/24)

Owner's Contact Information:	
Name: Kim & Karen Coulter	E-mail: Kconter 50 me can
Mailing Address: 12 Stoneridge Cres	Postal Code: LOS 151
City/Town: St. Davids	Primary Phone: +1-905-320-7271
Agent/Consultant/Contractor's Contact Information:	
Name: Claudius Dalm	E-mail: designedalm.ca Postal Code: NITC 117
Mailing Address: 6 Cedar Street	NOCIAT
City/Town: Ingers all	Primary Phone: 519 - 550 - 1307
Location of Proposed Work:	
Municipal Address: 25 Cedar Dri	il
Tax Assessment Roll Number: 331049311	0000000
City/Town: Turkey Point Towns	hip: Norfolk County
Lot: Conces	ssion/Plan: 37R1941 PARTS ZI& ZZ
Proposed Work: (Check all appropriate boxes) ☐ Place, dump, remove fill ☐ Site grading ☐ Construct a new building or structure ☐ Alter or renovate an existing building or structure ☐ Construct or replace a septic system ☐ Construct erosion control or shoreline protection ☐ Construction of new, or replacement of an existing water ☐ Other:	of Lot Go Uition to existing Cottoge

Description of Proposed Works:

Portion of exito to be remered	sting interlo	keel	driveway
to be remered	between	ex.	sting.
Shed and	Cottage. 46	6.36	12
2- Storey as	lditim to	bee	
2- Storey as constructed height of ado	between.	Forma	lation
height of ado	ditin to be	Set	to mater
existing	grale		
Pre-consultation Completed:		AT.	
Proposed Start Date:	Siprember	150	
Proposed Completion Date:	April 1st		
Existing square footage:	, C		
Proposed square footage:	1814,1 ft2		
Quantity of fill (m³) if applicable:	N/A		
I understand that the information con			
and that the staff of the Long Point I inspection of the subject lands as pa		LPRCA) will (undertake a detailed
Signature of Owner:	Gulter	Date:	5/2/2025
Signature of Agent:	1	Date:	E /11/2000

5/1/2025

Prohibited Activities, Exemptions and Permits Ontario Regulation 41/24

PROPERTY OWNER AUTHORIZATION

Subject Pro	perty:
Municipal Ac	15 leder Vr. Je
Municipality:	Turkey Port
I/We:	KIM & KAREN
Hereby Auth	Turkey Port KIM & KAREN Orize: Claudius Dalm
any hearing(s the application	enclosed application to the Long Point Region Conservation Authority, to appear on my behalf a of the application, and to provide any information or materials required by the Board relevant to a for the purposes of obtaining permission to develop, interfere with a wetland, or alter a shoreline in accordance with the requirements of Ontario Regulated 41/24 as amended.
Signature of	Owner: James Os of 2025
Please	copy the Owner on correspondence between the Conservation Authority and Agent.
	APPLICATION FORM INSTRUCTIONS
Owner	The legal owner(s) of the property where the proposed development or alteration will be carried out
Agent	If the owner has assigned another party as an agent to act on the owner's behalf for the project, written authorization from the owner is required
Quantity of Fill	Approximate quantity expressed in cubic metres, cubic yards, trucks loads (12 yards) or tandem truck loads (18 yards)

For residential development, area of living space including full height basement and additional storeys,

but not including attached garage, non-habitable crawl space, open breezeways, decks, or porches

Floor Area

APPLICATION CHECKLIST

Submission: LPRCA permit applications along with supporting information may be submitted in person to our office, by email, or mail.

<u>Pre-consultation</u>: Please contact LPRCA staff regarding the requirements specific to your proposal. Also, please make sure your contractors and consultants contact LPRCA staff before completing detailed drawings or technical studies.

contrac	ctors and consultants contact LPRCA staff before completing detailed drawings or technical studies.
Comple	ete application: A complete application package includes (check all applicable):
⊠ 1.	A plan of the area showing the property boundary, type and location of the proposed development activity, or a plan of the area showing the plan view and cross-section details of an activity to straighten, change, divert, or interfere with the existing channel of a river, creek, stream or watercourse, including a change or interference with a wetland.
☑ 2.	The elevations of existing buildings, if any, as well as grades and the proposed elevations of any buildings and grades after the development activity or other activity.
⊠ 3.	The proposed use of any buildings and structures following completion of the development activity or a statement of the purpose of an activity to straighten, change, divert, or interfere with the existing channel of a river, creek, stream or watercourse, including changes or interference with a wetland.
□ 4.	A description of the methods to be used in carrying out an activity to straighten, change, divert, or interfere with the existing channel of a river, creek, stream, or watercourse, including changes or interference with a wetland.
☐ 5.	Drainage details before and after the development activity or other activity.
☐ 6.	A complete description of any type of fill proposed to be placed or dumped.
X 7.	The start and completion dates of the development activity or other activity.
8	A confirmation of authorization for the proposed development activity or other activity given by the owner of the subject property, if the applicant is not the owner
9.	Any other technical information, studies, or plans that the authority requests, including information requested during pre- submission consultations between the authority and the applicant.
Technic	cal Reports: One or more of the following technical reports may be required (advised by LPRCA staff)
□ 1.	Design drawings and description of the design elements for flood-proofing measures, stamped and certified by a qualified professional engineer (for development in floodplains and flood hazard areas).
2.	Slope stability study and erosion analysis, prepared by a qualified professional with expertise in geotechnical engineering, to determine the stable top-of-bank, the minimum development setback to address the potential erosion hazards, and associated foundation, construction, grading, and drainage recommendations, in accordance with the Provincial Technical Guidelines (for development in erosion hazard areas).
3.	Geotechnical investigation, by a qualified professional geotechnical engineer, of site soil and groundwater conditions related to building foundation type and design requirements, in accordance with the Ontario Building Code to facilitate subsequent building permit (for development in area with organic soils).
4.	Coastal engineering assessment prepared by a qualified professional with expertise in coastal engineering in accordance with LPRCA's Shoreline Management Plan and the Provincial Technical Guidelines addressing hydrodynamic forces affecting the design and indicating how the aggravation of erosion on neighbouring properties is avoided (for shoreline alterations).
☐ 5.	Environmental Impact Study (EIS) clearly indicating that there will be no negative impact to the form or function of the wetland to the satisfaction of LPRCA (for development near wetlands).
6.	Hydraulic analysis by a qualified professional with expertise in water resource engineering addressing flood conveyance, storage-discharge, and changes in flood levels on-site and on adjacent properties (for development in floodplains, watercourse alterations).


7. Complex and large-scale proposals may require additional technical studies and plans.

GENERAL CONDITIONS OF PERMIT

- This permit does not absolve the permittee of the responsibility of obtaining necessary permission from applicable federal and provincial agencies or local municipalities.
- 2. The permittee agrees by acceptance of the permit:
 - a. To indemnify and save harmless, the Long Point Region Conservation Authority and its officers, employees, or agents from against all damage, injury, loss, costs, claims, demands, actions, and proceedings, arising out of or resulting from any act or omission of the permittee or of any of this agents, employees or contractors relating to any of the particular terms or conditions of this permit.
 - That this permit shall not release the permittee from any legal liability or obligation, and remains in force subject to all limitations, requirements, and liabilities imposed by law.
 - c. To provide certification of conformance to ensure compliance with the intent of the permit. This certification must be provided by an accredited professional and is to be submitted as may be specified in the permit.
- Authorized representatives of the Long Point Region Conservation Authority will be granted entry at any time into lands
 which are the subject of this permit application in order to make such surveys, examinations, investigations, inspections,
 or other arrangements which such representatives deem necessary.
- The project shall be carried out generally as per the plans submitted in support of the application as they may be amended by conditions of this permit.
- Any activity or development other than that identified in this permit application must be reviewed by the LPRCA; at which time, staff will determine if additional approvals or an amended permit will be required.
- The Long Point Region Conservation Authority may, with notice, cancel the permit or may change any of the conditions at any time if it is determined that the conditions of the permit have not been met.
- 7. Temporary sediment and erosion control measures shall be installed around any disturbed and/or exposed ground or excavated material stockpiles and remain in place until the site has been suitably stabilized, with regular monitoring to ensure effectiveness. Remedial/emergency measures must be taken at any sign of failure.
- 8. The applicant agrees to maintain all existing drainage patterns except as expressly identified in the permit.
- It is the responsibility of the permittee to ensure the development is located within the extent of the property boundaries owned by the proponent.
- 10. This approval does not guarantee the soundness of the proposed work and it is the responsibility of the permittee to monitor and maintain the construction activity to ensure the integrity of the work.
- 11. The permit shall not be assigned (non-transferrable).
- 12. Permits are valid for the period of time indicated on the permit. No notice will be issued on expiration of the permit and it is the responsibility of the permittee to ensure a valid permit is in effect at the time of work occurring.
- 13. The Conservation Authority should be contacted within 48 hours prior to the commencement of construction.
- 14. The Long Point Region Conservation Authority may make copies of Schedule A, as required, for the purposed of assessing the proposal and, when approved, to form part of the permit issued.

NOTICE OF COLLECTION

Pursuant to section 29(2) of the Municipal Freedom of Information and Protection of Individual Privacy Act, 1989, the personal information contained on this form is collected under the legal authority of the Conservation Authorities Act, R.S.O. 1980, c85, as amended. This information is used to assess applications for and, where approved, issue comment. The name of the applicant, location of the work and a description of the project may be published in LPRCA documents, including agendas, reports and meeting minutes which are posted on the LPRCA website. Questions about the collection of personal information should be directed to the Freedom of Information Coordinator, Long Point Region Conservation Authority, 4 Elm Street, Tillsonburg, Ontario, N4G 0C4, (519) 842-4242.

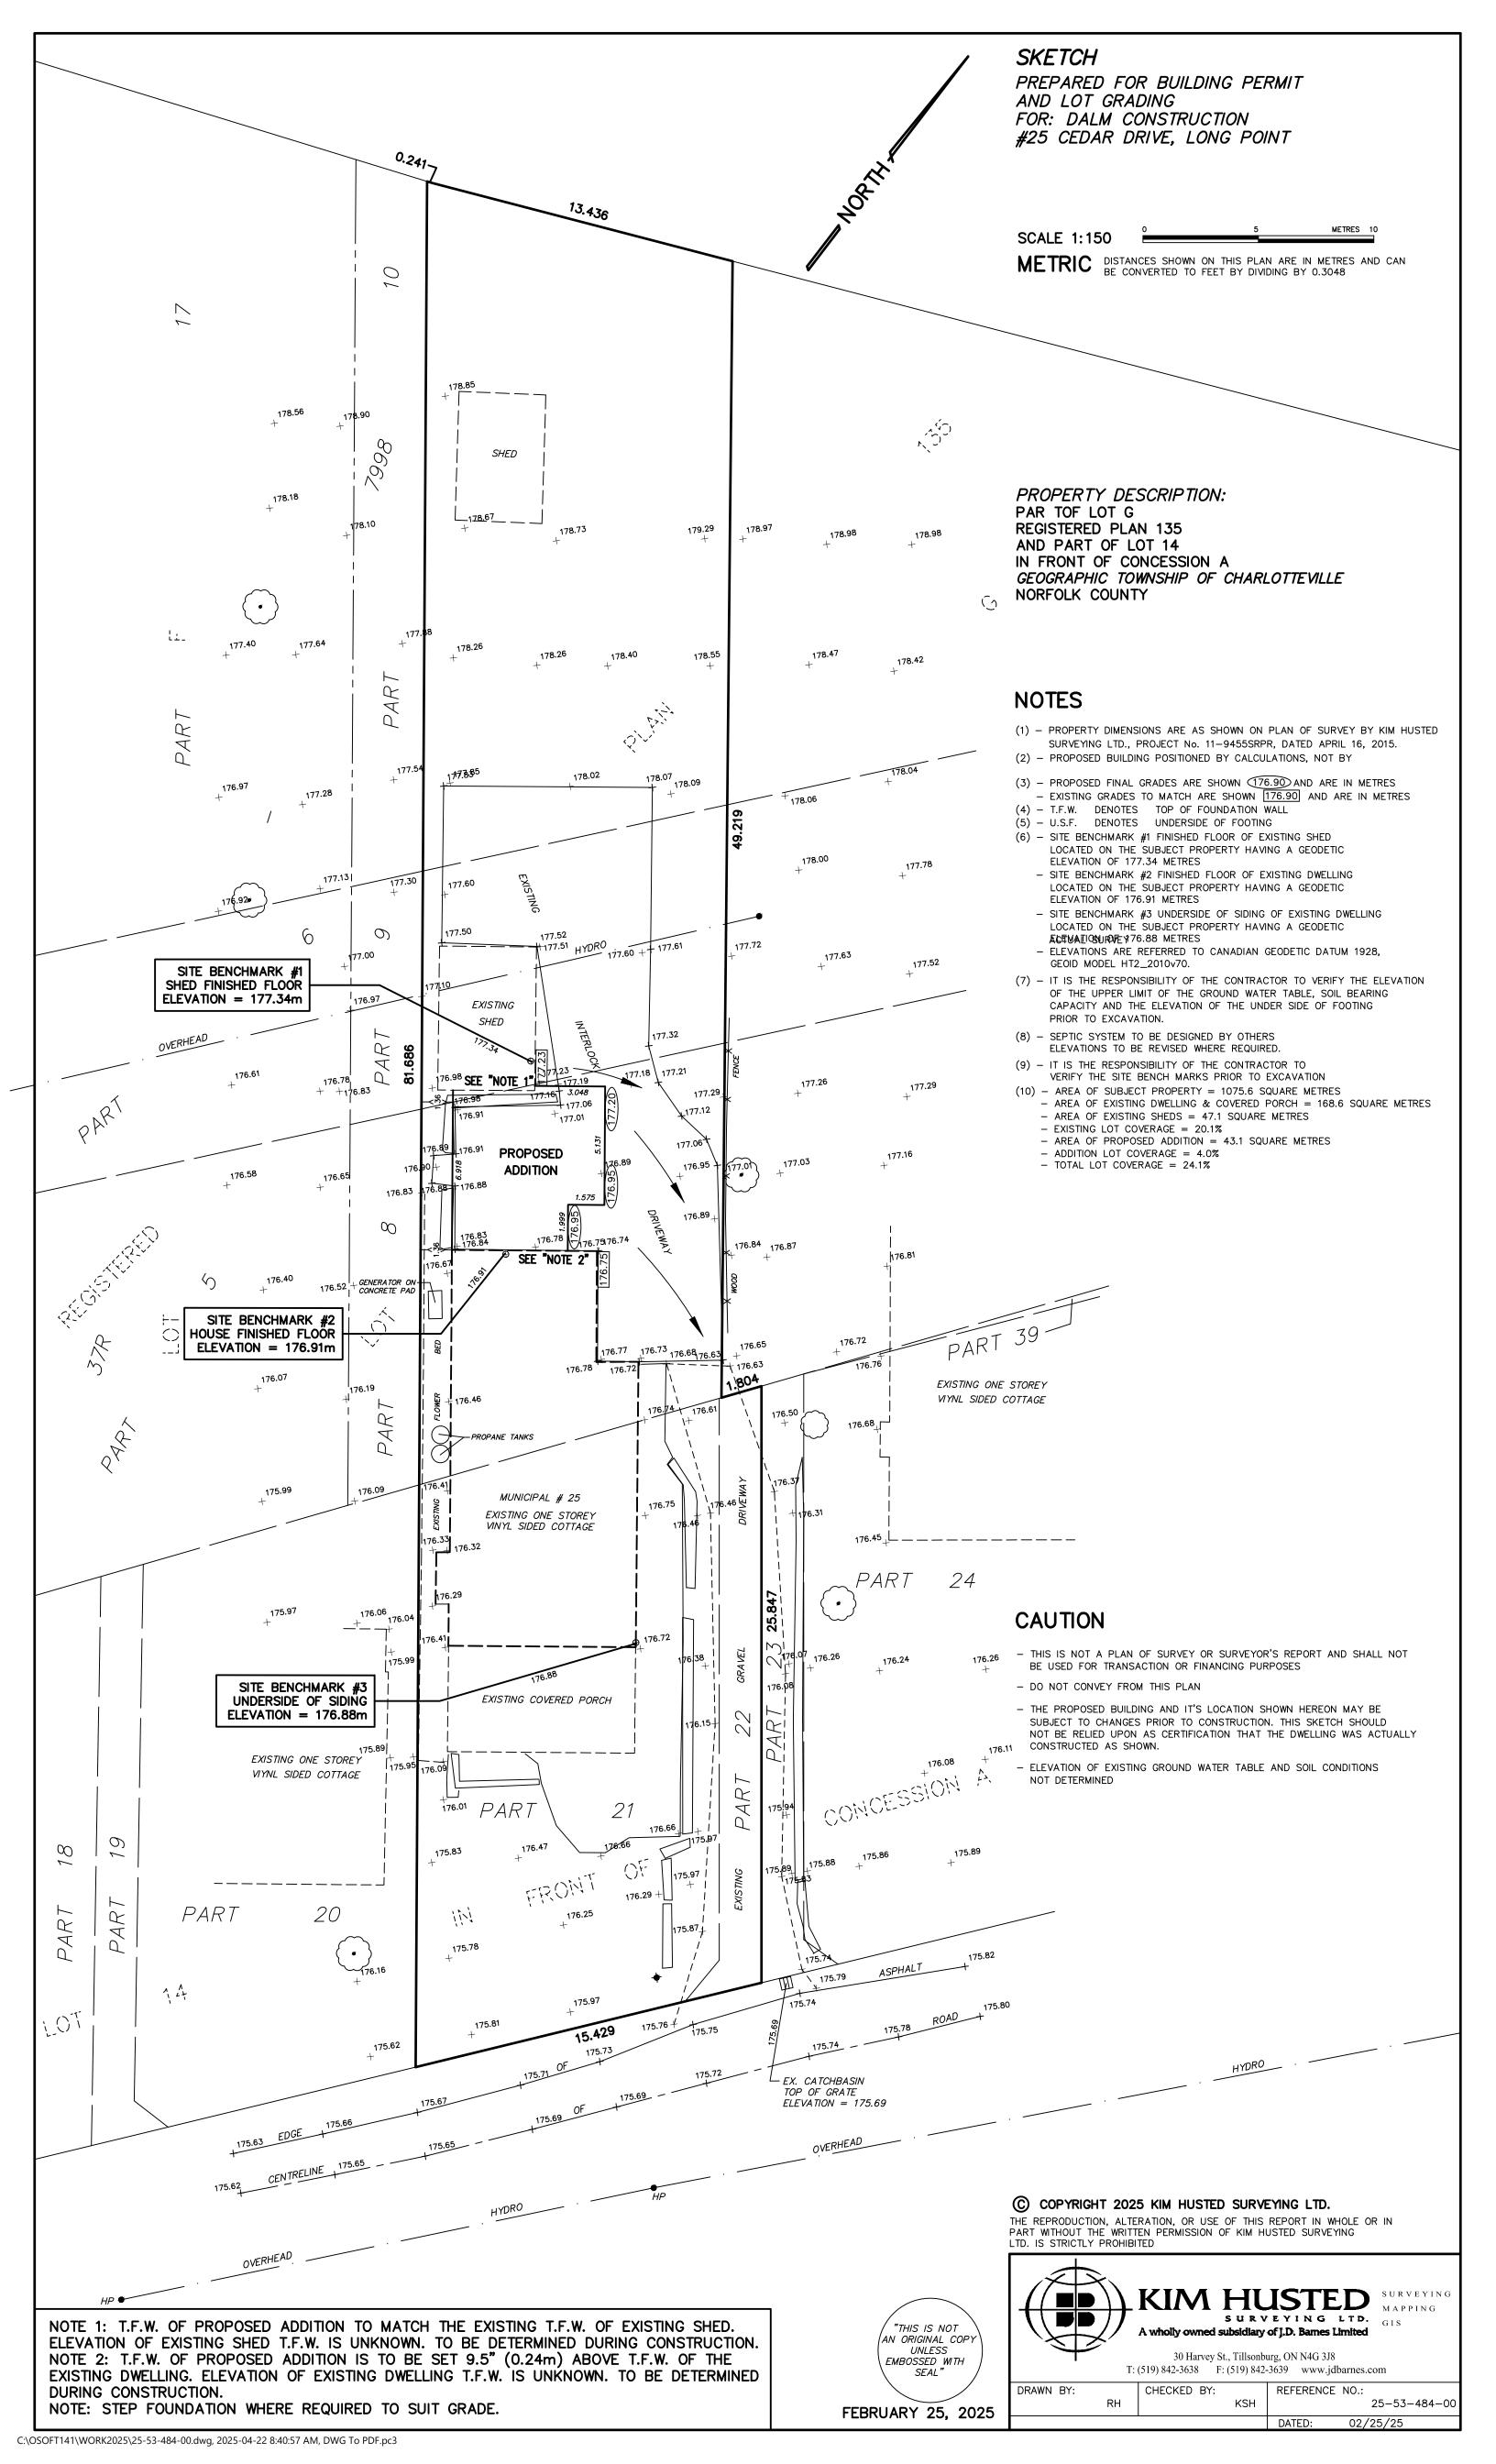

GENERAL NOTES:

- 1. The plans for this project have been reviewed by Dalm Construction Limited for uses only at the location noted on this page.
- 2. It is the responsibility of the owner and/or contractor to ensure that the provisions of the applicable zoning bylaw and all other applicable bylaws of the minicipality are being complied with as they relate to the proposed construction.
- 3. Contractor to check and verify all discrepancies before construction begins, verify all dimensions on site and ensure that all materials, details and methods of contruction meet or exceed the requirements of the latest edition of the Ontario Building code (OBC), Local Codes and Zoning Requirements.
- 4. All structural elements not obtainable through the OBC. Tables are to be sized, stamped and approved by a Registered Professional Engineer.
- 5. Drawings are not to be scaled.
- 6. Window and door sizes may not be exactly as shown. Contractor to verifu all dimensions prior to construction.
- 7. Dalm Construction Limited is not responsible for any misinrepresentations of these drawings and will not take any responsibility for any changes made to the drawings by the contractor, owner or others.

TECHNICAL NOTES:

- I. EXCAYATION
- 1. Actual soil bearing capacity to be determined at the site.
- 2. Excavation for the foundations to extend to undisturbed soil having a minimum allowable bearing pressure of 75 Pa (1510 psf)

2. BACKFILL

- 1. Backfill within 600mm (24 5/8") of the foundation shall be free of debris and boulder larger than 250mm (9 7/8") dia.
- 2. The foundation wall must be laterally supported before backfiling.

3, FOOTINGS AND FOUNDATIONS

- 1. Footings for walls, columns, etc. to extend below the frost line and bear on undistributed soil.
- 2. Concrete strength to be minimum 15 MPa (2,200 psi) except as
- 3. Provide 2 #4 steel reinforcing bars over entrances of sewers and utilities.
- 4. Exterior foundation walls to extend at least 150mm (5 7/8") above finished arade level.
- 5. Step footing vertical rise not to exceed 600mm (23 5/8") for firm soil and 400mm (15 3/4") for sand and gravel, horizontal run to be a minimum of 600mm (24 5/8").

4. FOUNDATION DRAINAGE

- 1. Drain tile to be on undisturbed or wall compacted soil and the top of the tile placed below the bottom of the floor slab.
- 2. Foundation drains shall drain to a sewer, drainage ditch, drywell, or a covered automatic sump pump draining into a positive outlet.
- 3. A drainage layer shall consist of:
- Minimum 19mm (3/4") mineral fibre insulation with a density of 3.6 lb/sa ft. or
- Minimum 100mm (4") of free drainage granular material or
- An approved system that provides equivalent performance.

5. SURFACE DRAINAGE

- 1. The building site is to be graded so that the water will not accumulate at or near the building and adversely affect
- 2. Window wells are to be drained to the footing level drainage tile or another suitable location.

6. CONCRETE FLOORS AND FLATWORK

- 1. Concrete strength for garage and carport floors and all exterior flatwork to be minimum 32 MPa (4.650 psi) and 5% to 8% air entrainment.
- 2. Other slabs to have min. concrete strength of 25 MPa (3,600 psi). 3. Concrete slabs to be minimum 75mm (3") thick on a minimum of 100mm (4") of coarse granular material.
- 4. All fill other than coarse clean material blaced beneath concrete slab shall be compacted to provide uniform support.

7, WOOD FRAME CONSTRUCTION

- 1. Holes or notching in roof, floor, wall or ceiling members to be resitricted to the sizes outlined in the OBC.
- 2. Roof trusses shall not be notched, drilled or weakened unless accumulated for in the design.
- 3. Exterior columns and posts are to be anchored.
- 4. Floor Joists to have minimum 38mm (1 1/2") length of end bearing.
- 5. Joists framed into the side of a wood beam, trimmer, header, etc. are to be supported on joist hangers.
- 6. Double joists under parallel non-load bearing partitions.
- 7. Provide 2"x2" cross bridging at maximum 6'-10" o.c. between

8. STAIRS TO CONFORM TO O.B.C. 9.8 (AMENDED JAN. 1, 2022)

1. Stairs to have uniform rise and run throughout,

Rise and run to confirm to the following:

Minimum Maximum 4 7/8" 7 7/8"

9. COLUMNS AND BEAMS

1. Minimum 89mm (3 1/2") end bearing for wood and steel beams, 2. Steel columns to have minimum ouside diameter of 13mm (2 1/8")

and a minimum wall thickness of 4.7mm (3/16)

10. ABOVE GRADE MASONRY

- 1. Veneer over wood frame walls to have not less than 25mm (1") air
- space behind the veneer. 2. Provide weep holes spaced not more than 800mm (2'-7") apart at the bottom of air spaces in masonry veneer walls.

 3. Masonry veneer shall be tied to wood framing members by
- corrosion resistant ties and screws or nails as per OBC.

II. FLOORING

Finished flooring in bathrooms and kitchens shall consist of resilient flooring, felted synthetic fibre floor covering, concrete, terrazzo, ceramic tile, mastic or other types of flooring providing similar degrees of water resistance.

12. WATERPROOF WALL FINISH

- 1. Waterproof finish is to be provided to a height of not less than: - 1800mm (5'-11") above the floor in a shower stall.
- 1.200mm (3'-11") above the rims of bathtubs with shower heads.
- 400mm (15 3/4") above the rim of bathtubs with no shower.

- 1. The owner and/or the contractor are responsible for the design layout and the installation of the plumbing system.
- 2. Where a private sewage system is required or utalized, the design, evaluation, construction or alteration of a new system as the case may be, shall be undertaken by a qualified person registered undertake such work.

14. HEATING AND AIR CONDITIONING

1. The owner and/or contractor are responsible for the design/layout and installation of the heting and air conditioning system.

15. NATURAL VENTILATION

- 1. Roof vents designed to prevent entry of rain, snow and insects.
- 2. Vents shall be distributed uniformly on opposite sides of the building with not less than 25% of the opening at either the top or bottom of the space.

16. MECHANICAL VENTILATION

1. The owner and/or contractor are responsible for the design/layout and installation of the mechanical ventilation sustem in compliance with the OBC.

1. Caulking shall be provided between masonry, siding or stucco and adjacent door and window frame or trim and anywhere else where it is required to prevent the entry of water into the structure.

18. DOORS AND WINDOWS

- Exterior doors and windows within 6'-7" from grade shall be constructed to resist forced entry. Doors shall be equipped with a dead bolt lock.
- 2. The principle entry door shall either a door viewer, transparent glazing or a sidelight.

19. GUARDS TO COMPLY WITH O.B.C. 9.8.8

- 1. Maximum opening in any guard must be able to prevent passage
- of a IOOmm (4") diameter spereical object.

 2. Guard attachment to comply with one of the methods details in SB-7 of the supplementary guidelines to the OBC.
- 3. A guard is to be provided at every location where there is a difference in elevation from floor, stairs or ramp to adjust surfaces or more than 600mm (5/8")

4. Minimum guard heights to be as follows:

- 800mm (2'-7") for stairs measured vertically above a line drawn 900mm (2'-11") for porches, decks, balconies and landings not - Modern (2-11) for policies, decre, button, through stair nosings.
 - more than 1,800mm (5-11") above adjacent ground
- 1,070mm (3'6") for porches, decks, balconies and landings more floor or other surface areas.
- than 1,800mm (5'-11") above adjacent ground floor
- or other surface areas.

20. ALARMS AND DETECTORS

- Interconnected Smoke and Carbon Monoxide Alarm required, complete with visual and audible signalling hardware, As per CAN/ULC 6531 & NEPA 72.
- 2. At least one interconnected smoke & carbon monoxide alarm shall be installed on or near the ceiling on each floor level and basement level 900mm (2'-11") or more above an adjacent level.
- 3. A interconnected smoke & carbon monoxide alarm shall be installed on or near the ceiling adjustment to every sleeping

21. GARAGE GASPROOFING

- 1. The walls and ceiling of an attached garage shall be constructed and sealed to provide an effective barrier to exhaust fumes.
- 2. Doors between the dwelling and attached garage shall be weatherstripped and have a self closer.

22. ELECTRICAL

- 1. An exterior light controlled by a wall switch is required at every entrance and in every kitchen, bedroom, living room, dining room utility room, vestibule, hallway, garage and car port. A switch recepticle may be provided instead of a light in bedroom and livina rooms.
- 2. Basements require a light for every 30 sq. m (323 sq. ft) conrolled by a switch at the head of the stairs.
- 3. Stairs shall be lighted and except where serving an unfinished basement shall be controlled by a 3-way switch at the head and and foot of the stairs,



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- CONTRACTOR TO VERIFY ALL DIMENSIONS

	DRAWING SCHEDULE		
PAGE *	PAGE NAME	REVISION DATE	
AO	NOTES & SCHEDULES	5/23/2025	
Δl	FRONT ELEVATION	5/23/2025	
Δ2	REAR ELEVATION	5/23/2025	
А3	RIGHT & LEFT ELEVATIONS	5/23/2025	
Δ4	FOUNDATION PLAN	5/23/2025	
A5	MAIN FLOOR PLAN	5/23/2025	
A6	LOFT FLOOR PLAN	5/23/2025	
DI	CROSS-SECTION A	5/23/2025	
D2	WALL SECTION	5/23/2025	
61	SPATIAL SEPARATION CALCULATIONS	5/23/2025	

PROPOSED ADDITION FOR:

KIM & KAREN COULTER 25 Cedar Drive Turkey Point, Ontario NOE IWO

THE UNDERSIGNED HAS REVIEWED AND TAKES RESPONSIBILITY FOR THIS DESIGN AND HAS THE QUALIFICATIONS AND MEETS THE REQUIREMENTS SET OUT IN THE ONTARIO BUILDING CODE TO DESIGN THE WORK SHOWN.

QUALIFICATION INFORMATION

REQUIRED UNLESS DESIGN IS EXEMPT UNDER 2.17.5.1 OF THE BUILDING CODE.

HENRY DALM

NOTES & SCHEDULES

SIGNATURE

DRAWN BY: Claudius Dalm SCALE: As Noted

DESIGN BY: Henry Dalm

CHECKED BY: Henry Dalm

DATE: 5/23/2025


PROJECT: Coulter



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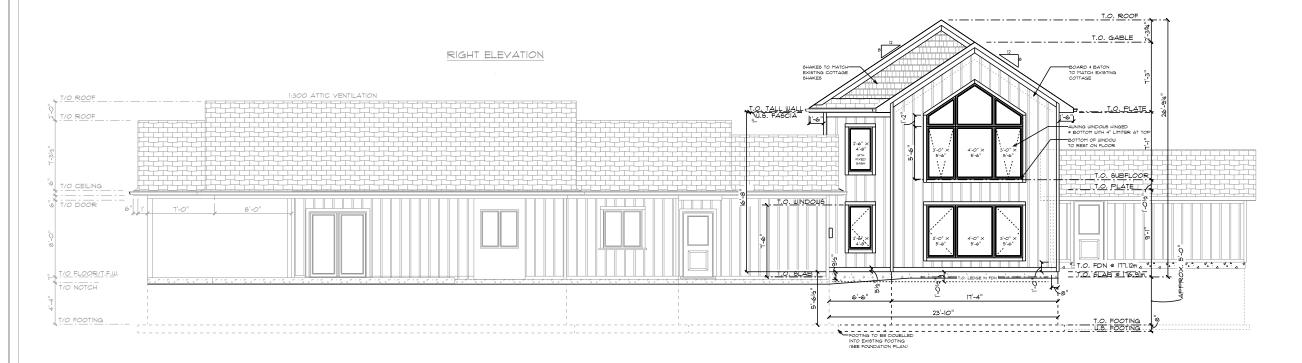
FRONT ELEVATION SCALE: 1/8" = 1'-0"



TOP OF FINISHED FLOOR (T.F.F.) OF ADDITION TO MATCH EXISTING T.F.F. @ 176.91m

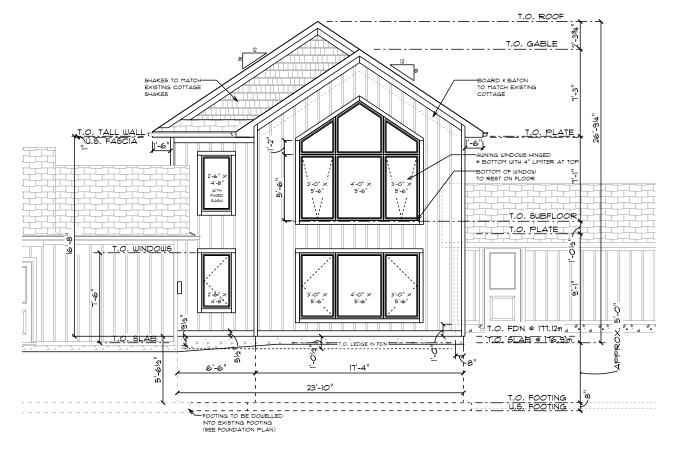TOP OF FOUNDATION OF ADDITION AT FRONT ELEVATION = 177,12m

FRONT ELEVATION





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FRONT ELEVATION


DRAWN BY: Claudius Dalm | SCALE: As Noted

DESIGN BY: Henry Dalm

CHECKED BY: Henry Dalm DATE: 5/23/2025




REAR ELEVATION SCALE: 1/8" = 1'-0"

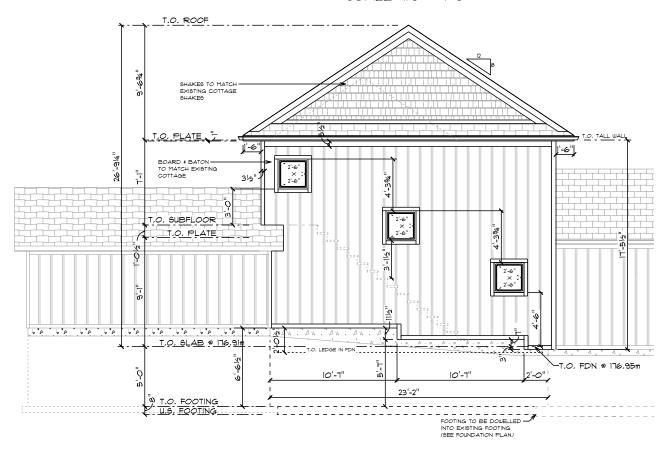

TOP OF FINISHED FLOOR (T.F.F.) OF ADDITION TO MATCH EXISTING T.F.F. @ 176.91m

TOP OF FOUNDATION OF ADDITION AT LOWEST POINT AT REAR ELEVATION = 176,95m

REAR ELEVATION

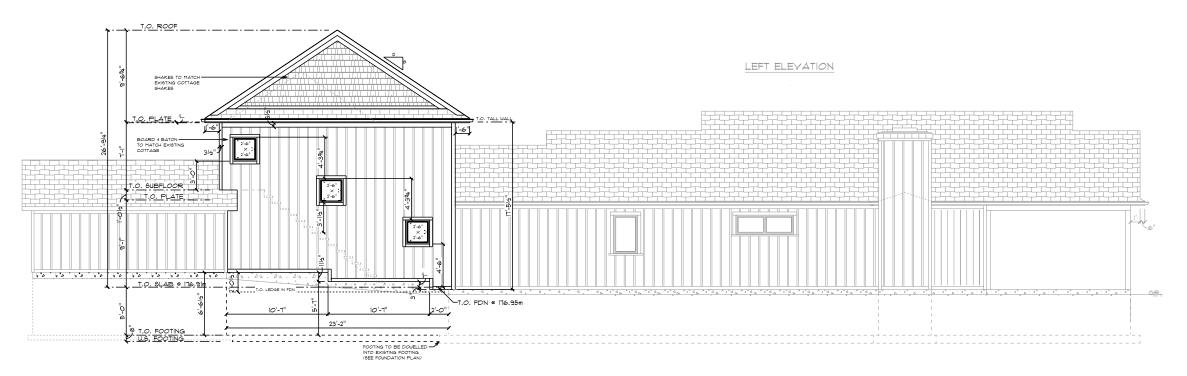



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REAR ELEVATION

DRAWN BY: Claudius Dalm | SCALE: As Noted


DESIGN BY: Henry Dalm

CHECKED BY: Henry Dalm

DATE: 5/23/2025


LEFT ELEVATION

SCALE: 1/8" = 1'-0"

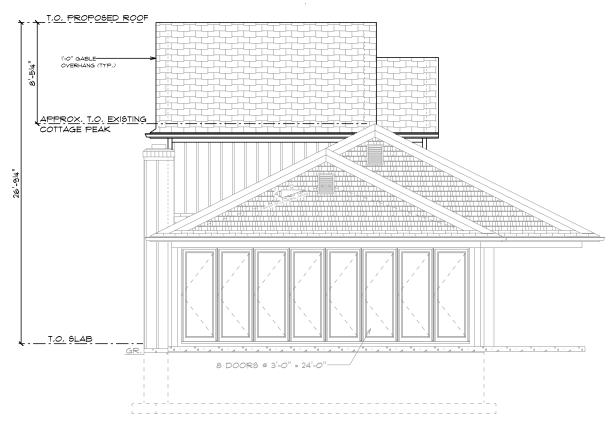

RIGHT ELEVATION

SCALE: 1/8" = 1'-0"

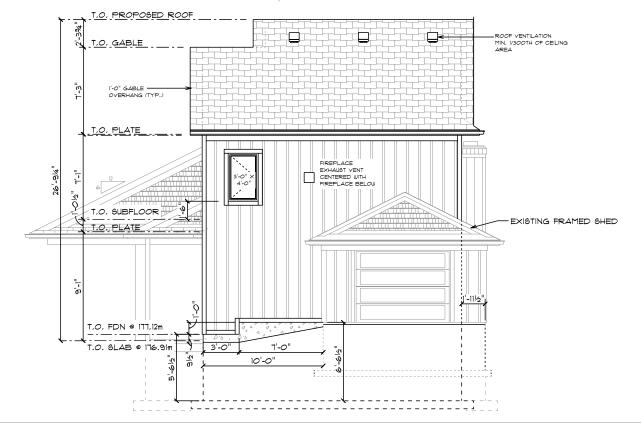



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KIM & KAREN COULTER 25 Cedar Drive Turkey Point, Ontario NOE IWO

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LEFT & RIGHT ELEVATIONS


DRAWN BY: Claudius Dalm | SCALE: 1/8" = 1'-0"

DESIGN BY: Henry Dalm

CHECKED BY: Henry Dalm
DATE: 5/23/2025

PROJECT: Coulter

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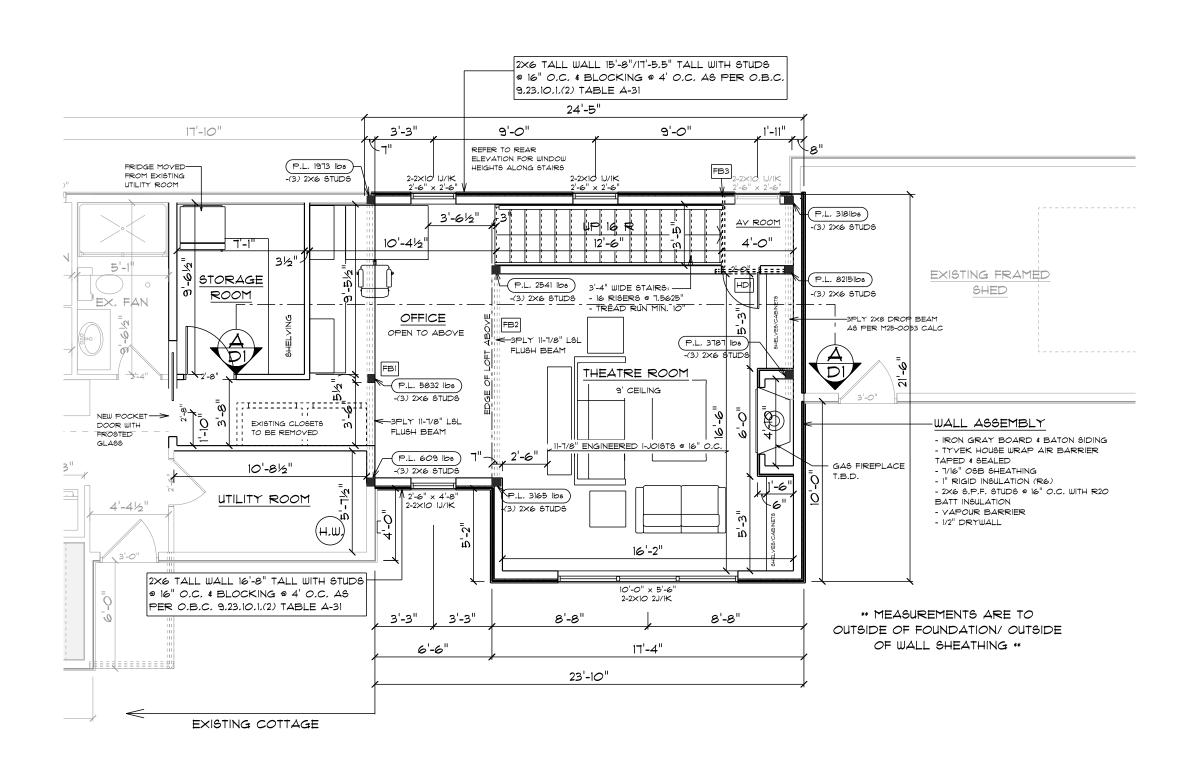
FOUNDATION PLAN

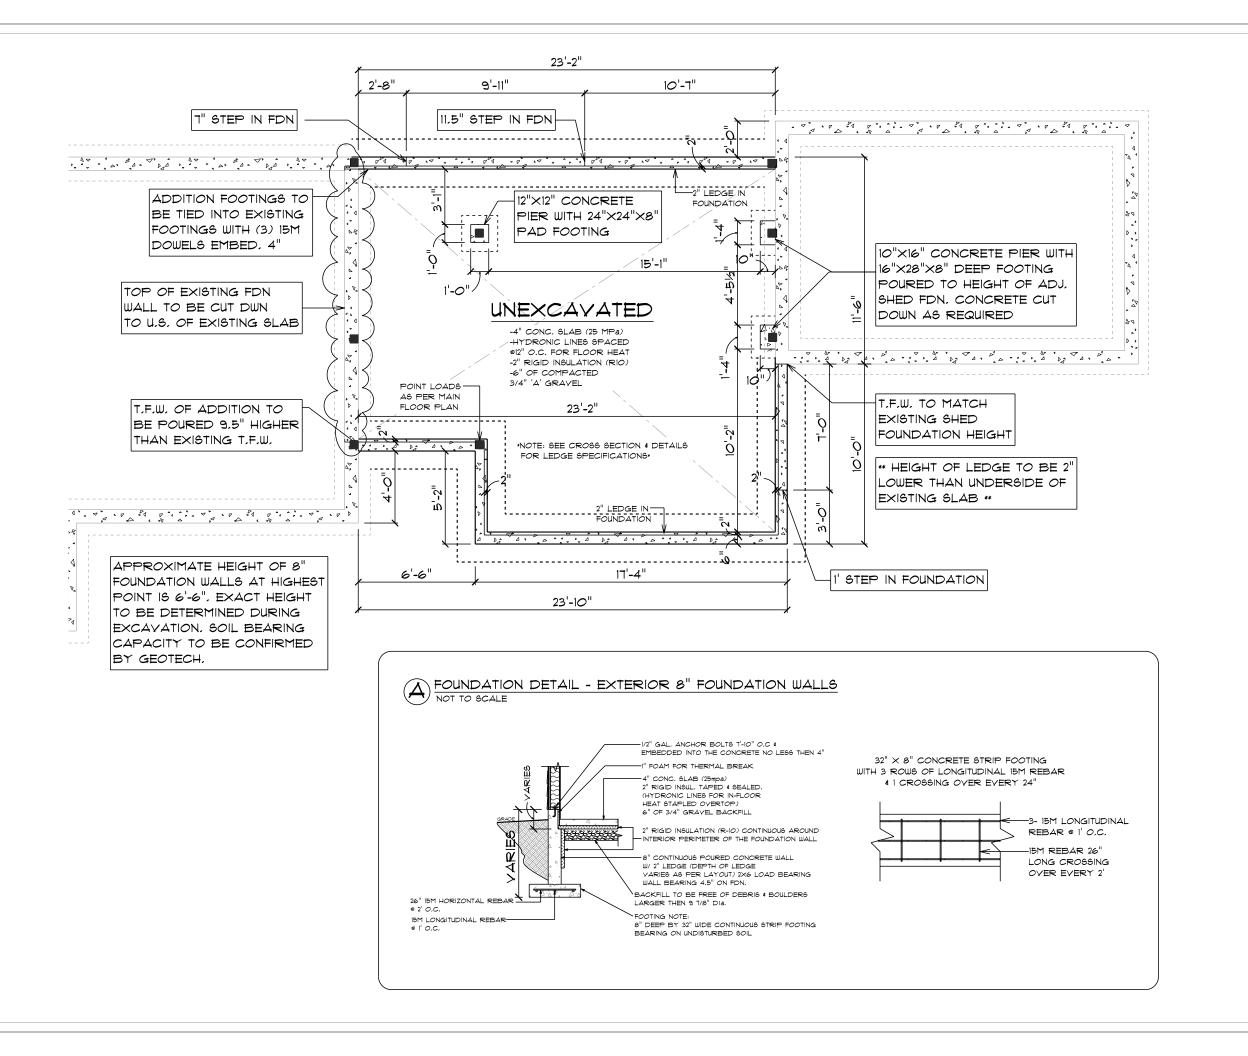DRAWN BY: Claudius Dalm SCALE: As Noted

DESIGN BY: Henry Dalm

CHECKED BY: Henry Dalm

DATE: 5/23/2025 PROJECT: Coulter



REFER TO FLOOR SYSTEM LAYOUT & MEMBER CALCULATIONS FOR FB1-FB3, HD1, & M25-0053 FOR NAILING PATTERNS & BEARING REQUIREMENTS



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TOTAL NEW SQUARE FOOTAGE= 488 ft^2 (DIMENSIONS TAKEN FROM OUTSIDE OF SHEATHING)

TOTAL AREA INCLUDING ADDITION & ALTERATIONS= 645.7 ft^2

PROPOSED ADDITION FOR:

KIM & KAREN COULTER 25 Cedar Drive Turkey Point, Ontario NOE IWO

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MAIN FLOOR PLAN


DRAWN BY: Claudius Dalm | SCALE: 3/16" = 1'-0"

DESIGN BY: Henry Dalm

CHECKED BY: Henry Dalm

DATE: 5/23/2025



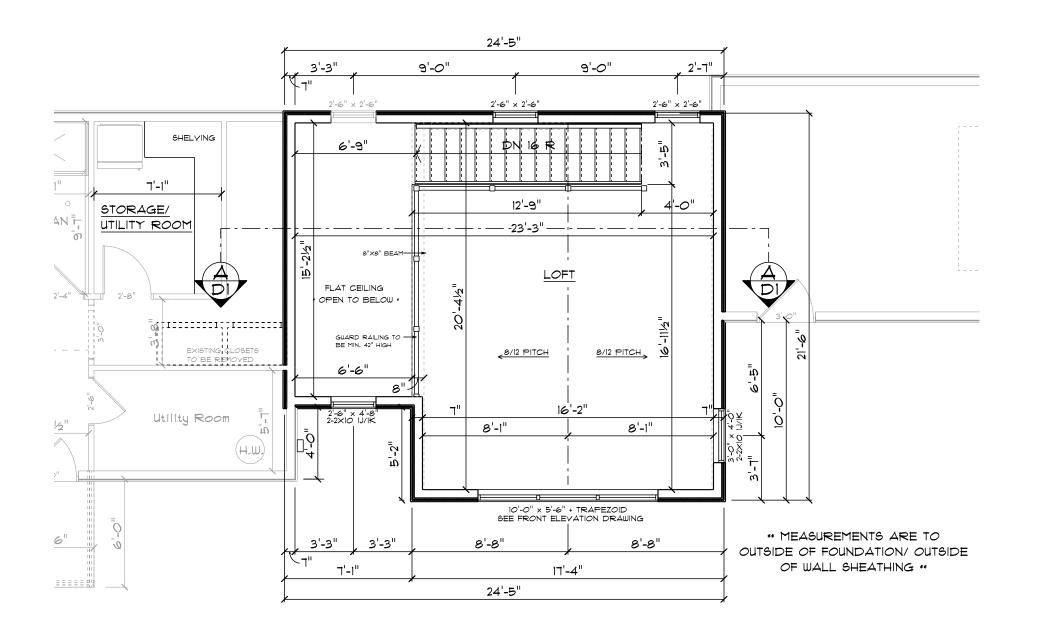

REFER TO TRUSS LAYOUT & DRAWINGS FOR DETAILS ON TRUSS INSTALLATION BRACING, & BEARING REQUIREMENTS



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TOTAL SQUARE FOOTAGE OF LOFT = 322.4 ft^2 (DIMENSIONS TAKEN FROM OUTSIDE WALL SHEATHING)

PROPOSED ADDITION FOR:

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LOFT FLOOR PLAN

DRAWN BY: Claudius Dalm | SCALE: 3/16" = 1'-0"


DESIGN BY: Henry Dalm CHECKED BY: Henry Dalm

DATE: 5/23/2025

PROJECT: Coulter

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<u>CROSS-SECTION A</u> SCALE: 3/16" = 1'-0"



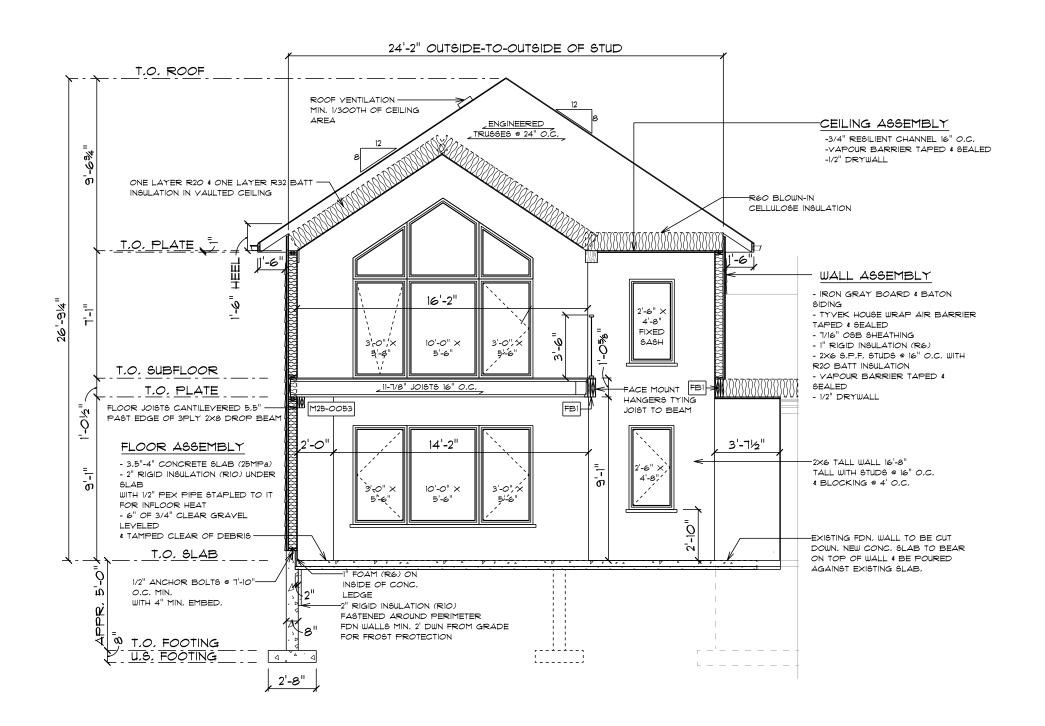

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CROSS-SECTION A

DRAWN BY: Claudius Dalm | SCALE: 3/16" = 1'-0"


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EXTERIOR WALL CROSS-SECTION - SIDING





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WALL SECTION


DRAWN BY: Claudius Dalm | SCALE: 0.4531" = 1'-0"

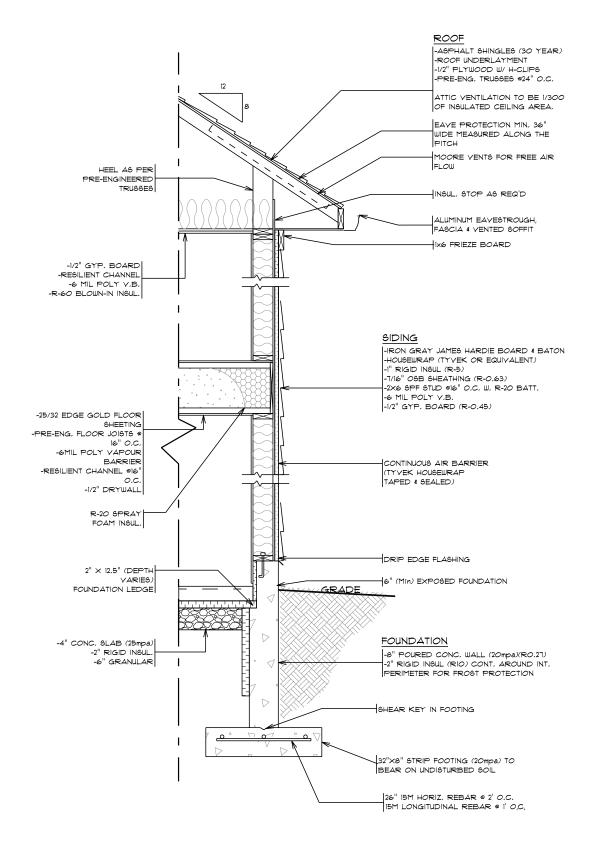DESIGN BY: Henry Dalm

CHECKED BY: Henry Dalm

DATE: 5/23/2025



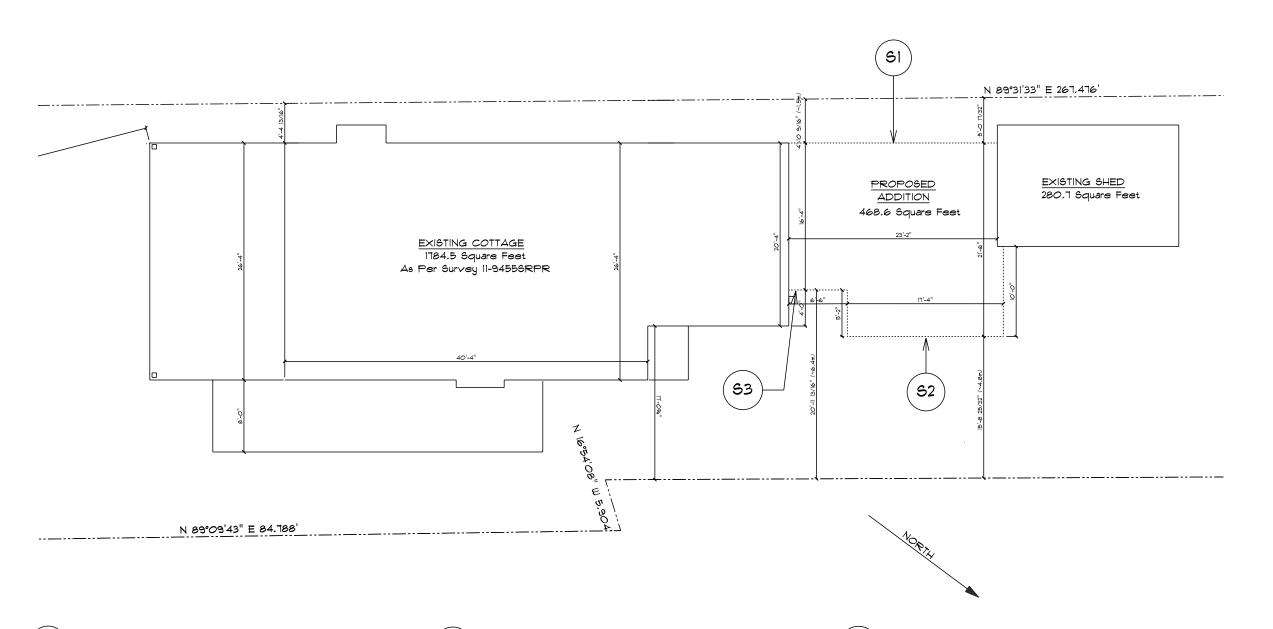

REAR WALL

GROSS EXPOSED WALL AREA = 414.5 Sq. Ft. (38.5 sq.m.)GLAZING OPENINGS AREA = 18.75 Sq. Ft. (1.74 % GLAZED OPENINGS = 4.5% MAX. ALLOW, AREA OF GLAZED OPENINGS @ L.D. 1.5m

IS 8% AS PER OBC TABLE 9.10.15.4.

FRONT WALL (THEATRE RM & LOFT)

GROSS EXPOSED WALL AREA = 322.6 Sq. Ft. (30 sq.m.)GLAZING OPENINGS AREA = 115.8 Sq. Ft. (10.76 sq.m.) % GLAZED OPENINGS = 35.9% MAX, ALLOW, AREA OF GLAZED OPENINGS @ L.D. 4m 16 39% AS PER OBC TABLE 9,10,15,4,

FRONT WALL (OFFICE) 53

GROSS EXPOSED WALL AREA = 113.1 Sq. Ft. (10.5 sq.m.)GLAZING OPENINGS AREA = 23.3 Sq. Ft. (2.2 % GLAZED OPENINGS = 20.9% MAX, ALLOWABLE AREA OF GLAZED OPENINGS @ L.D. 6m IS 100% AS PER OBC TABLE 9.10.15.4.



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SIGNATURE

SPATIAL SEPARATION CALCULATIONS

DRAWN BY: Claudius Dalm | SCALE: 0.0938" = 1'-0"

DESIGN BY: Henry Dalm

DATE: 5/23/2025

PROJECT: Coulter


CHECKED BY: Henry Dalm

K. Declaration
1, Clarde Dahn of Ingersall, ON
solemnly declare that:
all of the above statements and the statements contained in all of the exhibits transmitted herewith are true and I make this solemn declaration conscientiously believing it to be true and knowing that it is of the same force and effect as if made under oath and by virtue of <i>The Canada Evidence Act</i> .
Declared before me at:
SIMCOE ONT CHARLES
Owner/Applicant/Agent Signature
This 18th day of 100 20035
A.D., 20 Sherry Ann Mott, a Commissioner etc. Desire
Commissioner, etc., Province of Ontario. for the Corporation of Norfolk County. Expires March 16, 2028. A Commissioner, etc.



CONTEXT MAP

Geographic Township of CHARLOTTEVILLE

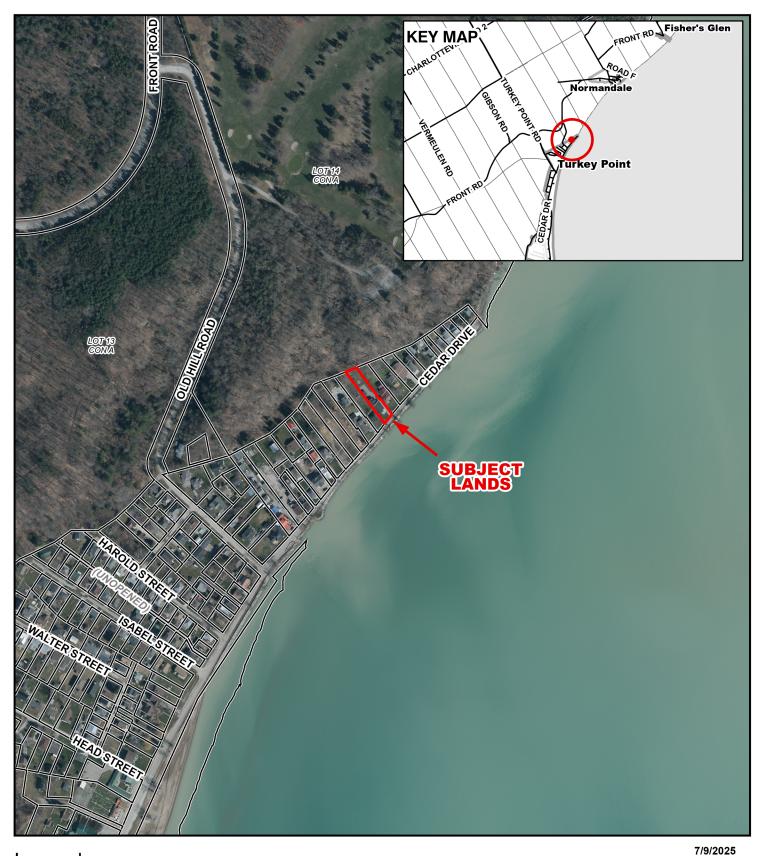


Legend



30 15 0 30 60 90 120 Meters

MAP B ZONING BY-LAW MAP Geographic Township of CHARLOTTEVILLE

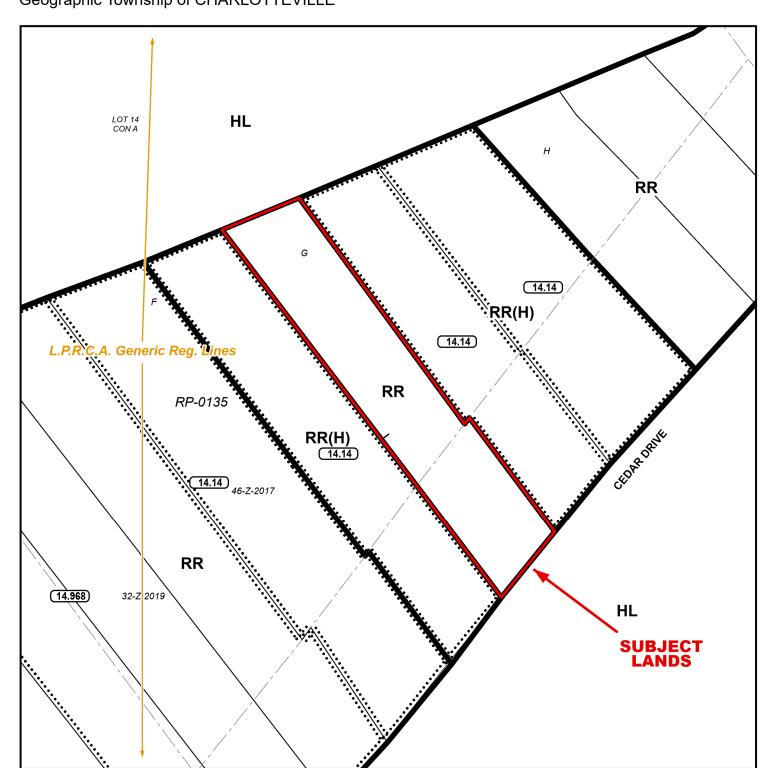



ZONING BY-LAW 1-Z-2014

(H) - Holding

HL - Hazard Land Zone

RR - Resort Residential Zone



7/9/2025



MAP C ANPL2025206

CONCEPTUAL PLAN

Geographic Township of CHARLOTTEVILLE

