For Office Use Only: File Number Related File Number Pre-consultation Meeting Application Submitted Complete Application	Application Fee  Conservation Authority Fee  Well & Septic Info Provided  Planner  Public Notice Sign
Check the type of plan	nning application(s) you are submitting.
	/Boundary Adjustment
	ing Severance and Zoning By-law Amendment
<ul><li>✓ Minor Variance</li><li>☐ Easement/Right-of-\(^1\)</li></ul>	Way
1 <del>22</del>	40015510100
Property Assessment	Roll Number: 175100 1 700
A. Applicant Informati	on .i .i .i .i
Name of Owner	Marleen & Arjan Kremers
It is the responsibility of ownership within 30 day	the owner or applicant to notify the planner of any changes in s of such a change.
Address	121 ordnance Avenue
Town and Postal Code	Turkey Point
Phone Number	1-519-688-8899
Cell Number	Some as about
Email	marleen a agrichoice.ca
Name of Applicant	Claude Dalm
Address	41 King Street
Town and Postal Code	Tillsonburg NYG 3EC
Phone Number	519-688-0228
Cell Number	519-550-1307
Email	design a dalmica



Name of Agent	_ (lande	Dalm	
Address	41 King	Street	
Town and Postal Code	Tillso. burg	N49 3E	ζ
Phone Number	514-688-00	278	
Cell Number	519-550-13	OF	
Email	designoda	in ca	
	II communications should botices in respect of this appoone.		
☐ Owner	☐ Agent	Applicant	
-			
. Legal Description (incl Block Number and Urb	Messes ve A	Concession Number,	50 <b>4</b> 00 500.00
. Legal Description (incl Block Number and Urb	ude Geographic Township, pan Area or Hamlet): 	Concession Number,	(ances s
. Legal Description (incl Block Number and Urb	ude Geographic Township, oan Area or Hamlet): L PLAN 133 1 RP3+R154.	Concession Number, PT LOT 55 L PART 31	(ances s
. Legal Description (incl Block Number and Urk Turkey Par Pt. Lot 1 Municipal Civic Addres	ude Geographic Township, oan Area or Hamlet): L PLAN 133 1 RP3+R154.	Concession Number, PT LOTSS L PART 31 JANUE AL	CONCESS: AND 3Z ENUE
. Legal Description (incl Block Number and Urb Turkey Par Production Lot 1 Municipal Civic Address Present Official Plan D	ude Geographic Township, pan Area or Hamlet):  1. PLAN 133 1. RP3+R154 s:	PT LOTSS L PART 31 LANCE AL	CONCESS: AND 3Z ENUE
. Legal Description (incl Block Number and Urb Turkey Par Proceed Lot 1 Municipal Civic Address Present Official Plan D Present Zoning:	ude Geographic Township, pan Area or Hamlet):  1. PLAN 133 1. RP3+R154 s: 171 ORDA esignation(s): Rescue	Concession Number,  PT LOTSS  L PART 31  JANKE AL  Resident:	CONCESS AND 32 ENUE



4.	Please describe all existing buildings or structures on the subject lands and whether they are to be retained, demolished or removed. If retaining the buildings or structures, please describe the type of buildings or structures, and illustrate the setback, in metric units, from front, rear and side lot lines, ground floor area, gross
	floor area, lot coverage, number of storeys, width, length, and height on your
	attached sketch which must be included with your application:
	Brick sun room at back of property to be retained.  Vinyl Sided shed to be demolished. See attacked.  Surveyor's real property report.
5.	If an addition to an existing building is being proposed, please explain what it will be
	used for (for example a bedroom, kitchen, or bathroom). If new fixtures are
	proposed, please describe.
	Min
6.	Please describe all proposed buildings or structures/additions on the subject lands.  Describe the type of buildings or structures/additions, and illustrate the setback, in metric units, from front, rear and side lot lines, ground floor area, gross floor area, lot
	coverage, number of storeys, width, length, and height on your attached sketch
	which must be included with your application:
	groupe Refer to proposed site plan for setbacks
	Is lot werage.
7.	Are any existing buildings on the subject lands designated under the Ontario
	Heritage Act as being architecturally and/or historically significant? Yes   No
	If yes, identify and provide details of the building:
ρ	If known the length of time the existing uses have continued on the cubic of land.
0.	If known, the length of time the existing uses have continued on the subject lands:
9.	Existing use of abutting properties:
	Resort Residential - Seasonal Cottages
10.	Are there any easements or restrictive covenants affecting the subject lands?
	▼Yes □ No If yes, describe the easement or restrictive covenant and its effect:
	Hydro Easement at back of property to allow
	for Work on hydro lines. Grand franced in gravel laneway for access to back of Ect Revised April 2023  Committee of Adjustment Development Application
N.I	(1) laneway for access to back of Got Revised April 2023
N	Committee of Adjustment Development Application Page 3 of 13

#### C. Purpose of Development Application

Note: Please complete all that apply. Failure to complete this section will result in an incomplete application.

1. Site Information (Please refer to Zoning By-law to confirm permitted dimensions)

	Existing	Permitted	Provision	Proposed	Deficiency
Lot frontage	10.668m				
Lot depth	70.1m				
Lot width	10.668m				
Lot area	744.2m^2				
Lot coverage	17.3%+(5.9%)	15%+(10%)	5.8.2 h)	28%+(2%)	13%
Front yard	3.7m	6m	5.8.2 c)	4.75m	1.25m
Rear yard	~33.7m	9m	5.8.2 f)	18.8m	
Height	N/A	9.1m	5.8.2 g)	8m	
Left Interior side yard	2.72m	1.2m	5.8.2 e)	1.2m	
Right Interior side yard	1.15m @ Closest Point	1.2m	5.8.2 e)	1.2m	
Exterior side yard (corner lot)					
Parking Spaces (number)					
Aisle width					
Stall size					
Loading Spaces					
Other					



2	. Please explain why it is not possible to comply with the provision(s) of the Zoning
	Size of lot doesn't allow for necessary
	Size of lot doesn't allow for necessary amenities with lot coverage only out 015% Setback from property like is too tight at 6, to allow for adequate covered from at front.
1// 3	. Consent/Severance/Boundary Adjustment: Description of land intended to be
<b>5/</b> M	severed in metric units:  Frontage:
	Depth:
	Width:
	Lot Area:
	Present Use:
	Proposed Use:
	Proposed final lot size (if boundary adjustment):
	If a boundary adjustment, identify the assessment roll number and property owner of
	the lands to which the parcel will be added:
	The factor of the part of the
	Description of land intended to be retained in metric units:  Frontage:
	Depth:
	Width:
	Lot Area:
	Present Use:
	Proposed Use:
	Buildings on retained land:
V/A4.	Easement/Right-of-Way: Description of proposed right-of-way/easement in metric units:  Frontage:
	Depth:



	Width:
	Area:
	Proposed Use:
NIA	<ol> <li>Surplus Farm Dwelling Severances Only: List all properties in Norfolk County, which are owned and farmed by the applicant and involved in the farm operation</li> </ol>
	Owners Name:
	Roll Number:
	Total Acreage:
	Workable Acreage:
	Existing Farm Type: (for example: corn, orchard, livestock)
	Dwelling Present?: ☐ Yes ☐ No If yes, year dwelling built
	Date of Land Purchase:
	Owners Name:
	Roll Number:
	Total Acreage:
	Workable Acreage:
	Existing Farm Type: (for example: corn, orchard, livestock)
	Dwelling Present?: ☐ Yes ☐ No If yes, year dwelling built
	Date of Land Purchase:
	Owners Name:
	Roll Number:
	Total Acreage:
	Workable Acreage:
	Existing Farm Type: (for example: corn, orchard, livestock)
	Dwelling Present?: ☐ Yes ☐ No If yes, year dwelling built
	Date of Land Purchase:



Owners Name:
Roll Number:
Total Acreage:
Workable Acreage:
Existing Farm Type: (for example: corn, orchard, livestock)
Dwelling Present?: ☐ Yes ☐ No If yes, year dwelling built
Date of Land Purchase:
Owners Name:
Roll Number:
Total Acreage:
Workable Acreage:
Existing Farm Type: (for example: corn, orchard, livestock)
Dwelling Present?: ☐ Yes ☐ No If yes, year dwelling built
Date of Land Purchase:
Note: If additional space is needed please attach a separate sheet.
D. All Applications: Previous Use of the Property
<ol> <li>Has there been an industrial or commercial use on the subject lands or adjacent lands? ☐ Yes INO IN Unknown</li> </ol>
If yes, specify the uses (for example: gas station, or petroleum storage):
2. Is there reason to believe the subject lands may have been contaminated by former uses on the site or adjacent sites?□ Yes No □ Unknown
3. Provide the information you used to determine the answers to the above questions:  - Existing cottage has been there unchanged - Since possession of property was taken



W/A	If you answered yes to any of the above questions in Section D, a previous use inventory showing all known former uses of the subject lands, or if appropriate, the adjacent lands, is needed. Is the previous use inventory attached?   Yes  No			
E.	All Applications: Provincial Policy			
1.	Is the requested amendment consistent with the provincial policy statements issued under subsection 3(1) of the <i>Planning Act, R.S.O. 1990, c. P. 13</i> ? ★ Yes □ No			
	If no, please explain:			
2.	It is owner's responsibility to be aware of and comply with all relevant federal or provincial legislation, municipal by-laws or other agency approvals, including the Endangered Species Act, 2007. Have the subject lands been screened to ensure that development or site alteration will not have any impact on the habitat for endangered or threatened species further to the provincial policy statement subsection 2.1.7?   Yes No			
	If no, please explain:  No endangered or threatened Species  present on property since possession of  property was taken.  Have the subject lands been screened to ensure that development or site alteration  will not have any impact on source water protection? Yes XNo  If no, please explain: will be  Structures built within Sme general area  as existing coltage and vinyle Sted is located  Note: If in an area of source water Wellhead Protection Area (WHPA) A, B or C  please attach relevant information and approved mitigation measures from the Risk  Manager Official.			



4.	All Applications: Are any of the following uses or features on the subject lands or within 500 metres of the subject lands, unless otherwise specified? Please check boxes, if applicable.
	Livestock facility or stockyard (submit MDS Calculation with application)
	☐ On the subject lands or ☐ within 500 meters – distance
	Wooded area  ☐ On the subject lands or ☐ within 500 meters – distance
	Municipal Landfill  ☐ On the subject lands or ☐ within 500 meters – distance
	Sewage treatment plant or waste stabilization plant  ☐ On the subject lands or ☐ within 500 meters – distance
	Provincially significant wetland (class 1, 2 or 3) or other environmental feature  On the subject lands or within 500 meters – distance ( at Back
	Floodplain  On the subject lands or within 500 meters - distance  Rehabilitated mine site  The property &  of property &  of property &  the road.
	Rehabilitated mine site  On the subject lands or within 500 meters – distance
	Non-operating mine site within one kilometre  ☐ On the subject lands or ☐ within 500 meters – distance
	Active mine site within one kilometre  ☐ On the subject lands or ☐ within 500 meters – distance
	Industrial or commercial use (specify the use(s))  ☐ On the subject lands or ☐ within 500 meters – distance
	Active railway line □ On the subject lands or □ within 500 meters – distance
	Seasonal wetness of lands  ☐ On the subject lands or ☐ within 500 meters – distance
	Erosion □ On the subject lands or □ within 500 meters – distance
	Abandoned gas wells  ☐ On the subject lands or ☐ within 500 meters – distance



F.	All Applications: Servicing and Access			
1.	Indicate what services are available or proposed:			
	Water Supply			
	Municipal piped water	☐ Communal wells		
	☐ Individual wells	☐ Other (describe below)		
	Sewage Treatment	7		
	☐ Municipal sewers	☐ Communal system		
	☐ Septic tank and tile bed in good working order	Other (describe below)		
	Molding tank at back Storm Drainage	e of property		
	☐ Storm sewers	☐ Open ditches		
	☐ Other (describe below)	0 0 1 1		
	Property is graded and	I sloped from front to back of property.		
2.	Existing or proposed access to subject lands:	or property.		
	Municipal road	☐ Provincial highway		
	☐ Unopened road	Other (describe below)		
2	Name of road/street:	0 5 15		
4	ccessable by Ordnance A	venue & Grandfathered		
G. 1.	Name of road/street:  CLESSABLE BY Ordnance A  All Applications: Other Information  Does the application involve a local business?	back of property.		
	If yes, how many people are employed on the subj	ject lands?		
2.	Is there any other information that you think may be	e useful in the review of this		
	application? If so, explain below or attach on a sep			
	The survey of existing			
	Cottage as 3.7m. whi	ch is closer to		
	Front property line than	n what we are proper		
	at 4.75 m.	1 Trans		



#### H. Supporting Material to be submitted by Applicant

In order for your application to be considered complete, folded hard copies (number of paper copies as directed by the planner) and an **electronic version (PDF) of the site plan drawings, additional plans, studies and reports** will be required, including but not limited to the following details:

- 1. Concept/Layout Plan
- 2. All measurements in metric
- 3. Existing and proposed easements and right of ways
- 4. Parking space totals required and proposed
- All dimensions of the subject lands
- 6. Dimensions and setbacks of all buildings and structures
- Location and setbacks of septic system and well from all existing and proposed lot lines, and all existing and proposed structures
- Names of adjacent streets
- Natural features, watercourses and trees

In addition, the following additional plans, studies and reports, including but not limited to, may also be required as part of the complete application submission:

On-Site Sewage Disposal System Evaluation Form (to verify location and condition)

Environmental Impact Study

Geotechnical Study / Hydrogeological Review

Minimum Distance Separation Schedule

Record of Site Condition

Your development approval might also be dependent on Ministry of Environment Conservation and Parks, Ministry of Transportation or other relevant federal or

All final plans must include the <u>owner's signature</u> as well as the <u>engineer's</u> signature and seal.

provincial legislation, municipal by-laws or other agency approvals.



#### I. Transfers, Easements and Postponement of Interest

The owner acknowledges and agrees that if required it is their solicitor's responsibility on behalf of the owner for the registration of all transfer(s) of land to the County, and/or transfer(s) of easement in favour of the County and/or utilities. Also, the owner further acknowledges and agrees that it is their solicitor's responsibility on behalf of the owner for the registration of postponements of any charges in favour of the County.

#### Permission to Enter Subject Lands

Permission is hereby granted to Norfolk County officers, employees or agents, to enter the premises subject to this application for the purposes of making inspections associated with this application, during normal and reasonable working hours.

Freedom of Information	
For the purposes of the Municipal Freedom of authorize and consent to the use by or the dinformation that is collected under the authority of the purposes of processing this application.	lisclosure to any person or public body any ty of the <i>Planning Act, R.S.O. 1990, c. P.</i>
Owner/Applicant/Agent Signature	Date
J. Owner's Authorization	
If the applicant/agent is not the registered own application, the owner must complete the auth	107
I/We	_am/are the registered owner(s) of the
lands that is the subject of this application.	
I/We authorize	rsonal information necessary for the
Owner 6 1	Date

\*Note: If property is owned by an Ontario Ltd. Corporation, Articles of Incorporation are required to be attached to the application.

Owner



Date

K. Declaration	
1. Clarde Dala of	Ingersall, ON
solemnly declare that:	S
all of the above statements and the statements of transmitted herewith are true and I make this sole believing it to be true and knowing that it is of the under oath and by virtue of <i>The Canada Evidence</i>	emn declaration conscientiously same force and effect as if made
Declared before me at:	Q 1
Simcos ONT	- (1) (to
In_ NORFALK COUNTY	Owner/Applicant/Agent Signature
This 18th day of Tuwe 2025	
A.D., 20 <u>35</u>	
Sherry Ann Mott, a Commissioner, etc., Province for the Corporation of Norf Expires March 18, 2026.  A Commissioner, etc.	e of Ontario. olk County.



53 LOT PART 26 PART 25 39.624 (P1+P2 & M) LOT 53> (700) -<N 79° 44′ 21″ W (M) (N 79° 40′ 42″ W P1 & P2) LOT 54> 33.528 (P1 & M) CI PART 28 39.624 (M) W (M) (N 79° 40' 42" W P2)  $\stackrel{(M)}{\mathbb{P}_2}$ 50267 1 STOREY VINYL SIDED COTTAGE 0340 SHED P.I.N. 50267 WOOD DECK HYDRO POLE ON LINE 33.528 (P1 & M) —< N 79° 44′ 06" W (S) (N 79° 40′ 42" W P2)</p> 36.576 (P2 & S) TREE 0.44 SOUTH P.I.N. 50267 - 0339 SUN ROOM STOREY VINYL SIDED COTTAGE DOCK WOOD 0339 50267 P.I.N. N 79° 40′ 42″ W 33.528 (D1 & M) 3.048 (D1, D3 & S)-(WOOD DECK / N 79° 40' 42" W (S SEA WALL 0.08 SOUTH TREE 0.22 NORTH 0.50 NORTH DRIVEWAY LOT 55 ROOF OVERHANG CONCRETE LOT 56 > 33.528 (P1 & M) 39.624 (P1+P2 & M) (39.666 BAR TO BAR) N 79° 40' 42" W 50267 0338 P.I.N. DYE. 50267 VINYL SIDED BOAT HOUSE 1 STOREY VINYL SIDED COTTAGE 59.652 (P3 & M) 30" (W P3) N 79° 40' 42" W (P1, P2 & M) (N 79° 36' 33.528 (P1 & M) (33.556 P3) IB (1582) 26.096 (P3 & M) IB (1582) 0.09 SOUTH (700)0.04 WEST LOT PART 38 33.528 (P1, P4 & M) (33.556 P3) (P2, P3 & M)>++< ──N 79° 36′ 30″ W (P3 & M) (N 79° 40′ 42″ W P1, P2 & P4) 39.624 (P1+P2 & M) (39.652 P3) (1582)PART Ш PART 37R -- 2590 PART 1, STREET BRISTOL (CLOSED BY B-LAW 655-83 REGISTERED AS INSTRUMENT NR419268)

SURVEYOR'S REAL PROPERTY REPORT

(PART 1) PLAN OF

PART OF LOT 55 REGISTERED PLAN 133 (TURKEY POINT) PART OF LOT 11 TURKEY POINT MARSH IN FRONT OF CONCESSION A GEOGRAPHIC TOWNSHIP OF CHARLOTTEVILLE NORFOLK COUNTY

KIM HUSTED SURVEYING LTD.

(PART 2)

REPORT SUMMARY (TO BE READ IN CONJUNCTION WITH PLAN OF SURVEY) REGISTERED EASEMENTS AND/OR RIGHTS-OF-WAY: SUBJECT TO RIGHT-OF-WAY AND SUBJECT TO EASEMENT AS SET OUT IN NR579006, TOGETHER WITH A RIGHT-OF-WAY AS SET OUT IN NR579006.

COMPLIANCE WITH MUNICIPAL OFFICIAL PLANS AND ZONING BY-LAWS: NOT CERTIFIED BY THIS REPORT

ADDITIONAL REMARKS: PROPERTY DESCRIPTION: PART OF LOT 55, REGISTERED PLAN 133 TURKEY POINT, AND PART OF LOT 11, TURKEY POINT MARSH IN FRONT OF CONCESSION A (PARTS 31 & 32, 37R-1541), GEOGRAPHIC TOWNSHIP OF CHARLOTTEVILLE, NORFOLK COUNTY ALL OF P.I.N. 50267-0339

SUBJECT PROPERTY AREA = 744.20 SQUARE METRES

AREA OF SUBJECT PROPERTY COVERED BY COTTAGE, DECKS AND PATIO = 128.72 SQUARE METRES

COVERAGE = 17.3 %

FOR USE BY OTHERS

VENUE

AREA OF SUBJECT PROPERTY COVERED BY SHED, SUN ROOM AND PATIO = 44.18 SQUARE METRES COVERAGE = 5.9 %

THIS SURVEYOR'S REAL PROPERTY REPORT HAS BEEN PREPARED FOR HENRY DALM CONSTRUCTION AND THE UNDERSIGNED ACCEPTS NO RESPONSIBILITY

THIS REPORT CAN BE UPDATED BY KIM HUSTED SURVEYING LTD. HOWEVER NO ADDITIONAL PRINTS OF THIS ORIGINAL REPORT WILL BE ISSUED SUBSEQUENT TO THE DATE OF CERTIFICATION

### SURVEYOR'S CERTIFICATE

I CERTIFY THAT

(1) - THIS SURVEY AND PLAN ARE CORRECT AND IN ACCORDANCE WITH THE SURVEYS ACT, THE SURVEYORS ACT AND THE REGULATIONS

(2) - THIS SURVEY WAS COMPLETED ON THE 5th DAY

JULY 19, 2022 DATE

DENOTES

ONTARIO LAND SURVEYOR

### NOTES

(1) - BEARINGS ARE ASTRONOMIC AND ARE REFERRED TO THE WESTERLY LIMIT OF ORDNANCE AVENUE AS SHOWN ON REGISTERED PLAN 133 HAVING A BEARING OF N 10° 19' 18" E

SURVEY MONUMENT FOUND

### LEGEND

SURVEY MONUMENT SET DENOTES STANDARD IRON BAR DENOTES DENOTES ROUND IRON BAR DENOTES DENOTES IRON PIPE DENOTES WITNESS G.B. MacAULAY, O.L.S. DENOTES JEWITT & DIXON LTD. DENOTES (700)KIM HUSTED SURVEYING LTD. DENOTES DENOTES SOURCE UNKNOWN REGISTERED PLAN 133 DENOTES DENOTES DEPOSITED PLAN 37R-1541 (P2) (P3) SURVEYOR'S REAL PROPERTY REPORT BY KIM HUSTED SURVEYING LTD., PROJECT: 19-15098, DATED: SEPTEMBER 13, 2019 (P4) DENOTES DEPOSITED PLAN 37R-2590 DENOTES INSTRUMENT NR579006, P.I.N. 50267-0339 (D1) DENOTES INSTRUMENT NR606052, P.I.N. 50267-0340 DENOTES INSTRUMENT NR315124, P.I.N. 50267-0338 DENOTES MEASURED DENOTES SET DENOTES SET BY PROPORTIONING (S/P) DENOTES PROPERTY IDENTIFIER NUMBER P.I.N. DENOTES SUBJECT TO

ASSOCIATION OF ONTARIO LAND SURVEYORS PLAN SUBMISSION FORM V - 25281

THIS PLAN IS NOT VALID UNLESS IT IS AN EMBOSSED ORIGINAL COPY ISSUED BY THE SURVEYOR accordance with Regulation 1026, Section 29(3)

DENOTES RIGHT-OF-WAY ROW © COPYRIGHT 2022 KIM HUSTED SURVEYING LTD. THE REPRODUCTION, ALTERATION, OR USE OF THIS REPORT IN WHOLE OR IN PART WITHOUT THE WRITTEN PERMISSION OF KIM HUSTED SURVEYING

DENOTES EASEMENT

LTD. IS STRICTLY PROHIBITED KIM HUSTED SURVEYING LTD. ONTARIO LAND SURVEYOR 30 HARVEY STREET, TILLSONBURG, ONTARIO, N4G 3J8

PHONE: 519-842-3638 FAX: 519-842-3639

PROJECT: 22-17865

REFERENCE: FF8

DWG. WLP

CKD. KSH

SCALE 1:200

DISTANCES SHOWN ON THIS PLAN ARE IN METRES AND CAN BE CONVERTED TO FEET BY DIVIDING BY 0.3048

10 METRES

154

다 지 지

CHANNEL


# SITE PLAN: 121 ORDNANCE AVENUE, TURKEY POINT

TOTAL LOT AREA = 744,2 SQUARE METERS

PROPOSED COTTAGE (INCLUDING COVERED PORCHES & ATTACHED GARAGE) = 2204 FT^2 OR 204.8 SQUARE METERS

EXISTING BRICK SUN ROOM = 15.3 SQUARE METERS 15.3/744.2 \* 100 = 2%

LOT COVERAGE = (204.8 + 15.3)/744.2 \* 100 = 29.5%

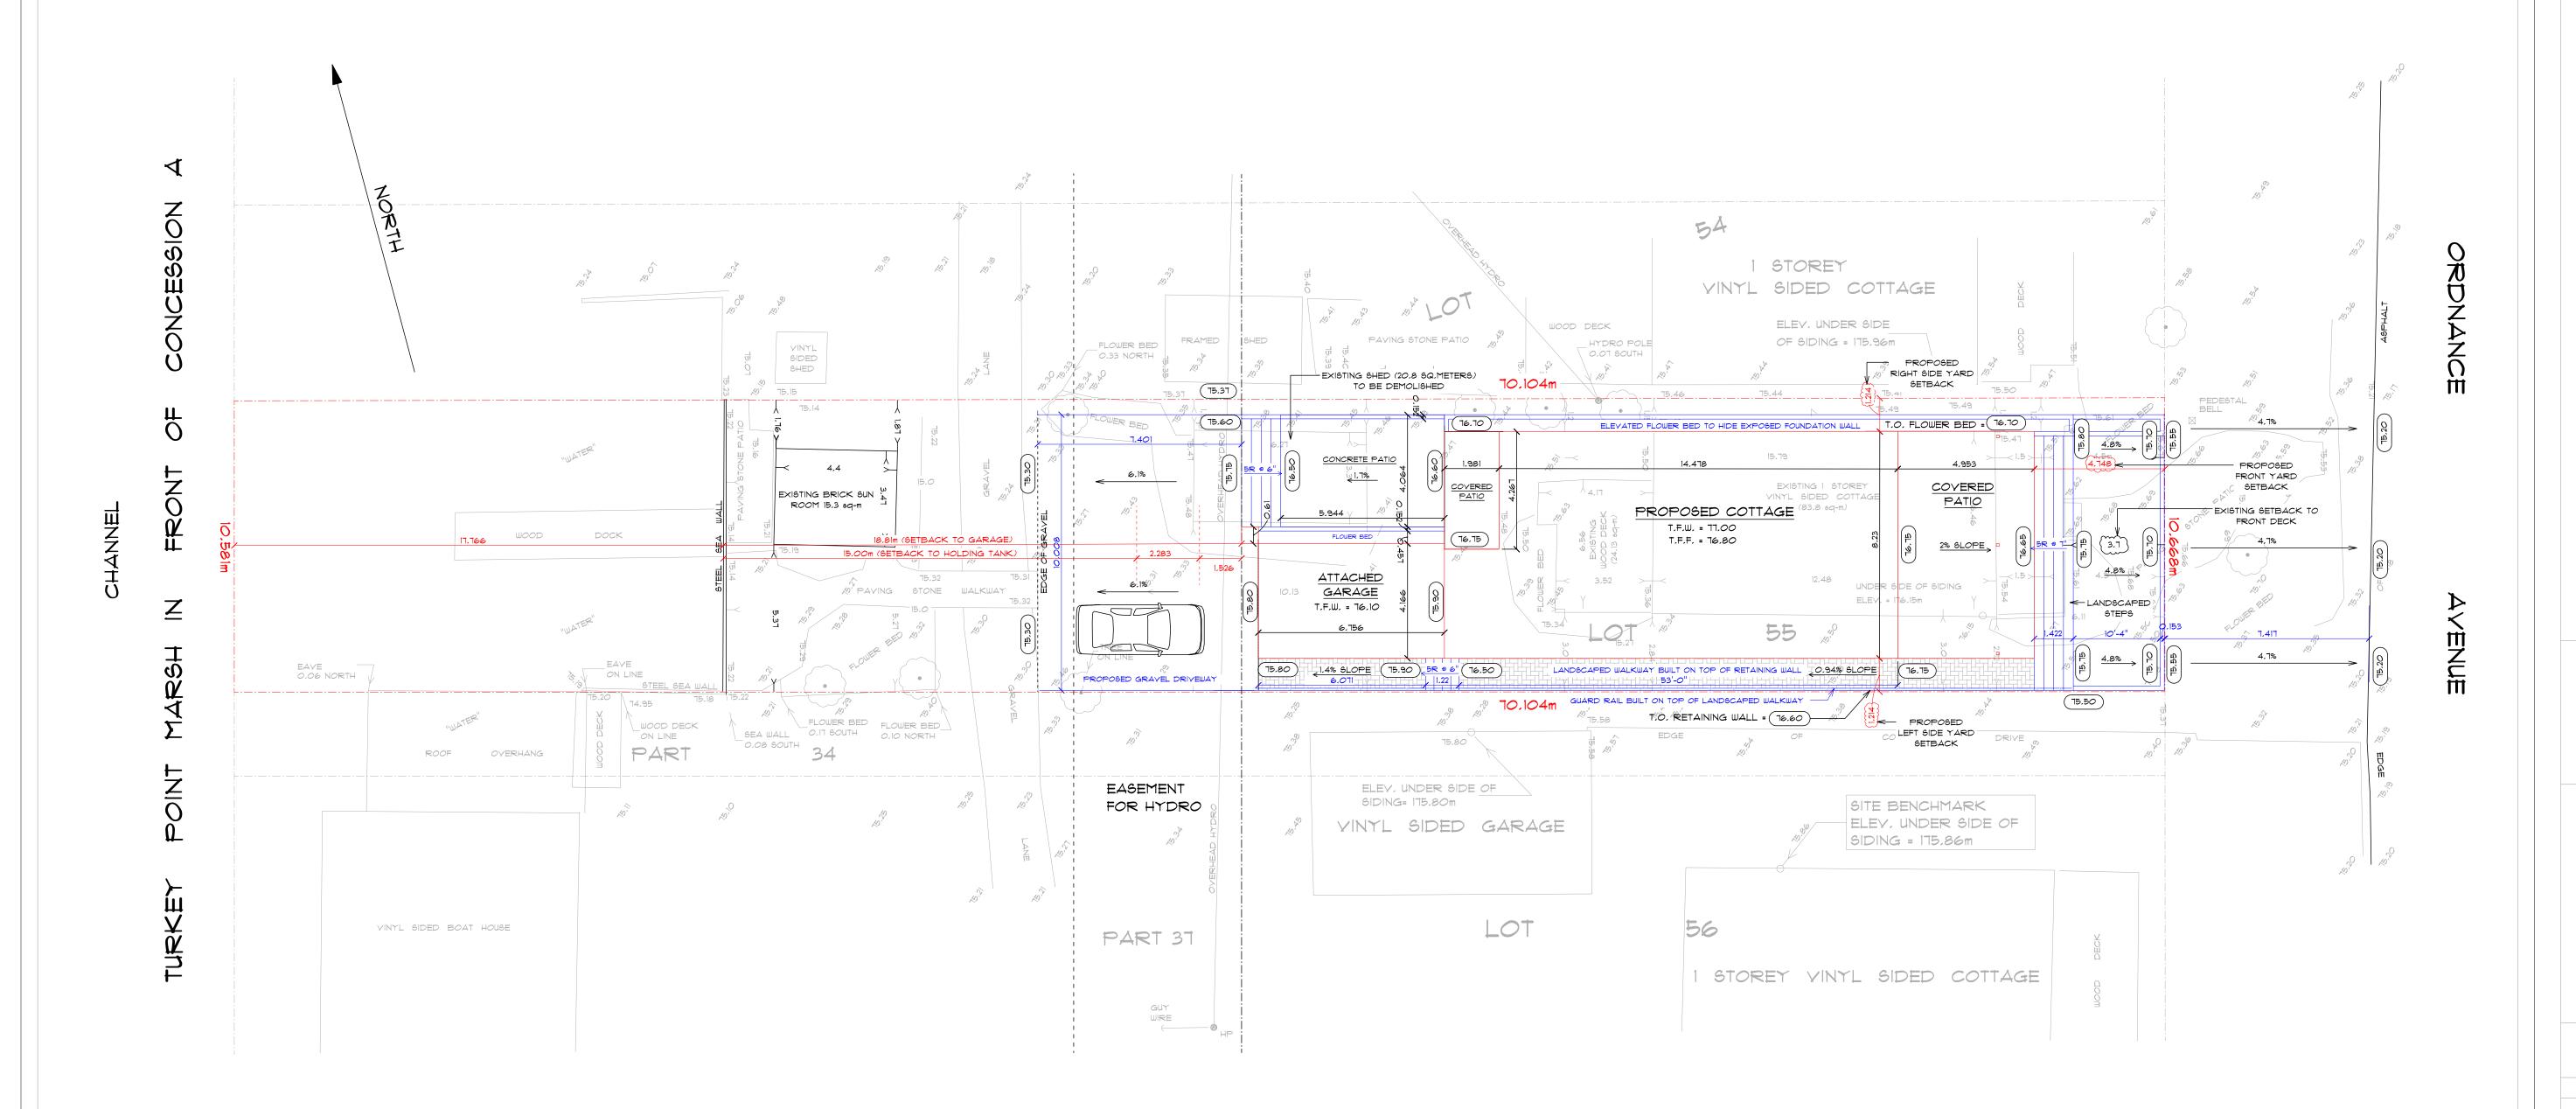



PHONE: (519) 688-0228 EMAIL: DESIGN@DALM.CA WWW.DALM.CA

THE PROPERTY OF DALM CONSTRUCTION LIMITED, NO REPRODUCTIONS ARE TO BE MADE WITHOUT WRITTEN PERMISSION.

- CONTRACTOR TO YERIFY ALL DIMENSIONS.

PROPOSED COTTAGE FOR:

Arjan & Marlene Kremers 121 Ordnance Avenue Turkey Point, NOE 1WO

THE UNDERSIGNED HAS REVIEWED AND TAKES RESPONSIBILITY FOR THIS DESIGN AND HAS THE QUALIFICATIONS AND MEETS THE REQUIREMENTS SET OUT IN THE ONTARIO BUILDING CODE TO DESIGN THE WORK SHOWN.

QUALIFICATION INFORMATION

REQUIRED UNLESS DESIGN IS EXEMPT UNDER 2.17.5.1 OF THE BUILDING CODE.

HENRY DALM NAME

39111 BCIN

SIGNATURE

SITE PLAN

DRAWN BY: Claudius Dalm | SCALE: 1:120

DESIGN BY: Henry/Claudius CHECKED BY: Henry Dalm

DATE: 7/1/2025

PROJECT: Kremers

#### GENERAL NOTES:

- 1. The plans for this project have been reviewed by Dalm Construction Limited for uses only at the location noted on this page.
- 2. It is the responsibility of the owner and/or contractor to ensure that the provisions of the applicable zoning bylaw and all other applicable bylaws of the minicipality are being complied with as they relate to the proposed construction.
- 3. Contractor to check and verify all discrepancies before construction begins, verify all dimensions on site and ensure that all materials, details and methods of contruction meet or exceed the requirements of the latest edition of the Ontario Building code (OBC), Local Codes and Zoning Requirements.
- 4. All structural elements not obtainable through the OBC. Tables are to be sized, stamped and approved by a Registered Professional Engineer.
- 5. Drawings are not to be scaled.
- 6. Window and door sizes may not be exactly as shown. Contractor to verify all dimensions prior to construction.
- 7. Dalm Construction Limited is not responsible for any misinrepresentations of these drawings and will not take any responsibility for any changes made to the drawings by the contractor, owner or others.

#### TECHNICAL NOTES:

- 1, EXCAYATION
- 1. Actual soil bearing capacity to be determined at the site.
- 2. Excavation for the foundations to extend to undisturbed soil having a minimum allowable bearing pressure of 75 Pa (1510 psf)

#### 2. BACKFILL

- 1. Backfill within 600mm (24 5/8") of the foundation shall be free of debris and boulder larger than 250mm (9 7/8") dia.
- 2. The foundation wall must be laterally supported before backfiling.

#### 3. FOOTINGS AND FOUNDATIONS

- 1. Footings for walls, columns, etc. to extend below the frost line and bear on undistributed soil.
- 2. Concrete strength to be minimum 15 MPa (2,200 psi) except as
- 3. Provide 2 #4 steel reinforcing bars over entrances of sewers and utilities
- 4. Exterior foundation walls to extend at least 150mm (5 7/8") above finished grade level.
- 5. Step footing vertical rise not to exceed 600mm (23 5/8") for firm soil and 400mm (15 3/4") for sand and gravel, horizontal run to be a minimum of 600mm (24 5/8").

#### 4. FOUNDATION DRAINAGE

- 1. Drain tile to be on undisturbed or wall compacted soil and the top of the tile placed below the bottom of the floor slab.
- 2. Foundation drains shall drain to a sewer, drainage ditch, drywell, or a covered automatic sump pump draining into a positive outlet.
- 3. A drainage layer shall consist of:
- Minimum 19mm (3/4") mineral fibre insulation with a density of 3.6 lb/sq ft. or
- Minimum 100mm (4") of free drainage granular material or
- An approved system that provides equivalent performance.

#### 5, SURFACE DRAINAGE

- 1. The building site is to be graded so that the water will not accumulate at or near the building and adversely affect adjacent properities.
- 2. Window wells are to be drained to the footing level drainage tile or another suitable location.

#### 6. CONCRETE FLOORS AND FLATWORK

- 1. Concrete strength for garage and carport floors and all exterior flatwork to be minimum 32 MPa (4.650 psi) and 5% to 8% air
- 2. Other slabs to have min. concrete strength of 25 MPa (3,600 psi).
- 3. Concrete slabs to be minimum 75mm (3") thick on a minimum of 100mm (4") of coarse granular material.
- 4. All fill other than coarse clean material placed beneath concrete slab shall be compacted to provide uniform support.

#### 7, WOOD FRAME CONSTRUCTION

- 1. Holes or notching in roof, floor, wall or ceiling members to be resitricted to the sizes outlined in the OBC.
- 2. Roof trusses shall not be notched, drilled or weakened unless accumulated for in the design.
- 3. Exterior columns and posts are to be anchored.
- 4. Floor Joists to have minimum 38mm (1 1/2") length of end bearing.
- 5. Joists framed into the side of a wood beam, trimmer, header,
- etc. are to be supported on joist hangers. 6. Double joists under parallel non-load bearing partitions.
- 7. Provide 2"x2" cross bridging at maximum 6'-10" o.c. between supports.

### 8. STAIRS TO CONFORM TO O.B.C. 9.8.8

1. Stairs to have uniform rise and run throughout. Rise and run to confirm to the following: Minimum Maximum

9, COLUMNS AND BEAMS

- . Minimum 89mm (3 1/2") end bearing for wood and steel beams.
- 2. Steel columns to have minimum ouside diameter of 73mm (2 7/8") and a minimum wall thickness of 4.7mm (3/16)

#### 10, ABOYE GRADE MASONRY

- 1. Veneer over wood frame walls to have not less than 25mm (1") air
- space behind the veneer. 2. Provide weep holes spaced not more than 800mm (2'-7") apart at
- the bottom of air spaces in masonry veneer walls. 3. Masonry veneer shall be tied to wood framing members by corrosion resistant ties and screws or nails as per OBC.

#### 11, FLOORING

1. Finished flooring in bathrooms and kitchens shall consist of resilient flooring, felted synthetic fibre floor covering, concrete, terrazzo, ceramic tile, mastic or other types of flooring providing similar degrees of water resistance.

#### 12. WATERPROOF WALL FINISH

- 1. Waterproof finish is to be provided to a height of not less than: - 1,800mm (5'-11") above the floor in a shower stall.
- 1.200mm (3'-11") above the rims of bathtubs with shower heads. - 400mm (15 3/4") above the rim of bathtubs with no shower.

#### 13, PLUMBING

- 1. The owner and/or the contractor are responsible for the design layout and the installation of the plumbing system.
- 2. Where a private sewage system is required or utalized, the design, evaluation, construction or alteration of a new system as the case may be, shall be undertaken by a qualified person registered undertake such work.

#### 14, HEATING AND AIR CONDITIONING

1. The owner and/or contractor are responsible for the design/layout and installation of the heting and air conditioning system.

#### 15, NATURAL VENTILATION

- 1. Roof vents designed to prevent entry of rain, snow and insects.
- 2. Vents shall be distributed uniformly on opposite sides of the building with not less than 25% of the opening at either the top or bottom of the space.

#### 16, MECHANICAL VENTILATION

1. The owner and/or contractor are responsible for the design/layout and installation of the mechanical ventilation system in compliance with the OBC

### 17, CAULKING

1. Caulking shall be provided between masonry, siding or stucco and adjacent door and window frame or trim and anywhere else where it is required to prevent the entry of water into the structure.

#### 18. DOORS AND WINDOWS

- 1. Exterior doors and windows within 6'-7" from grade shall be constructed to resist forced entry. Doors shall be equipped with a dead bolt lock.
- 2. The principle entry door shall either a door viewer, transparent glazing or a sidelight.

#### 19. GUARDS TO COMPLY WITH O.B.C. 9.8.8

- 1. Maximum opening in any guard must be able to prevent passage of a 100mm (4") diameter spereical object.
- 2. Guard attachment to comply with one of the methods details in SB-7 of the supplementary quidelines to the OBC.
- 3. A guard is to be provided at every location where there is a difference in elevation from floor, stairs or ramp to adjust surfaces or more than 600mm (5/8")
- 4. Minimum quard heights to be as follows:
- 800mm (2'-7") for stairs measured vertically above a line drawn - 900mm (2'-11") for porches, decks, balconies and landings not
- through stair nosings. - more than 1,800mm (5'-11") above adjacent ground
- 1.070mm (3'6") for porches, decks, balconies and landings more floor or other surface areas.
- than 1,800mm (5'-11") above adjacent ground floor or other surface areas.

#### 20. ALARMS AND DETECTORS

- 1. Interconnected Smoke and Carbon Monoxide Alarm required, complete with visual and audible signalling hardware, As per CAN/ULC 5531 & NFPA 72.
- 2. At least one interconnected smoke & carbon monoxide alarm shall be installed on or near the ceiling on each floor level and basement level 900mm (2'-11") or more above an adjacent
- 3. A interconnected smoke & carbon monoxide alarm shall be installed on or near the ceiling adjustment to every sleeping

#### 21, GARAGE GASPROOFING

- 1. The walls and ceiling of an attached garage shall be constructed and sealed to provide an effective barrier to exhaust fumes.
- 2. Doors between the dwelling and attached garage shall be weatherstripped and have a self closer.

#### 22. ELECTRICAL

- 1. An exterior light controlled by a wall switch is required at every entrance and in every kitchen, bedroom, living room, dining room utility room, vestibule, hallway, garage and car port. A switch recepticle may be provided instead of a light in bedroom and living rooms.
- 2. Basements require a light for every 30 sq. m (323 sq. ft) conrolled by a switch at the head of the stairs.
- 3. Stairs shall be lighted and except where serving an unfinished basement shall be controlled by a 3-way switch at the head and and foot of the stairs,



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DRAWING SCHEDULE		
PAGE *	PAGE NAME	REVISION DATE
AO	NOTES & SCHEDULES	6/16/2025
A1	FRONT & REAR ELEVATIONS	6/16/2025
<b>A</b> 2	RIGHT & LEFT ELEVATIONS	6/16/2025
ДЗ	FOUNDATION PLAN	T.B.D.
Д4	MAIN FLOOR PLAN	6/16/2025
ДБ	SECOND FLOOR PLAN	6/16/2025
<u> </u>	GARAGE ROOF LAYOUT	6/16/2025
<b>R</b> 2	MAIN ROOF LAYOUT	6/16/2025
ū	CROSS-SECTION A	T.B.D.
D2	CROSS-SECTION B	T.B.D.
D3	WALL SECTIONS	T.B.D.

### PROPOSED COTTAGE FOR

Arjan & Marlene Kremers 121 Ordnance Avenue Turkey Point, NOE 1WO

THE UNDERSIGNED HAS REVIEWED AND TAKES RESPONSIBILITY FOR THIS DESIGN AND HAS THE QUALIFICATIONS AND MEETS THE REQUIREMENTS SET OUT IN THE ONTARIO BUILDING CODE TO DESIGN THE WORK SHOWN.

QUALIFICATION INFORMATION

REQUIRED UNLESS DESIGN IS EXEMPT UNDER 2.17.5.1 OF THE BUILDING CODE.

HENRY DALM

SIGNATURE

39111

NOTES & SCHEDULES

DRAWN BY: Claudius Dalm | SCALE: As Noted

DESIGN BY: Henry/Claudius

CHECKED BY: Henry Dalm


PROJECT: Kremers

CONCEPT PLANS ONLY: NOT FOR CONSTRUCTION

DATE: 6/16/2025


# FRONT ELEVATION

SCALE: 7/32" = 1'-0"

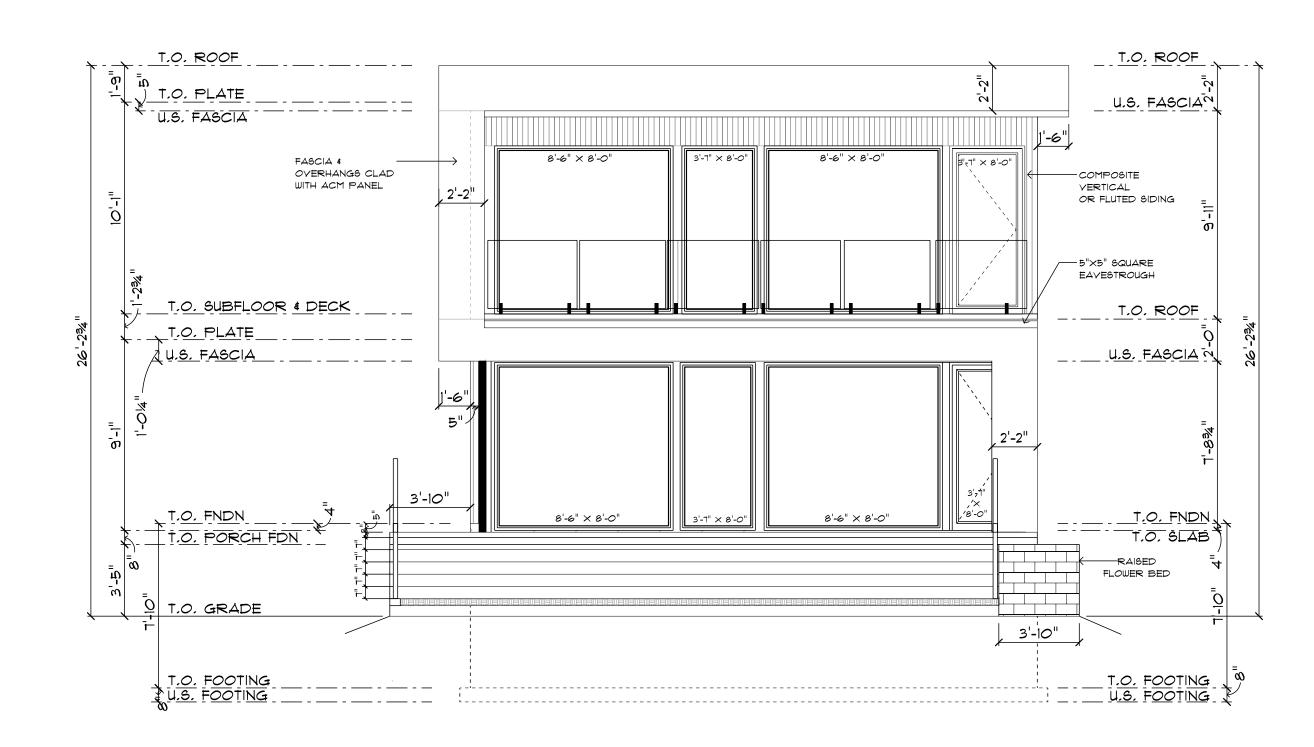

# REAR ELEVATION

SCALE: 7/32" = 1'-0"

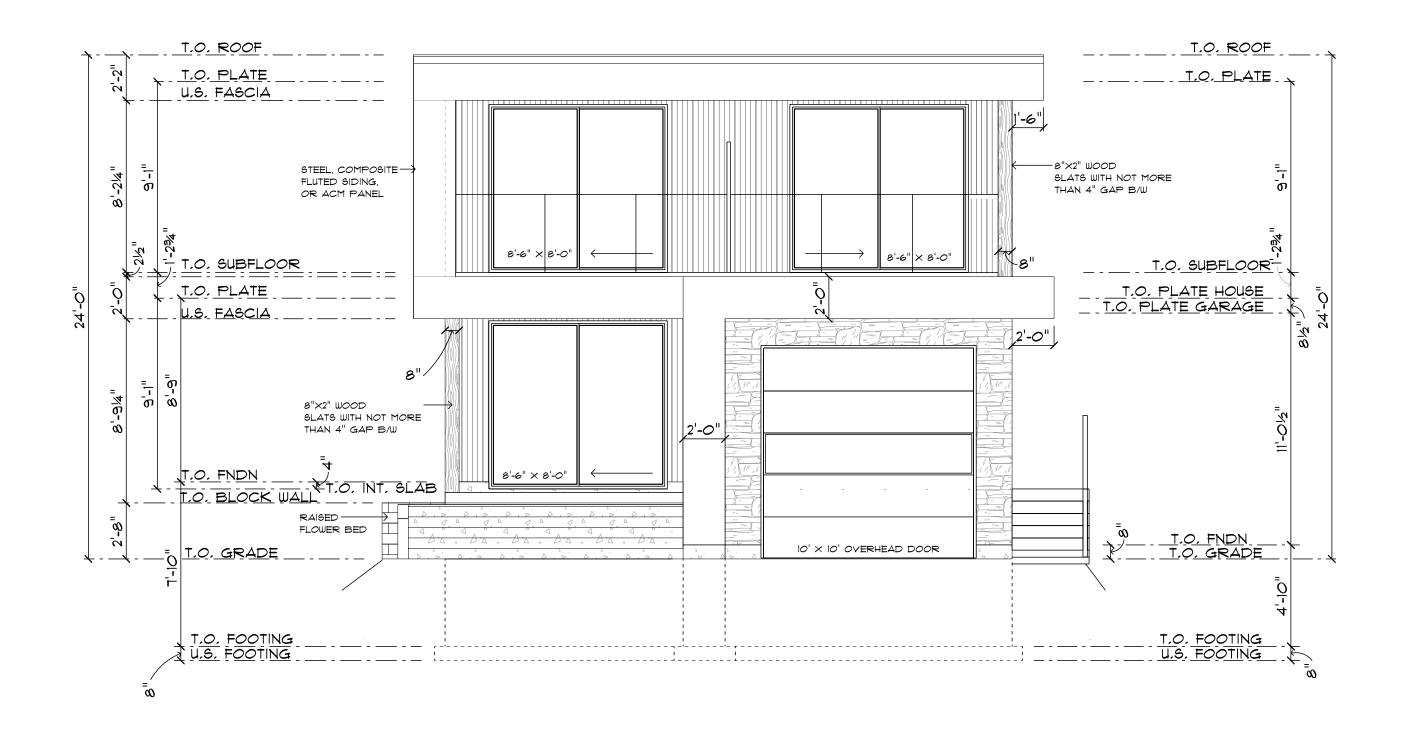

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HENRY DALM

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## FRONT & REAR ELEVATIONS

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DESIGN BY: Henry/Claudius

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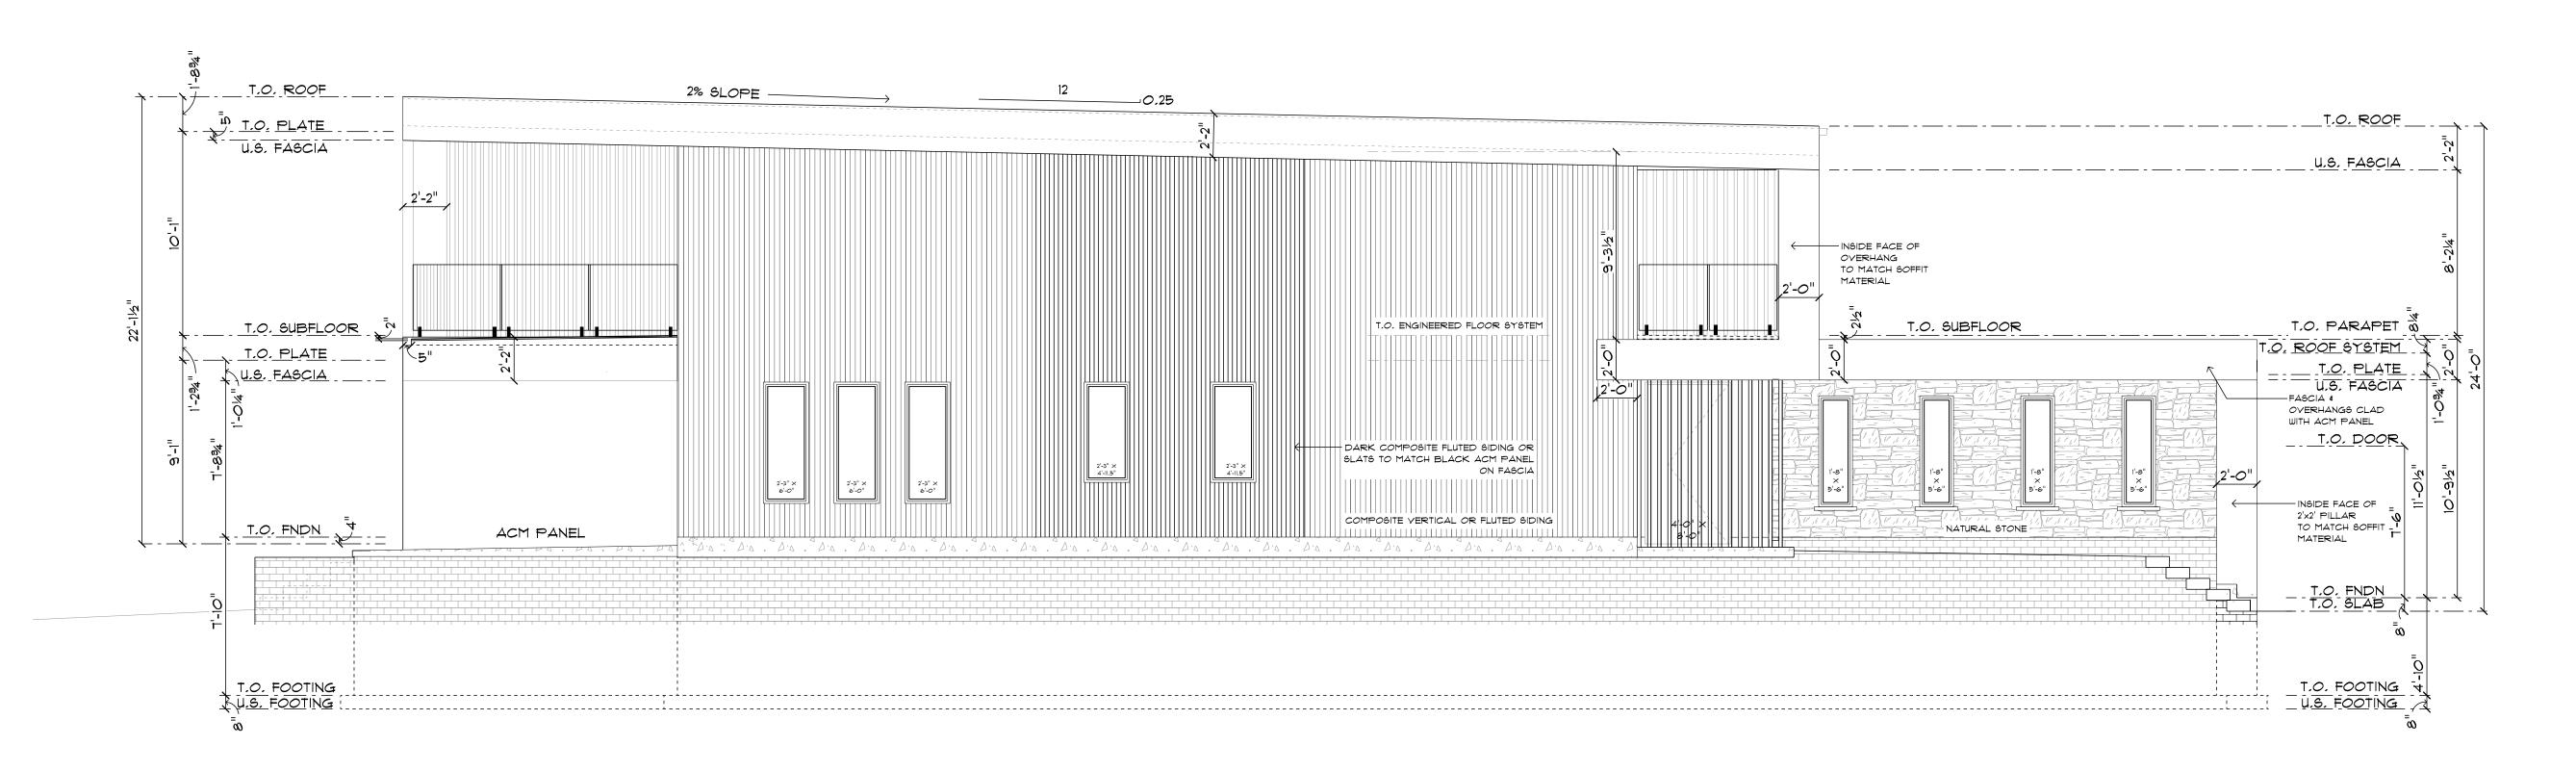


PROJECT: Kremers

DATE: 6/16/2025


# RIGHT ELEVATION

SCALE: 7/32" = 1'-0"



# LEFT ELEVATION

SCALE: 7/32" = 1'-0"

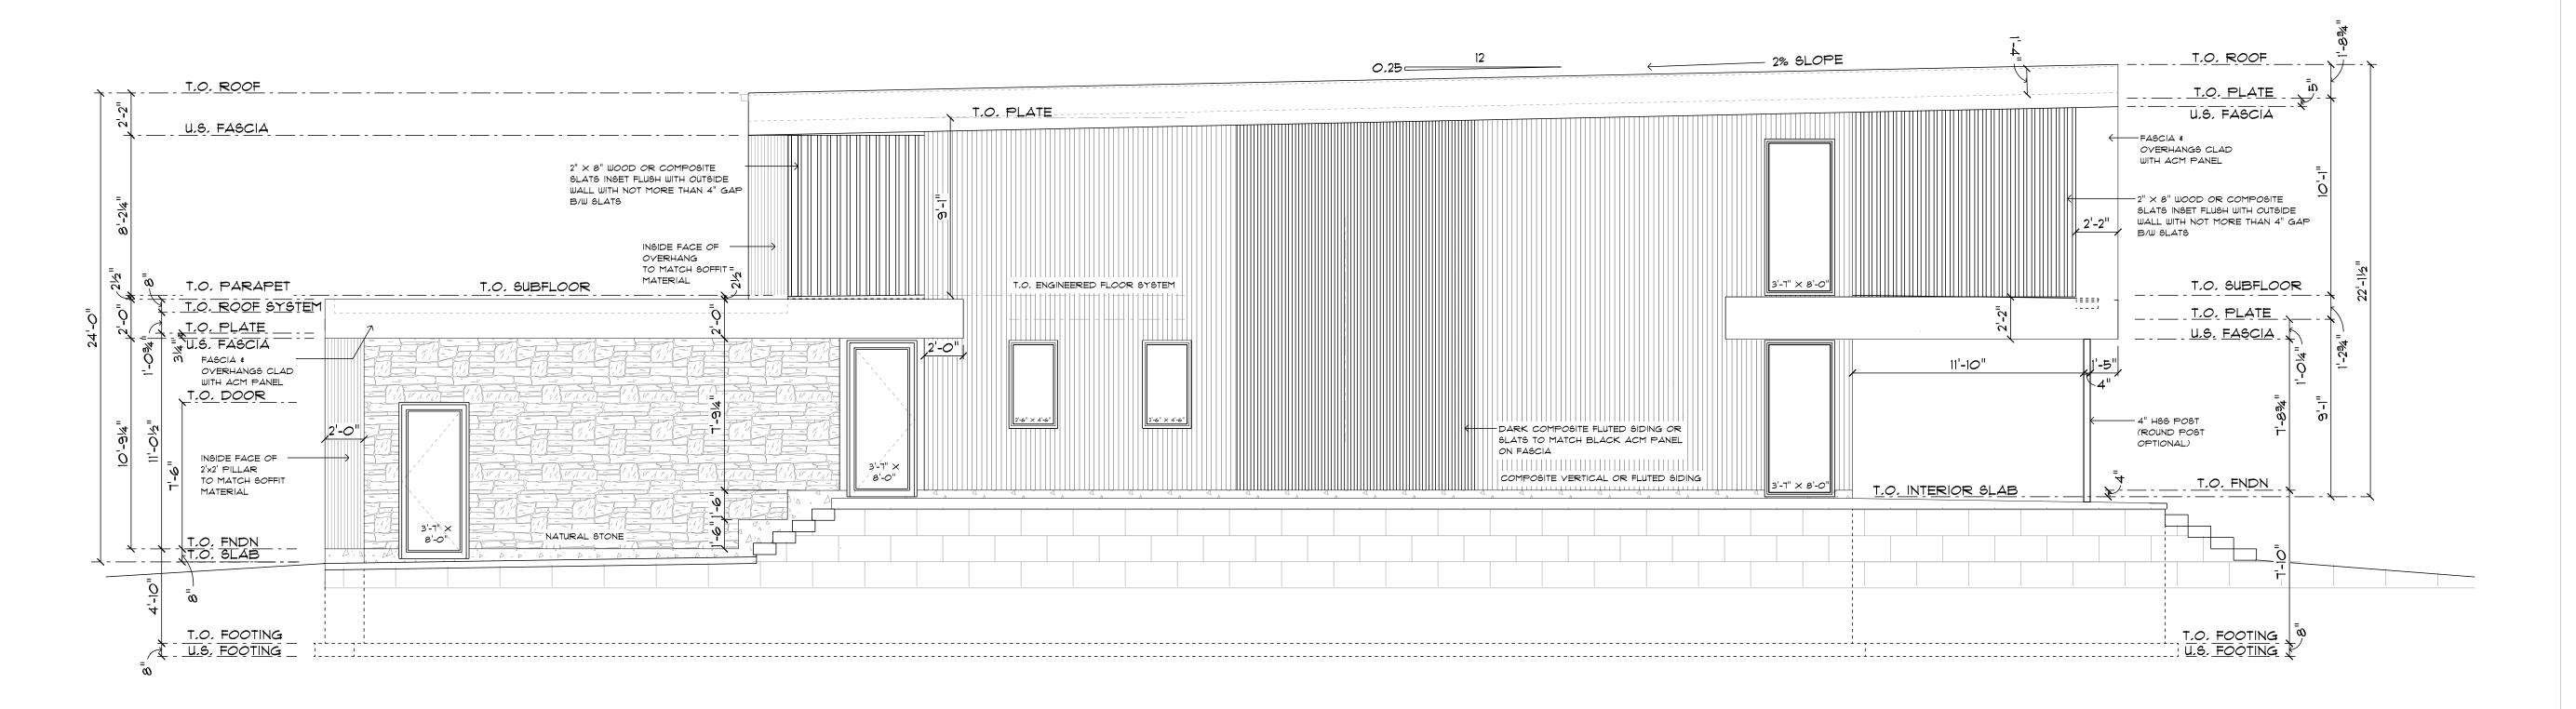

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# RIGHT & LEFT ELEVATIONS

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DESIGN BY: Henry/Claudius

CHECKED BY: Henry Dalm


PROJECT: Kremers

DATE: 6/16/2025

# MAIN FLOOR

SCALE: 7/32" = 1'-0"

SEE ROOF LAYOUT RI FOR ROOF FRAMING DETAILS

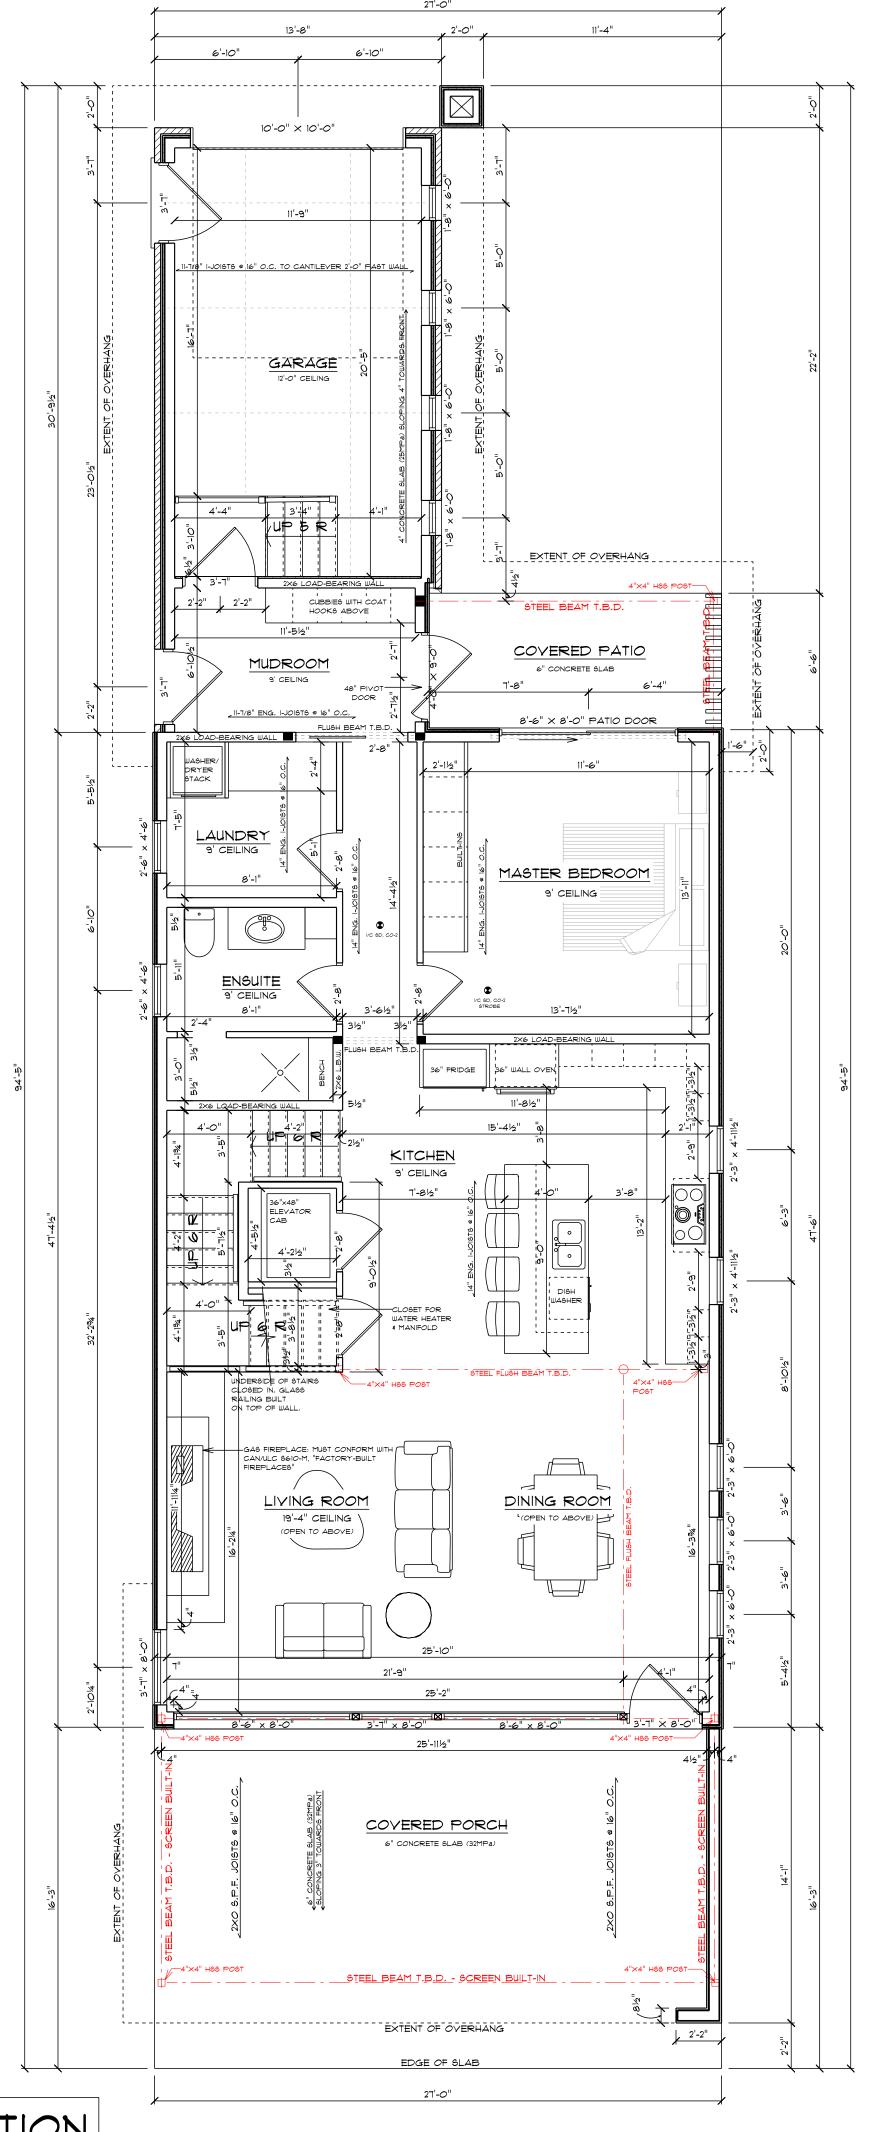



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### SQUARE FOOTAGES:

MAIN LIVING SPACE = 1384 FT^2
GARAGE = 293 FT^2
REAR COVERED PATIO = 90 FT^2
FRONT PATIO = 432 FT^2 (324
COVERED)
CONCRETE PATO = 270 FT^2

## PROPOSED COTTAGE FOR:

Arjan & Marlene Kremers
121 Ordnance Avenue
Turkey Point, NOE IWO

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2,17,5,1 OF THE BUILDING CODE,

HENRY DALM

39111

BCIN

NAME

SIGNATURE

## MAIN FLOOR

DRAWN BY: Claudius Dalm SCALE: 0.2188" = 1'-0"

DESIGN BY: Henry/Claudius

DATE: 6/16/2025

PROJECT: Kremers

CHECKED BY: Henry Dalm


Д4

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# SECOND FLOOR

SCALE: 7/32" = 1'-0"

SEE ROOF LAYOUT R2 FOR ROOF FRAMING DETAILS



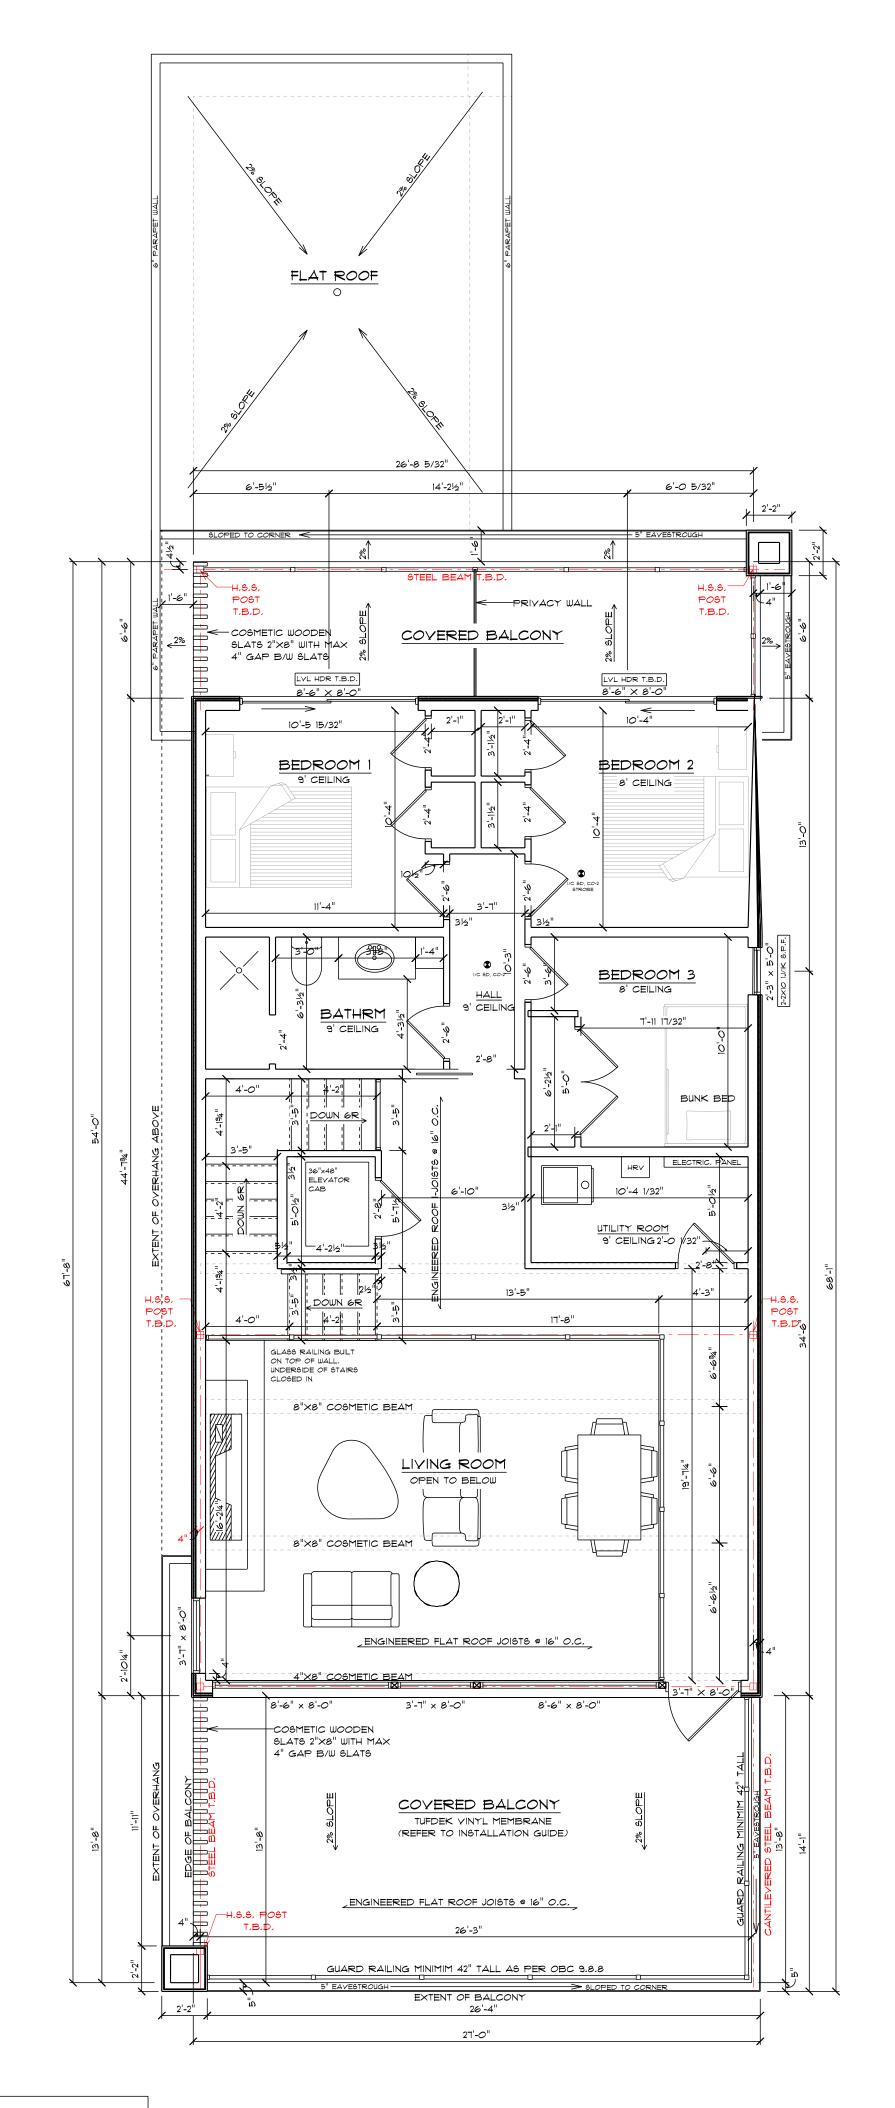

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## SQUARE FOOTAGES:

MAIN LIVING SPACE = 819 FT^2
(EXCLUDING STAIRWELL &
ELEVATOR)
FRONT BALCONY = 340 FT^2
REAR BALCONUY = 173 FT^2

## PROPOSED COTTAGE FOR:

Arjan & Marlene Kremers
121 Ordnance Avenue
Turkey Point, NOE IWO

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HENRY DALM

39111

SIGNATURE

## SECOND FLOOR

DRAWN BY: Claudius Dalm | SCALE: 0.2188" = 1'-0"

DESIGN BY: Henry/Claudius

CHECKED BY: Henry Dalm

DATE: 6/16/2025

PROJECT: Kremers




# SITE PLAN: 121 ORDNANCE AVENUE, TURKEY POINT

TOTAL LOT AREA = 744.2 SQUARE METERS

PROPOSED COTTAGE (INCLUDING COVERED
PORCHES & ATTACHED GARAGE) = 2204 FT^2 OR 204.8 SQUARE METERS

EXISTING BRICK SUN ROOM = 15.3 SQUARE METERS 15.3/744.2 \* 100 = 2%

LOT COVERAGE = 204.8/744.2 \* 100 = 27.5% + 2% FOR ACCESSARY STRUCTURE

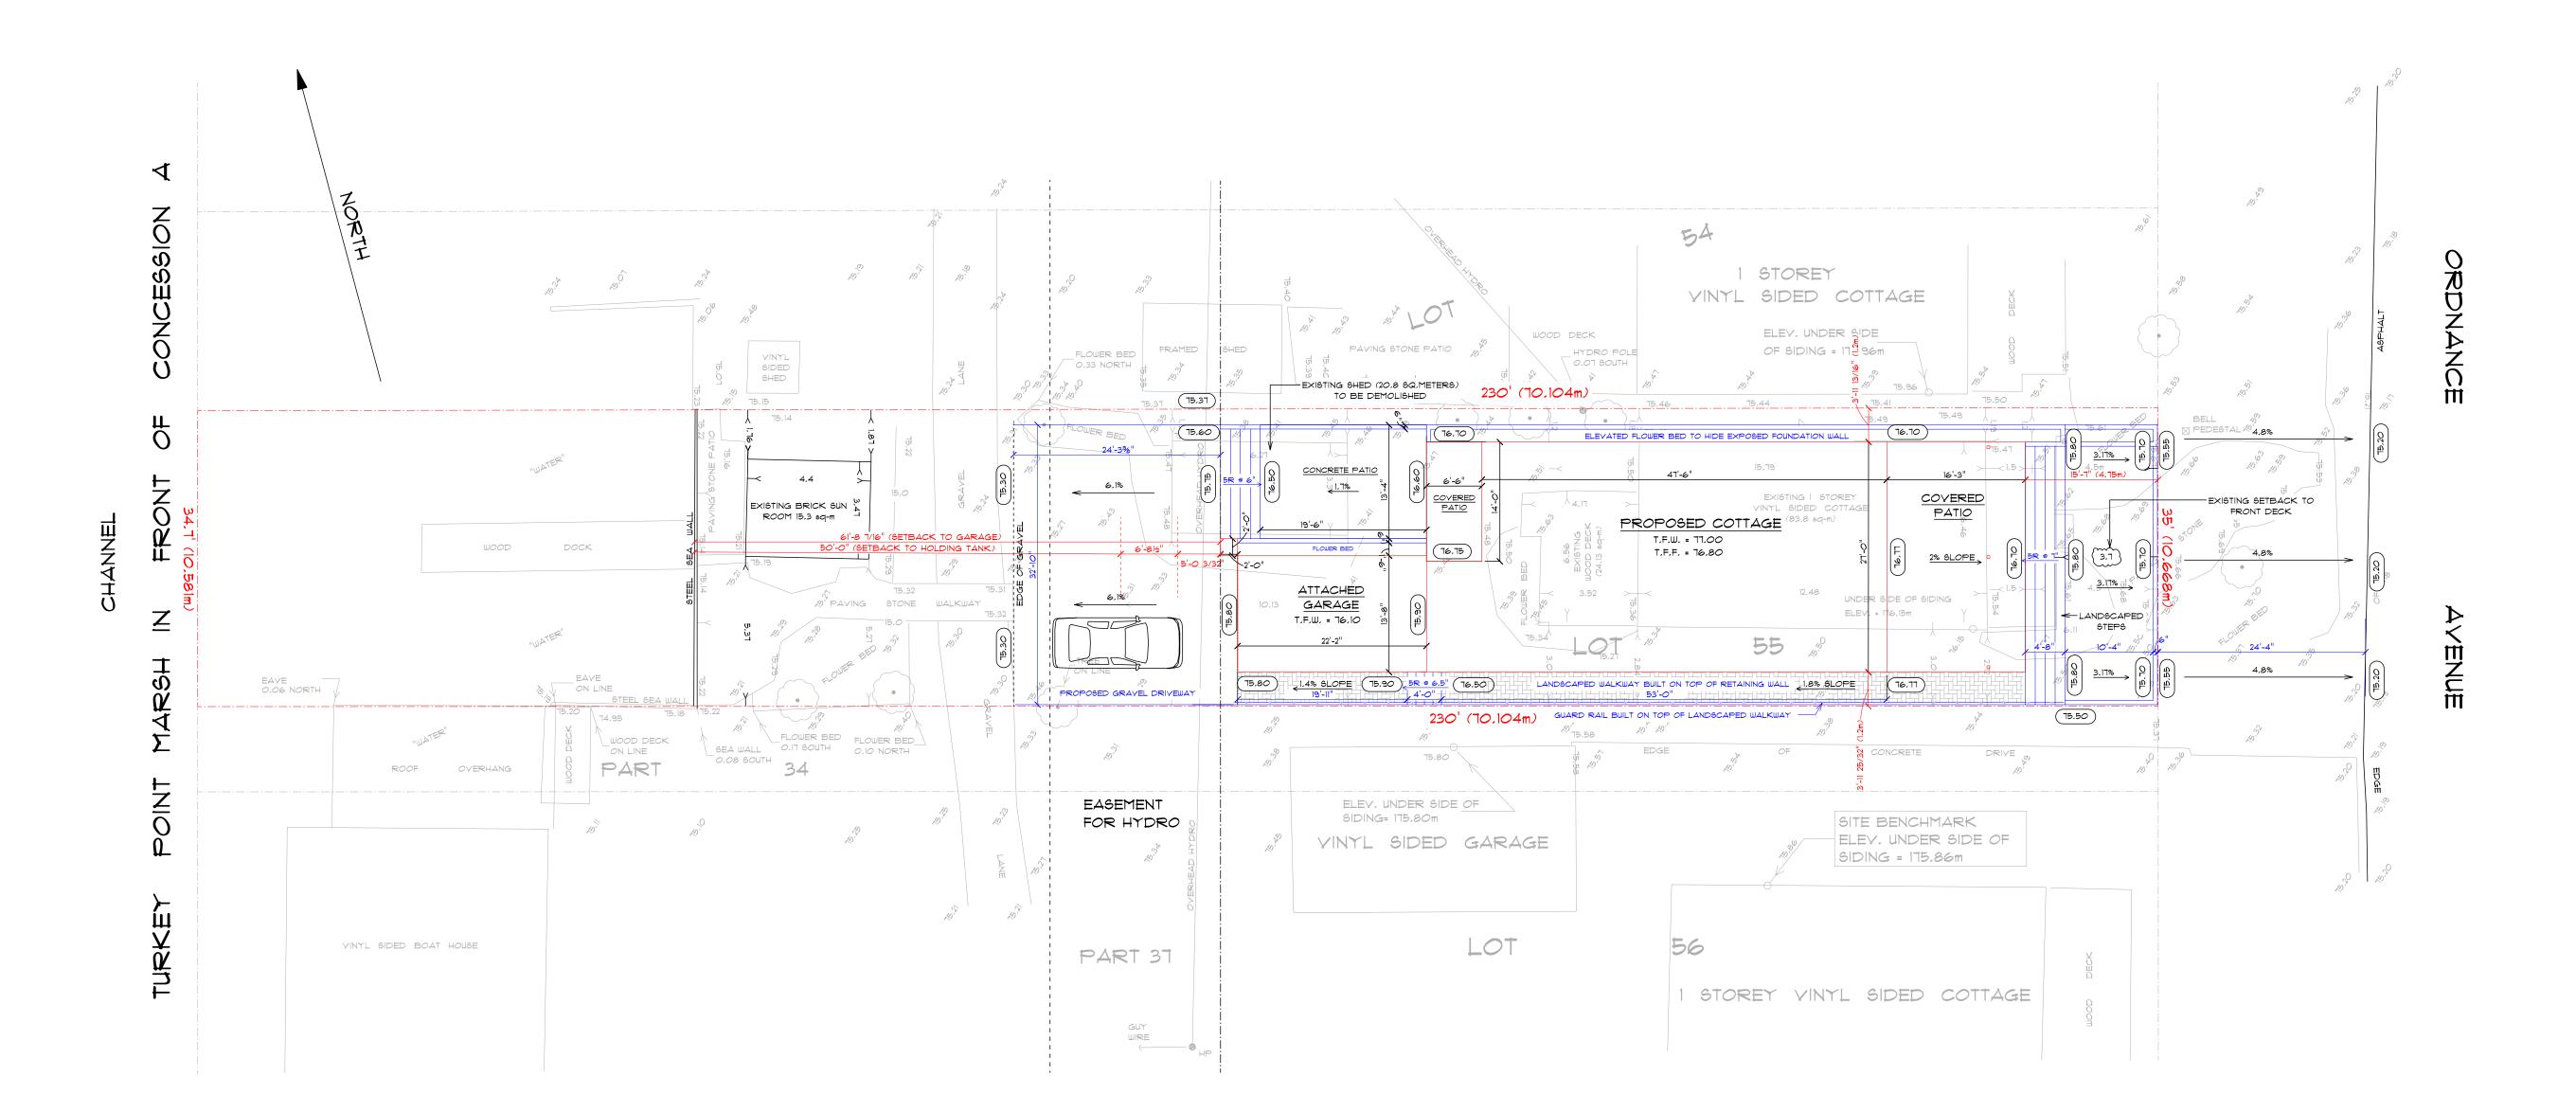



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# PROPOSED COTTAGE FOR:

Arjan & Marlene Kremers
121 Ordnance Avenue
Turkey Point, NOE 1WO

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HENRY DALM

39111 BCIN

SIGNATURE

## SITE PLAN

DRAWN BY: Claudius Dalm | SCALE: 0.0938" = 1'-0"

DESIGN BY: Henry/Claudius

CHECKED BY: Henry Dalm


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PROJECT: Kremers


#### **CONTEXT MAP**

Geographic Township of CHARLOTTEVILLE



### Legend

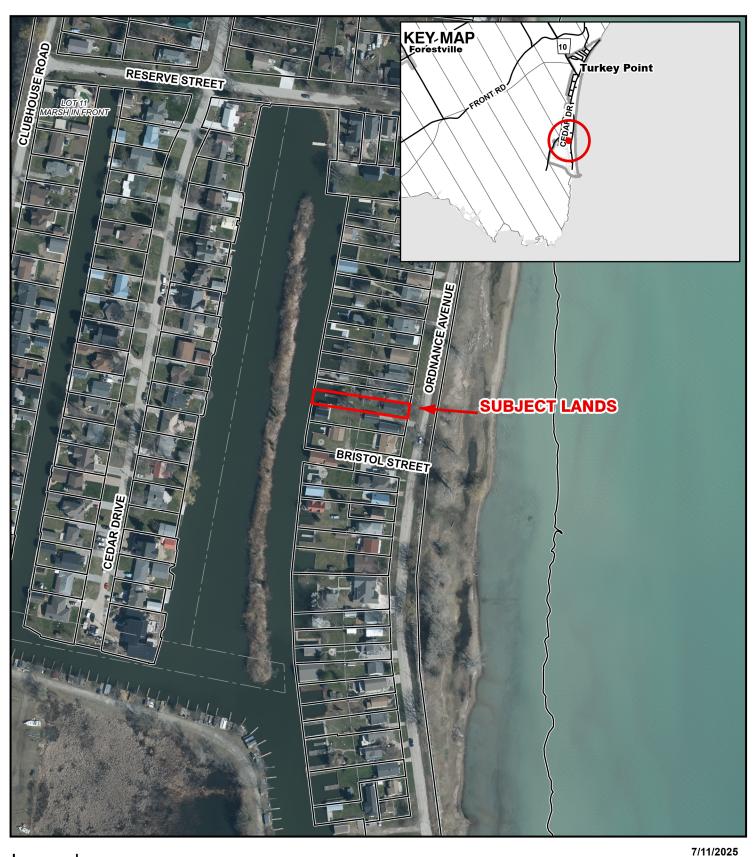


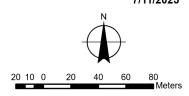

#### MAP B

#### **ZONING BY-LAW MAP**

Geographic Township of CHARLOTTEVILLE

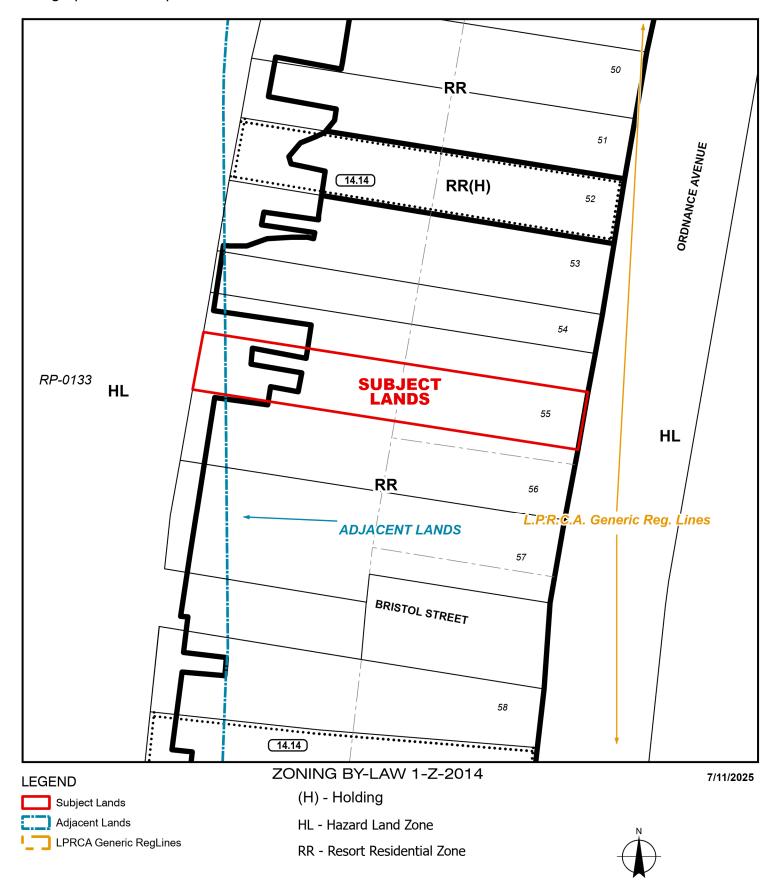

MAP C ANPL2025210

#### **CONCEPTUAL PLAN**

Geographic Township of CHARLOTTEVILLE

