

Planning Department Development Application Form

Complete Application

A complete development application consists of the following:

- 1. A properly completed and signed application form (signature must be original in planners file);
- 2. Supporting information adequate to illustrate your proposal as indicated in **Section**H of this application form (plans are required in paper copy and digital PDF format);
- 3. Written authorization from the registered owner of the subject lands where the applicant is not the owner as per Section N; and,
- 4. Cash, debit or cheque payable to Norfolk County in the amount set out in the user fees By-Law.

The above information is required to ensure that your application is given full consideration. An incomplete or improperly prepared application will not be accepted and may result in delays during the processing of the application. This application must be typed or printed in ink and completed in full.

Pre-Submission Consultation "Pre-consultation":

A pre-consultation meeting with staff is required for all applications; however, minor applications may be exempted depending on the nature of the proposal, with approval from the Director of Planning or delegate. The purpose of a pre-consultation meeting is to provide the applicant with an opportunity to present the proposed application, discuss potential issues, and for the County and Agency staff to identify the required information and materials to be submitted with the application in order for it to be considered complete. The applicant has the opportunity to make revisions to the application prior to submission, without the additional costs of recirculation fees. It may be necessary to seek the assistance of independent professional help (for example, a planning consultant or engineer) for complex applications. If a pre-consultation meeting has been held to discuss your development, please include a copy of the Pre-consultation minutes with your application as part of the submission package. It should be noted that pre-consultation minutes are valid for one year after the meeting date.

Development Application Process

Once an application has been deemed complete by a planner, it will be circulated to public agencies and County departments for review and comments. Notice of the application is also provided to adjacent land owners. The comments received assist the planner with the review and recommendation/approval of your application. The time involved in processing an application varies depending upon its complexity and its



acceptability to the other agencies and is subject to statutory *Planning Act* decision timeframes.

An additional fee will be required if a review by the Long Point Region Conservation Authority or by the Grand River Conservation Authority is deemed necessary by planning staff and/or by the Authority. A separate cheque payable to the Long Point Region Conservation Authority or the Grand River Conservation Authority is required in accordance with their fee schedule at the same time your application is submitted.

Additional studies required as part of the complete application shall be at the sole expense of the applicant. It should also be noted that in some instances peer reviews may be necessary to review particular studies and that the cost shall be at the expense of the applicant. The company to complete the peer review shall be selected by the County.

If the application is withdrawn prior to the circulation to commenting agencies, the entire original fee will be refunded. If withdrawn after the circulation to agencies, half the original fee will be refunded. If your drawings are required to be recirculated there will be an additional fee. Also, please note that if your engineering drawings require more than three reviews due to revisions by the owner or failure to revise your engineering drawings as requested, an additional fee will be charged. No refund is available after the public meeting and/or after approval of application.

Notification Sign Requirements

For the purpose of public notification and in order for staff to locate your lands for appropriate applications (zoning, subdivision, condominium or official plan) you will be given a sign to indicate the intent and purpose of your development application. It is your responsibility to:

- 1. Post one sign per frontage in a conspicuous location on the subject lands;
- 2. Ensure one sign is posted at the front of the subject lands at least three feet above ground level, not on a tree;
- 3. Notify the Planner when the sign is in place in order to avoid processing delays; and
- 4. Maintain the sign until the development application is finalized and thereafter removed.

Contact Us

For additional information or assistance in completing this application, please contact a planner at 519-426-5870 or 519-875-4485 extension 1842 or planning@norfolkcounty.ca. Please submit the completed application and fees to the attention of the Planning Department at 185 Robinson Street, Suite 200, Simcoe, ON N3Y 5L6.




For Office Use Only: File Number Related File Number Pre-consultation Meeting Application Submitted Complete Application		Conservation Authority Fee Well & Septic Info Provided		
Che	ck the type of planning applic	ation(s) you are submitting.		
	Official Plan Amendment			
\checkmark	Zoning By-Law Amendment			
	Temporary Use By-law			
	Draft Plan of Subdivision/Vac	ant Land Condominium		
	☐ Condominium Exemption			
	Site Plan Application			
	☐ Extension of a Temporary Use By-law			
	Part Lot Control			
	Cash-in-Lieu of Parking			
	Renewable Energy Project or Radio Communication Tower			
zonir	ng provision on the subject land or official plan designation of the	result of this application (for example: a special s to include additional use(s), changing the zone subject lands, creating a certain number of lots, or		
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-				
-				
_				
Dran	perty Assessment Roll Numbe	γ.		
LIOP	renty Assessinent Ron Numbe	I		



A. Applicant Information Name of Owner It is the responsibility of the owner or applicant to notify the planner of any changes in ownership within 30 days of such a change. Address Town and Postal Code Phone Number Cell Number **Email** Name of Applicant Address Town and Postal Code Phone Number Cell Number **Email** Name of Agent Address Town and Postal Code Phone Number Cell Number **Email** Please specify to whom all communications should be sent. Unless otherwise directed, all correspondence and notices in respect of this application will be forwarded to both owner and agent noted above. ☐ Owner ☐ Agent ☐ Applicant Names and addresses of any holder of any mortgagees, charges or other encumbrances on the subject lands:



B. Location, Legal Description and Property Information 1. Legal Description (include Geographic Township, Concession Number, Lot Number, Block Number and Urban Area or Hamlet): Municipal Civic Address: Present Official Plan Designation(s): Present Zoning: ____ 2. Is there a special provision or site specific zone on the subject lands? ☐ Yes ☐ No If yes, please specify corresponding number: 3. Present use of the subject lands: 4. Please describe **all existing** buildings or structures on the subject lands and whether they are to be retained, demolished or removed. If retaining the buildings or structures, please describe the type of buildings or structures, and illustrate the setback, in metric units, from front, rear and side lot lines, ground floor area, gross floor area, lot coverage, number of storeys, width, length, and height on your attached sketch which must be included with your application: 5. If an addition to an existing building is being proposed, please explain what it will be used for (for example: bedroom, kitchen, or bathroom). If new fixtures are proposed, please describe. 6. Please describe all proposed buildings or structures/additions on the subject lands. Describe the type of buildings or structures/additions, and illustrate the setback, in

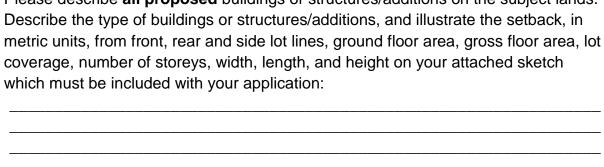



7.	Are any existing buildings on the subject lands designated under the <i>Ontario</i> Heritage Act as being architecturally and/or historically significant? Yes \square No \square	
	If yes, identify and provide details of the building:	_
8.	If known, the length of time the existing uses have continued on the subject lands:	
9.	Existing use of abutting properties:	•
10	. Are there any easements or restrictive covenants affecting the subject lands?	-
	\square Yes \square No If yes, describe the easement or restrictive covenant and its effect:	_
	Purpose of Development Application ote: Please complete all that apply. Up grading the existing single residential cotta	age to new 1,2
1.	Please explain what you propose to do on the subject lands/premises which makes this development application necessary:	-
2.	Please explain why it is not possible to comply with the provision(s) of the Zoning By-law/and or Official Plan:	-
3.	Does the requested amendment alter all or any part of the boundary of an area of settlement in the municipality or implement a new area of settlement in the municipality? ☐ Yes ☐ No If yes, describe its effect:	
4.	Does the requested amendment remove the subject land from an area of employment? ☐ Yes ☐ No If yes, describe its effect:	
		-



•	· ·	Does the requested amendment alter, replace, or delete a policy of the Official Plan's \square Yes \square No If yes, identify the policy, and also include a proposed text of the		
	policy amendment	(if additional space is required, please attach a separate sheet):		
	Description of land Frontage:	intended to be severed in metric units:		
	Depth:			
	Width:			
	Lot Area:			
	Present Use:			
	Proposed Use:			
	•	size (if boundary adjustment):		
	•	stment, identify the assessment roll number and property owner of		
		the lands to which the parcel will be added:		
	Description of land	intended to be retained in metric units:		
	Frontage:			
	Depth:			
	Width:			
	Lot Area:			
	Present Use:			
	Proposed Use:			
	Buildings on retain	ed land:		
	Description of prop	osed right-of-way/easement:		
	Depth:			
	Width:			
	Area:			
	Proposed use:			
	Name of person(s) leased or charged	, if known, to whom lands or interest in lands to be transferred, (if known):		



9. Site Information	Zoning	Proposed
Please indicate unit of measure	ment, for example: m, m ² o	r %
Lot frontage		
Lot depth		
Lot width		
Lot area		
Lot coverage		
Front yard		
Rear yard		
Left Interior side yard		
Right Interior side yard		
Exterior side yard (corner lot)		
Landscaped open space		
Entrance access width		
Exit access width		
Size of fencing or screening		
Type of fencing		
10.Building Size		
Number of storeys		
Building height		
Total ground floor area		
Total gross floor area		
Total useable floor area		
11.Off Street Parking and Load	ing Facilities	
Number of off street parking spa	aces	
Number of visitor parking space		
Number of accessible parking s		
Number of off street loading fac		



12. Residential (if applicable)		
Number of buildings existing	:	
Number of buildings propose	:d:	
Is this a conversion or addition	on to an existing building	? □ Yes □ No
If yes, describe:		
Туре	Number of Units	Floor Area per Unit in m2
Single Detached		_
Semi-Detached		_
Duplex		_
Triplex		_
Four-plex		_
Street Townhouse		
Stacked Townhouse		
Apartment - Bachelor		_
Apartment - One bedroom		_
Apartment - Two bedroom		_
Apartment - Three bedroom		_
Other facilities provided (for or swimming pool):	example: play facilities, ι	underground parking, games room,
13. Commercial/Industrial Us	es (if applicable)	
Number of buildings existing	:	
Number of buildings propose	:d:	
Is this a conversion or addition	on to an existing building	? □ Yes □ No
If yes, describe:		
Indicate the gross floor area	by the type of use (for ex	xample: office, retail, or storage):



Seating Capacity (for assembly halls or similar):
Total number of fixed seats:
Describe the type of business(es) proposed:
Total number of staff proposed initially:
Total number of staff proposed in five years:
Maximum number of staff on the largest shift:
Is open storage required: ☐ Yes ☐ No
Is a residential use proposed as part of, or accessory to commercial/industrial use?
☐ Yes ☐ No If yes please describe:
14. Institutional (if applicable)
Describe the type of use proposed:
Seating capacity (if applicable):
Number of beds (if applicable):
Total number of staff proposed initially:
Total number of staff proposed in five years:
Maximum number of staff on the largest shift:
Indicate the gross floor area by the type of use (for example: office, retail, or storage):
15. Describe Recreational or Other Use(s) (if applicable)



D.	Previous Use of the Property
1.	Has there been an industrial or commercial use on the subject lands or adjacent lands? \Box Yes \Box No \Box Unknown
	If yes, specify the uses (for example: gas station or petroleum storage):
2.	Is there reason to believe the subject lands may have been contaminated by former uses on the site or adjacent sites? \square Yes \square No \square Unknown
3.	Provide the information you used to determine the answers to the above questions:
	·
	
4.	If you answered yes to any of the above questions in Section D, a previous use inventory showing all known former uses of the subject lands, or if appropriate, the adjacent lands, is needed. Is the previous use inventory attached? \square Yes \square No
E.	Provincial Policy
1.	Is the requested amendment consistent with the provincial policy statements issued under subsection 3(1) of the <i>Planning Act, R.S.O. 1990, c. P. 13</i> ? \square Yes \square No
	If no, please explain:
2.	It is owner's responsibility to be aware of and comply with all relevant federal or provincial legislation, municipal by-laws or other agency approvals, including the Endangered Species Act, 2007. Have the subject lands been screened to ensure that development or site alteration will not have any impact on the habitat for endangered or threatened species further to the provincial policy statement subsection 2.1.7? \square Yes \square No
	If no, please explain:



3.	Have the subject lands been screened to ensure that development or site alteration will not have any impact on source water protection? \square Yes \square No			
	If no, please explain:			
	Note: If in an area of source water Wellhead Protection Area (WHPA) A, B or C please attach relevant information and approved mitigation measures from the Risk Manager Official.			
 Are any of the following uses or features on the subject lands or within 50 the subject lands, unless otherwise specified? Please check boxes, if app 				
	Livestock facility or stockyard (submit MDS Calculation with application)			
	□ On the subject lands or □ within 500 meters – distance			
	Active mine site within one kilometre On the subject lands or within 500 meters – distance Industrial or commercial use (specify the use(s)) On the subject lands or within 500 meters – distance Active railway line On the subject lands or within 500 meters – distance Seasonal wetness of lands On the subject lands or within 500 meters – distance Erosion On the subject lands or within 500 meters – distance Abandoned gas wells On the subject lands or within 500 meters – distance			



F. Servicing and Access 1. Indicate what services are available or proposed: Water Supply ☐ Municipal piped water □ Communal wells ☐ Individual wells ☐ Other (describe below) Sewage Treatment ☐ Municipal sewers ☐ Communal system ☐ Septic tank and tile bed in good working order ☐ Other (describe below) Storm Drainage ☐ Storm sewers □ Open ditches ☐ Other (describe below) 2. Existing or proposed access to subject lands: ☐ Municipal road ☐ Provincial highway □ Unopened road ☐ Other (describe below) Name of road/street: G. Other Information 1. Does the application involve a local business? \square Yes \square No If yes, how many people are employed on the subject lands? 2. Is there any other information that you think may be useful in the review of this

application? If so, explain below or attach on a separate page.



H. Supporting Material to be submitted by Applicant

In order for your application to be considered complete, **folded** hard copies (number of paper copies as directed by the planner) and an **electronic version (PDF) of the properly named site plan drawings, additional plans, studies and reports** will be required, including but not limited to the following details:

- 1. Concept/Layout Plan
- 2. All measurements in metric
- 3. Key map
- 4. Scale, legend and north arrow
- 5. Legal description and municipal address
- 6. Development name
- 7. Drawing title, number, original date and revision dates
- 8. Owner's name, address and telephone number
- 9. Engineer's name, address and telephone number
- 10. Professional engineer's stamp
- 11. Existing and proposed easements and right of ways
- 12. Zoning compliance table required versus proposed
- 13. Parking space totals required and proposed
- 14. All entrances to parking areas marked with directional arrows
- 15. Loading spaces, facilities and routes (for commercial developments)
- 16. All dimensions of the subject lands
- 17. Dimensions and setbacks of all buildings and structures
- 18. Location and setbacks of septic system and well from all existing and proposed lot lines, and all existing and proposed structures
- 19. Gross, ground and useable floor area
- 20. Lot coverage
- 21. Floor area ratio
- 22. Building entrances, building type, height, grades and extent of overhangs
- 23. Names, dimensions and location of adjacent streets including daylighting triangles
- 24. Driveways, curbs, drop curbs, pavement markings, widths, radii and traffic directional signs
- 25. All exterior stairways and ramps with dimensions and setbacks
- 26. Retaining walls including materials proposed
- 27. Fire access and routes
- 28. Location, dimensions and number of parking spaces (including visitor and accessible) and drive aisles
- 29. Location of mechanical room, and other building services (e.g. A/C, HRV)
- 30. Refuse disposal and storage areas including any related screening (if indoors, need notation on site plan)
- 31. Winter snow storage location



- 32. Landscape areas with dimensions
- 33. Natural features, watercourses and trees
- 34. Fire hydrants and utilities location
- 35. Fencing, screening and buffering size, type and location
- 36. All hard surface materials
- 37. Light standards and wall mounted lights (plus a note on the site plan that all outdoor lighting is to be dark sky compliant)
- 38. Business signs (make sure they are not in sight lines)
- 39. Sidewalks and walkways with dimensions
- 40. Pedestrian access routes into site and around site
- 41. Bicycle parking
- 42. Architectural elevations of all building sides
- 43. All other requirements as per the pre-consultation meeting

	addition, the following additional plans, studies and reports, including but not limited may also be required as part of the complete application submission:
	Zoning Deficiency Form
	On-Site Sewage Disposal System Evaluation Form (to verify location and condition)
	Architectural Plan
	Buildings Elevation Plan
	Cut and Fill Plan
	Erosion and Sediment Control Plan
	Grading and Drainage Control Plan (around perimeter and within site) (existing and proposed)
	Landscape Plan
	Photometric (Lighting) Plan
	Plan and Profile Drawings
	Site Servicing Plan
	Storm water Management Plan
	Street Sign and Traffic Plan
	Street Tree Planting Plan
	Tree Preservation Plan
	Archaeological Assessment
П	Environmental Impact Study



	Functional Servicing Report
	Geotechnical Study / Hydrogeological Review
	Minimum Distance Separation Schedule
	Noise or Vibration Study
	Record of Site Condition
	Storm water Management Report
	Traffic Impact Study – please contact the Planner to verify the scope required
Site	e Plan applications will require the following supporting materials:
	 Two (2) complete sets of the site plan drawings folded to 8½ x 11 and an electronic version in PDF format Letter requesting that the Holding be removed (if applicable) A cost estimate prepared by the applicant's engineer An estimate for Parkland dedication by a certified land appraiser Property Identification Number (PIN) printout
_	andard condominium exemptions will require the following supporting materials:
Ш	Draft condominium declaration
	Property Identification Number (PIN) printout

Your development approval might also be dependent on Ministry of Environment and Climate Change, Ministry of Transportation or other relevant federal or provincial legislation, municipal by-laws or other agency approvals.

All final plans must include the owner's signature as well as the engineer's signature and seal.

I. Development Agreements

A development agreement may be required prior to approval for site plan, subdivision and condominium applications. Should this be necessary for your development, you will be contacted by the agreement administrator with further details of the requirements including but not limited to insurance coverage, professional liability for your engineer, additional fees and securities.



J. Transfers, Easements and Postponement of Interest

The owner acknowledges and agrees that if required it is their solicitor's responsibility on behalf of the owner for the registration of all transfer(s) of land to the County, and/or transfer(s) of easement in favour of the County and/or utilities. Also, the owner further acknowledges and agrees that it is their solicitor's responsibility on behalf of the owner for the registration of postponements of any charges in favour of the County.

K. Permission to Enter Subject Lands

Permission is hereby granted to Norfolk County officers, employees or agents, to enter the premises subject to this application for the purposes of making inspections associated with this application, during normal and reasonable working hours.

For the purposes of the Municipal Freedom of Information and Protection of Privacy Act,

L. Freedom of Information

I authorize and consent to the use by or the disclosure to any person or public body any information that is collected under the authority of the Planning Act, R.S.O. 1990, c. P. 13 for the purposes of processing this application. Owner/Applicant Signature Date M. Owner's Authorization If the applicant/agent is not the registered owner of the lands that is the subject of this application, the owner(s) must complete the authorization set out below. _____ am/are the registered owner(s) of the I/We lands that is the subject of this application. I/We authorize to make this application on my/our behalf and to provide any of my/our personal information necessary for the processing of this application. Moreover, this shall be your good and sufficient authorization for so doing. Owner Date




Owner

Date

N. Declaration	
1, Samel Hiltz of	Nortoth Genty
solemnly declare that:	
all of the above statements and the statements transmitted herewith are true and I make this s believing it to be true and knowing that it is of t under oath and by virtue of <i>The Canada Evide</i>	olemn declaration conscientiously he same force and effect as if made
Declared before me at:	11/1
Simcoe, Norfolk County	Last 10
	Owner/Applicant Signature
in Norfolk County	
This 2/ day of Jaly	
A.D., 20	
KAPOORe	
A Commissioner, etc.	



Kaitlyn Anderson Poole, a Commissioner, etc., Province of Ontario. for the Corporation of Norfolk County. Expires September 2, 2024.

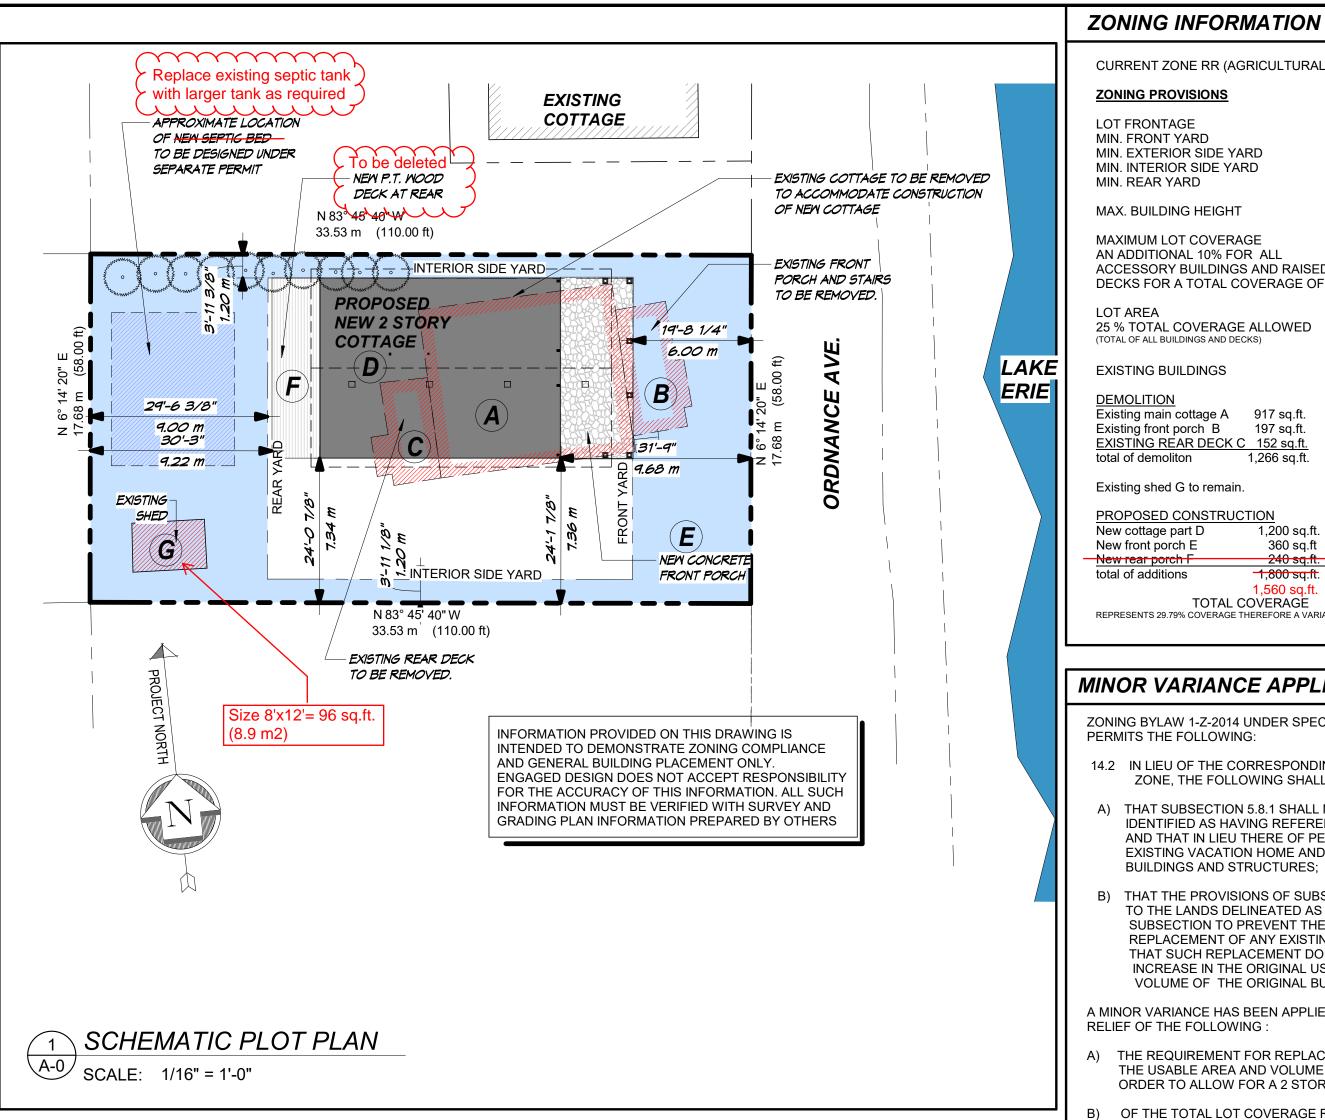

CURRENT ZONE RR (AGRICULTURAL ZONE) **ZONING PROVISIONS** LOT FRONTAGE MIN. FRONT YARD 6.0m MIN. EXTERIOR SIDE YARD 6.0m MIN. INTERIOR SIDE YARD 1.2m MIN. REAR YARD 9.0m MAX. BUILDING HEIGHT 9.1m MAXIMUM LOT COVERAGE 15% PLUS AN ADDITIONAL 10% FOR ALL ACCESSORY BUILDINGS AND RAISED DECKS FOR A TOTAL COVERAGE OF 25%. LOT AREA 6,379 sq.ft. 592.84 n 25 % TOTAL COVERAGE ALLOWED 1,595 sq.ft. 148.21 m (TOTAL OF ALL BUILDINGS AND DECKS) EXISTING BUILDINGS 1,266 sq.ft. 117.66m² **DEMOLITION** Existing main cottage A 917 sq.ft. Existing front porch B 197 sq.ft. EXISTING REAR DECK C 152 sq.ft. - 1,266 sq.ft. -117.66m total of demoliton Existing shed G to remain. 100 sq.ft. 9.29n 1,200 sq.ft. 111.52 m² New cottage part D 360 sq.ft 33.45 m² New front porch E 240 sq.ft. 22.30 m² Delete New rear porch F 1,800 sq.ft. 167.29m² 1,800 sq.ft. 167.29m total of additions 1.560 sq.ft. 144.94 m2 1,560 sq.ft. 144.94 m TOTAL COVERAGE 1,900 sq.ft. 176.58m² REPRESENTS 29.79% COVERAGE THEREFORE A VARIANCE WILL BE REQUIRED.


MINOR VARIANCE APPLICATION REQUIRED


ZONING BYLAW 1-Z-2014 UNDER SPECIAL PROVISIONS SECTION 14 PERMITS THE FOLLOWING:

- 14.2 IN LIEU OF THE CORRESPONDING PROVISIONS OF THE RR ZONE, THE FOLLOWING SHALL APPLY:
- A) THAT SUBSECTION 5.8.1 SHALL NOT APPLY TO THE LANDS IDENTIFIED AS HAVING REFERENCE TO THIS SUBSECTION AND THAT IN LIEU THERE OF PERMITTED USES SHALL INCLUDE EXISTING VACATION HOME AND ACCESSORY USES, **BUILDINGS AND STRUCTURES**;
- B) THAT THE PROVISIONS OF SUBSECTION 5.8.2 SHALL NOT APPLY TO THE LANDS DELINEATED AS HAVING REFERENCE TO THIS SUBSECTION TO PREVENT THE REPAIR, REBUILDING OR REPLACEMENT OF ANY EXISTING VACATION HOME PROVIDED THAT SUCH REPLACEMENT DOES NOT CONSTITUTE AN INCREASE IN THE ORIGINAL USABLE FLOOR AREA OR VOLUME OF THE ORIGINAL BUILDING:

A MINOR VARIANCE HAS BEEN APPLIED FOR IN ORDER TO PROVIDE RELIEF OF THE FOLLOWING:

- A) THE REQUIREMENT FOR REPLACEMENT BUILDINGS TO MATCH THE USABLE AREA AND VOLUME OF THE ORIGINAL BUILDING IN ORDER TO ALLOW FOR A 2 STOREY COTTAGE IN ITS PLACE.
- B) OF THE TOTAL LOT COVERAGE REQUIREMENT OF 25% TO ALLOW FOR PROPOSED BUILDINGS AND DECKS TO ALLOW FOR 29.79% TOTAL COVERAGE ON THE LOT COMPRISED OF 18.8% FOR THE COTTAGE AND 10.99% FOR THE PORCH AND DECKS.

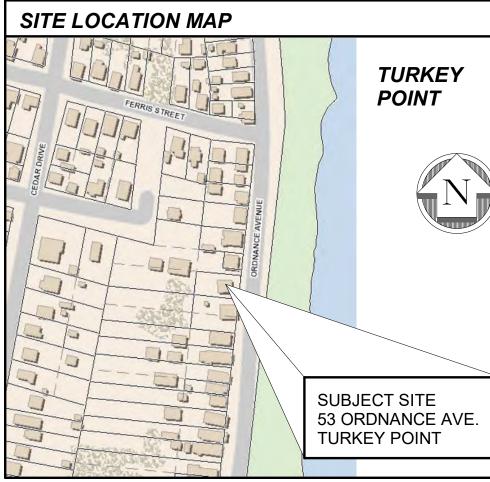

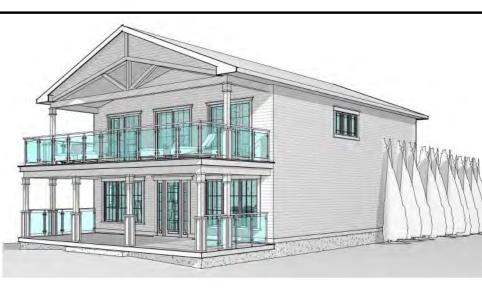

ARTIST CONCEPT - FINAL CONSTRUCTION TREATS ARE SUB-	JECT TO	C
CHANGE THE DISCRETION OF THE BUILDER AND HOME OWN	ER.	

DRAWING LIST

	O.B.C. DESIGN MATRIX, GENERAL NOTES AND DESIGN DATA
_1	EOLINDATION AND MAIN ELOOP PLANS

P1 = POST RATED FOR 8 kip AND CENTERED ON FOOTING PAD

P2 = POST RATED FOR 20 kip AND CENTERED ON FOOTING PAD

P3 = POST RATED FOR 30 kip AND CENTERED ON FOOTING PAD

FOUNDATION ON PAD FOOTING. REFER TO

FOUNDATION ON PAD FOOTING. REFER TO

PAD FOOTING SCHEDULE FOR FOOTING SIZE.

SQ1 = 16"x16" SQUARE PIER FOUNDATION WITH 10M DOWELS

@ CORNERS EMBEDDED INTO ON PAD FOOTING.

3" MIN. COVER. REFER TO PAD FOOTING SCHEDULE

PAD FOOTING SCHEDULE FOR FOOTING SIZE.

- FOUNDATION AND MAIN FLOOR PLANS 2nd. FLOOR PLAN AND OPTIONAL LAYOUT
- ROOF PLAN . DETAILS AND BUILDING ELEVATIONS A-4 BUILDING SECTIONS AND DETAILS

L4 = L- 5 X 3 1/2 X 3/8" ANGLE = 11'-5" MAX. SPAN

L5 = L- 6 X 4 X 1/2" ANGLE = 13'-5" MAX. SPAN

STEEL TELE-POST SCHEDULE


DECK PIER FOUNDATION SCHEDULE:

ST1 = 12" DIA. CONCRETE SONO TUBE

ST2 = 16" DIA. CONCRETE SONO TUBE

FOR FOOTING SIZE.

BUILDING CODE REVIEW SUMMARY Certificate of Practice Number: 5494 Contact Information: TEL. 1 (519) 909-9246 EMAIL: dave@engageddesign.ca ndividual who reviews and accepts responsibility for Design Activities: DAVID B. BENNETT Location of Project: NORFOLK COUNTY Ontario Building Code Matrix Parts 9 **Project Description** Major Occupancy (s) GROUP C - SINGLE FAMILY HOME Structural Importance Category NORMAL Building Area (m²) conditioned space Existing O m² New 112m² (1200 ft²) Total 112m² (1200 ft²) 5 Gross Area (m²) Number of Storeys Below Grade NONE Above Grade 2 STOREYS

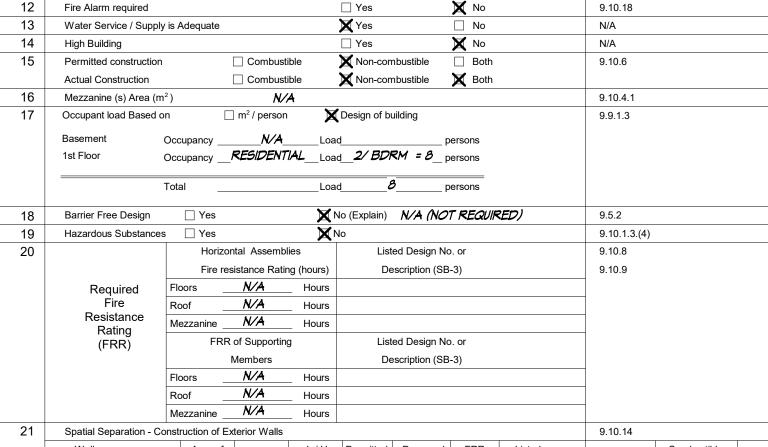

Firm Name: ENGAGED CUSTOM HOME DESIGN

LICENCE # 7019

(garage)

Total building area

Total Gross Floor area

Number of Streets / Access Routes

Building Classification

Standpipe required

Sprinkler System Proposed

Address: 22 WALPOLE DRIVE JARVIS ONTARIO NOA 1J0

LICENSED TECHNOLOGIST OAA

Name of Project: COTTAGE REPLACEMENT - HILTZ & SCHEBESCH FAMILIES

53 ORDNANCE AVE. TURKEY POINT, ONTARIO

Addition

unconditioned space Existing O m² New O Total Om² (O ft²)

GROUP C - SINGLE FAMILY HOME

Second floor Existing O m² New 112m² (1200 ft²) Total 112m² (1200 ft²)

Entire Building

Not required

□ Selected Compartments

☐ Basement ☐ In lieu of roof rating

☐ Selected Floor Areas

■ New Construction □ Part 11

Main floor Existing *O m*² New *112m*² (1200 ft²) Total 112m² (1200 ft²) 1.4.1.2.[A]

11.1 to 11.4

112m² (1200 ft²)

224m² (2400 ft²)

STAMP

ASSOCIATION

OF ARCHITECTS

DEC 15 '21

DAVID B. BENNETT

LICENCE

responsible control with respect to design activities

The Technologist noted above has exercised

OBC Section Reference

1.4.2.1 & Table T1.4.2.1 B

X Part 9

1.1.2.[A]

9.10.1.3

1.4.1.2.[A]

1.4.1.2.[A] & 9.10.4

construction

Nonc.

Cladding

combustible

Construction

Construction

22

9.10.20

9.10.2

9.10.8.2

9.10.2

WEST (REAR YARD) 58m² *9.22m* N/A --------SOUTH (SIDE) --------EAST (LAKE YARD) 38%

% of (Hours) Design or

% of

N/A | 7% |

ENERGY EFFICIENCY DESIGN ASSUMPTION MATRIX

1.2m+

EBF

70m²

[A] GENERAL NOTES

[B] SB-12 COMPLIANCE OPTIONS

NORTH (SIDE YARD)

THESE DRAWINGS HAVE BEEN PREPARED TO MEET OR EXCEED THE REQUIREMENTS OF SB-12 OF THE ONTARIO BUILDING CODE AS AMENDED JANUARY 1, 2012 (EnerGuide80 ®). COMPLIANCE WITH THE NEW REGULATIONS CAN BE ACHIEVED IN ONE OF THE FOUR WAYS. THE SUMMARY BELOW ITEMIZES DESIGN ASSUMPTIONS MADE IN

CONSULTATION WITH THE CLIENT PRIOR TO SUBMISSION FOR BUILIDING PERMIT AS A POINT OF REFERENCE, THIS DESIGN IS BASED ON THE PRESCRIPTIVE SB-12 PACKAGES FOUND IN SB-12-3.1.1.

IF THE CONTRACTOR CHOOSES TO ACHIEVE COMPLIANCE THROUGH ONE OF THE THREE ACCEPTED METHODS BASED ON PERFORMANCE, Energy Star ® OR EnerGuide80 ® PROGRAMS THEN THE DESIGN MUST BE INDEPENDENTLY VERIFIED BY A CERTIFIED ENERGY EVALUATOR. INDEPENDENT VERIFICATION BY A "CERTIFIED ENERGY EVALUATOR" PRIOR TO OCCUPANCY IS RECOMMENDED AS THE MOST EFFECTIVE WAY OF

ENSURING COMPLIANCE. THESE CONSULTANTS SPECIALIZE IN PERFORMING THIS TYPE OF ANALYSIS / TESTING AND WILL PROVIDE PAPERWORK CONFIRMING THE RESULTS OF THIS TESTING TO THE BUILDING DEPARTMENT AT THE POINT OF SUBSTANTIAL COMPLETION OF THE HOME.

×	SB-12 Prescriptive [SB-12 - 3.1.1]	Table: <i>SB-12 T3.1.1.2 (1P)</i> Package <i>A5</i>					
	SB-12 Performance * [SB-12 - 3.1.1]	*Attach energy performance calculations using an approved software					
	Energy Star ® * [SB-12 - 3.1.1]	* Attach BOP form. House must be labeled on completion by Energy Star					
	EnerGuide80 ® *	* House must be evaluated by NRCcan advisor and meet a rating of 80					
[C] Project Design Conditions							

Climatic Zone (SB-1): Heating Equipment Efficiency | Space Heating Fuel Source Zone 1 (<5000 degree days) **X** ≤ 92% AFUE Propane

□ Solid Fuel □ Earth Energy ☐ Zone 2 (<5000 degree days) □ ≤84% < 92 % AFUE ☐ Oil Electric

Windows+ Skylights+ Glass Doors Other Building Conditions

Wall Area = *(2770 sq.ft.) 256* m ICF basement

Walkout Basement ∮% Windows+ 14.73 % ∣ Gross Window + Area=*(408) 38* m² ICF Above Grade □ Slab on Grade □ Log / Post&Beam [D] Building Specifications

RSI / R Values | Building Component Efficiency Rating Building Component Thermal Insulation Windows & Doors OPENINGS LESS THAN 17 % OF WALL AREA, Window / Sliding Glass Doors Ceiling with Attic Space R60 THEREFORE WINDOW RATIO MAX U =0.28 R31 Ceiling without Attic Space MAX. U = 0.28 Skylights R31 Exposed Floor Mechanicals Walls above Grade R19 + R5 C.I. Space Heating Equipment *R12 + R10 C.l.* HRV Efficiency (%) 70% Basement Walls 0.80 Slab (all > 600mm below Grade) DHW Heater (EF) Slab (edge only ≤600mm below Grade) R10 Drain Water Heat Recovery 42%

Provide U-value in W./m².K or ER rating

Provide AFUE or Indicate if Condensing type combined unit used.

[E] SB-12 Performance:

Slab (all ≤600mm below Grade or heated)

Compliance achieved through performance based solutions require the support of appropriate calculations not performed directly as part of this drawing package. These calculations need to be performed by a "CERTIFIED ENERGY EVALUATOR" and the results certified by an

STRUCTURAL COMPONENT LEGEND

GENERAL SCHEDULE NOTES

- NOT ALL MEMBERS LISTED HAVE BEEN USED ON THIS BUILDING. REFER TO PLANS TO DETERMINE LOCATION, LENGTHS AND QUANTITY OF SPECIFIED MEMBERS.
- MEMBERS SPECIFIED ARE SIZED TO MIN. O.B.C. / DESIGN REQUIREMENTS. CONTRACTOR MAY SUBSTITUTE LARGER MEMBER OF THE SAME NUMBER OF PLY AND SAME SPECIES / GRADE AS MATERIALS SPECIFIED. ANY CHANGE IN SPECIES / GRADE MUST BE REVIEWED BY THE DESIGNER. CONTRACTOR SHALL NOT SUBSTITUTE WITH SMALLER MEMBERS WITH ADDITIONAL PLYS UNLESS REVIEWED BY THE DESIGNER.
- ALL NOMINAL (CONVENTIONAL) WOOD PRODUCTS ARE TO BE MINIMUM SPF #2 UNLESS OTHERWISE NOTED IN SCHEDULES AND ON PLANS.

B/U WOOD LINTEL SCHEDULE:

B/U WOOD BEAM SCHEDULE : W1 = 2- 2" x 6" SPRUCE NO. 1 WB1 = 3- 2" X 8" SPRUCE NO. 1 M2 = 2- 2" X 8" SPRUCE NO. 1 WB2 = 4- 2" X 8" SPRUCE NO. 1 D. FIR NO.1 M3 = 2- 2" X 8" WB3 = 3- 2" X 10" SPRUCE NO. 1 M4 = 2- 2" X 10" SPRUCE NO. 1 WB4 = 4- 2" X 10" SPRUCE NO. 1

W5 = 2- 2" X 10" D. FIR NO.1 WB5 = 5- 2" X 10" SPRUCE NO. 1 M6 = 2- 2" X 12" SPRUCE NO. 1 MB6 = 3- 2" X 12" SPRUCE NO. W7 = 2- 2" X 12" D. FIR NO.1 MB7 = 4- 2" X 12" SPRUCE NO. 1 WB8 = 5- 2" X 12" SPRUCE NO. 1

LINTEL NOTES:

FLOOR LOADS

1. MOOD LINTEL WITH SPANS LESS THAN 9'-10" (3m) REQUIRE 1 1/2" (38mm) MIN. BEARING LENGTH AT EACH END. SPANS GREATER THAN 9'-10" REQUIRE A MIN. 3" (76mm) BEARING LENGTH.

2. WHERE NOTED, LINTELS MUST BEAR UPON ENTIRE WIDTH OF BUILT-UP COLUMNS INDICATED WITH ADDITIONAL TRIMMER STUD FASTENED TO COLUMN AS PER TYPICAL ROUGH OPENING FRAMING.

ENGINEERED LUMBER COLUMNS

EC1 = 5.5"x5.5" PSL 2.0E POST EC2 = 3.5"x3.5" PSL 2.0E POST

C1 = 2- 2" X 4" SPRUCE NO. C2 = 3- 2" X 4" SPRUCE NO. C3 = 4- 2" X 4" SPRUCE NO. C4 = 5- 2" X 4" SPRUCE NO. C5 = 2- 2" X 6" SPRUCE NO. 1 C6 = 3- 2" X 6" SPRUCE NO. 1 C7 = 4- 2" X 6" SPRUCE NO. 1 C8 =5- 2" x 6" SPRUCE NO. 1

B/U LUMBER COLUMNS SOLID WOOD COLUMNS SNC1 = 4" x 4" #2 SPR $SNC2 = 4" \times 4" P.T.$ SMC3 = 6" x 6" #2 SPR SNC4 = 6" x 6" P.T. SMC5 = 6x6 SELECT GRADE CEDAR SMC6 = 8" x 8" P.T. SMC7 = 8" x 8" SELECT GRADE PINE

COLUMN NOTES

1. WHERE COLUMNS ARE NOT LOCATED IN A LOAD BEARING WALL THEY SHALL BE CENTERED ON PAD FOOTINGS BELOW.

2. WHERE STEEL COLUMNS BEAR ONTO STEEL BEAM BELOW, BASE PLATES SHALL BE MIN. 1/4" AND SHALL MATCH WITH LARGER DIMENSION OF BEAM FLANGE OR COLUMN WIDTH UNLESS OTHERWISE SPECIFIED, AND CONNECTED W/ BOLTS OR FIELD WELDS AS DIRECTED.

ENGINEERED WOOD BEAMS

LVL 1 = 1 3/4"x11 7/8" LVL 2.0E BY MICROLAM LVL 2 = 3 1/2"x11 7/8" LVL 2.0E BY MICROLAM LVL 3 = 5 1/4"x 9 1/2" LVL 2.0E BY MICROLAM LVL 4 = 5 1/4"x11 7/8" LVL 2.0E BY MICROLAM LVL 5 = 5 1/4"x14" LVL 2.0E BY MICROLAM

ALL BEAMS TO HAVE MIN. 3 1/2" BEARING AT EACH END. ALL JOISTS MIN. 1 1/2" BEARING AT EACH END

STEEL LOOSE MASONRY LINTEL SCHEDULE:

AS PER O.B.C. [B] 9.20.5.2 AND TABLE 9.20.5.2B. THIS CHART CAN ONLY BE USED FOR BRICK VENEER. IF OTHER MATERIALS ARE USED, THESE VALUES WILL REQUIRE FURTHER REVIEW.

L1 = L- 3 1/2 X 3 1/2 X 1/4" ANGLE = 8'-0" MAX. SPAN L2 = L- 4 X 3 1/2 X 5/16" ANGLE = 8'-9" MAX. SPAN

L3 = L- 5 X 3 1/2 X 5/16" ANGLE = 10'-10" MAX. SPAN

STEEL BEAM SCHEDULE

SB1 = W150x22 STEEL BEAM SB3 = W250x33 STEEL BEAM SB2 = W200x27 STEEL BEAM SB4 = W310x39 STEEL BEAM

FOOTING PAD SCHEDULE

PF1 = 30"x30"x14" CONCRETE PAD WITH 3-15M RE-BAR EACH WAY PF2 = 36"x36"x16" CONCRETE PAD WITH 3-15M RE-BAR EACH WAY PF3 = 42"x42"x20" CONCRETE PAD WITH 15M RE-BAR @ 12" O/C E/W PF4 = 48"x48"x22" CONCRETE PAD WITH 15M RE-BAR @ 12" O/C E/W

CONTINUOUS STRIP FOOTING SCHEDULE:

SF1 = STRIP 18"x6" CONCRETE WITH EXTERIOR WALLS

2-15M REBAR CONTINUOUS 18"x6" CONCRETE WITH 2-15M REBAR CONTINUOUS WALLS

SF2 = STRIP INTERIOR

FOOTING NOTES: ALL FOOTING PADS SHALL BE CENTERED UNDER COLUMNS. CONTRACTOR TO COORDINATE PAD LOCATIONS W/ DIMENSIONS LOCATING

ALL STRIP FOOTINGS SHALL BE CENTERED UNDER CONCRETE FOUNDATION WALLS AND INTERIOR LOAD BEARING STUD WALLS. CONTRACTOR SHALL COORDINATE FOOTING AND WALL DIMENSIONS ON PLANS AND REPORT ANY DISCREPANCIES TO THE DESIGNER PRIOR TO CONSTRUCTION.

WHERE REINFORCEMENT OF THE FOUNDATION WALLS IS REQUIRED, ALL RE-BAR SHALL BE DOWELED INTO FOOTINGS MIN. 2" EMBEDMENT (2'-0" LAP LENGTH FOR TIE-IN DOWELS) 4. ALL MASONRY BLOCK WALLS SHALL BE REINFORCED ACCORDING TO O.B.C. 2012 REQUIREMENTS.

SYMBOLS LEGEND

LOCATION: TURKEY POINT ONTARIO (PORT BURWELL VALUES USED IN CALCS)

STRUCTURAL DESIGN CRITERIA

MIN. SPECIFIED LIVE LOAD = 1.9 kPa (40 PSI) AS PER 9.4.1.1 = 2.4 kPa (50 psf) AS PER 9.4.1.1 (2) MAX. SPECIFIED LIVE LOAD SPECIFIED DEAD LOAD = 1.0 kPa (21 psf) AS SPECIFIED BY JOIST SUPPLIER

ROOF LOADS CALCULATION AS PER O.B.C. [B] 9.4.2.2. AND SB-1. S= (Cb x Ss) + Sr

WHERE Cb = basic snow load factor = 0.45 for roof spans less than 4.3m = 0.55 for roof spans in excess of 4.3m Ss = 1 in 50 year ground snow load in kPa as per SB-1 Sr = 1 in 50 year rain load in kPa as per sb-1

IN NO CIRCUMSTANCES, SHOULD THE SPECIFIED SNOW LOAD BE LESS THAN 1.0 KPA.

S = (0.55 x 1.2)+ 0.4 THEREFORE S = 1.06 kPa = 1.1 kPa

BATHROOM BUILDING ELEVATION ELEVATION REFERENCE EXHAUST FAN REFERENCE \ A101, View Name SHEET VIEW SMOKE DETECTOR BUILDING SECTION REFERENCE SMOKE / CARBON MONOXIDE DETECTOR ∖ A101 ⁄ SD / CMD ROOM NAME . NUMBER REFERENCE 101 DETAIL SECTION $\langle W1 \rangle$ SIM REFERENCE EXTERIOR WINDOW REFERENCE INTERIOR BEARING WALLS (101) EXTERIOR DOOR REFERENCE \ A101 ∕

ABBREVIATIONS

AFTG DATUM ABOVE TOP OF FOOTING ELEVATION CMD CARBONMONOXIDE DETECTOR

I.F.F. INSIDE FACE OF FOUNDATION WALLS O.F.F. OUTSIDE FACE OF FOUNDATION ALLS O.F.S. OUTSIDE FACE OF EXTERIOR SHEATHING R.S.O. ROUGH STUD OPENING SD SMOKE DETECTOR

C1 B/U WOOD COLUMN 1,2,3 ETC. EC1 ENGINEERED WOOD COLUMN 1,2,3 ETC.

P1 STEEL TELEPOST 1,2,3 ETC. PF1 PAD FOOTING 1,2,3 ETC. PSL PARALLEL STRAND LUMBER PSL1 PSL BEAM 1,2,3 ETC. SF1 CONTINUOUS STRIP FOOTING 1,2,3 ETC.

ST1 SONOTUBE PIER FOUNDATION 1,2,3 ETC. SB1 STEEL BEAM 1,2,3 ETC. SMC1 SOLID WOOD COLUMN 1,2,3 ETC. SQ1 SQUARE FOUNDATION PIER 1,2,3 ETC. M1 B/U MOOD LINTEL 1,2,3 ETC.

WB1 B/U WOOD BEAM 1.2.3 ETC.

vour investment

Consult your local NRCan Advisor for details on how this method of compliance could reduce construction costs and increase return rates on

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TO COMMENCEMENT OF CONSTRUCTION

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issued FOR BULLDING


<u> APPLICATION</u> **DECEMBER 15, 2021**

STAMP ONTARIO ASSOCIATION OF ARCHITECTS DEC 15 '21 OAA

DAVID B. BENNETT

LICENCE

7019

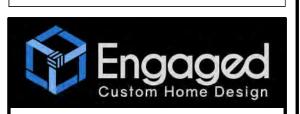

O.B.C. Qualified Design; Small Buildings

Licensed Technologist OAA

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Dave@engageddesign.ca

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COTTAGE REPLACEMENT Hiltz & Schebesch Families

53 ORDNANCE AVE. TURKEY POINT, ONTARIO NORFOLK COUNTY

Drawing Title

Email:


Web Site:

O.B.C. DESIGN MATRIX, GENERAL NOTES AND **DESIGN DATA**

Drawn By Designed By: Drawing No. D.BENNETT Checked By:

Project No. 21-02

OCTOBER 202

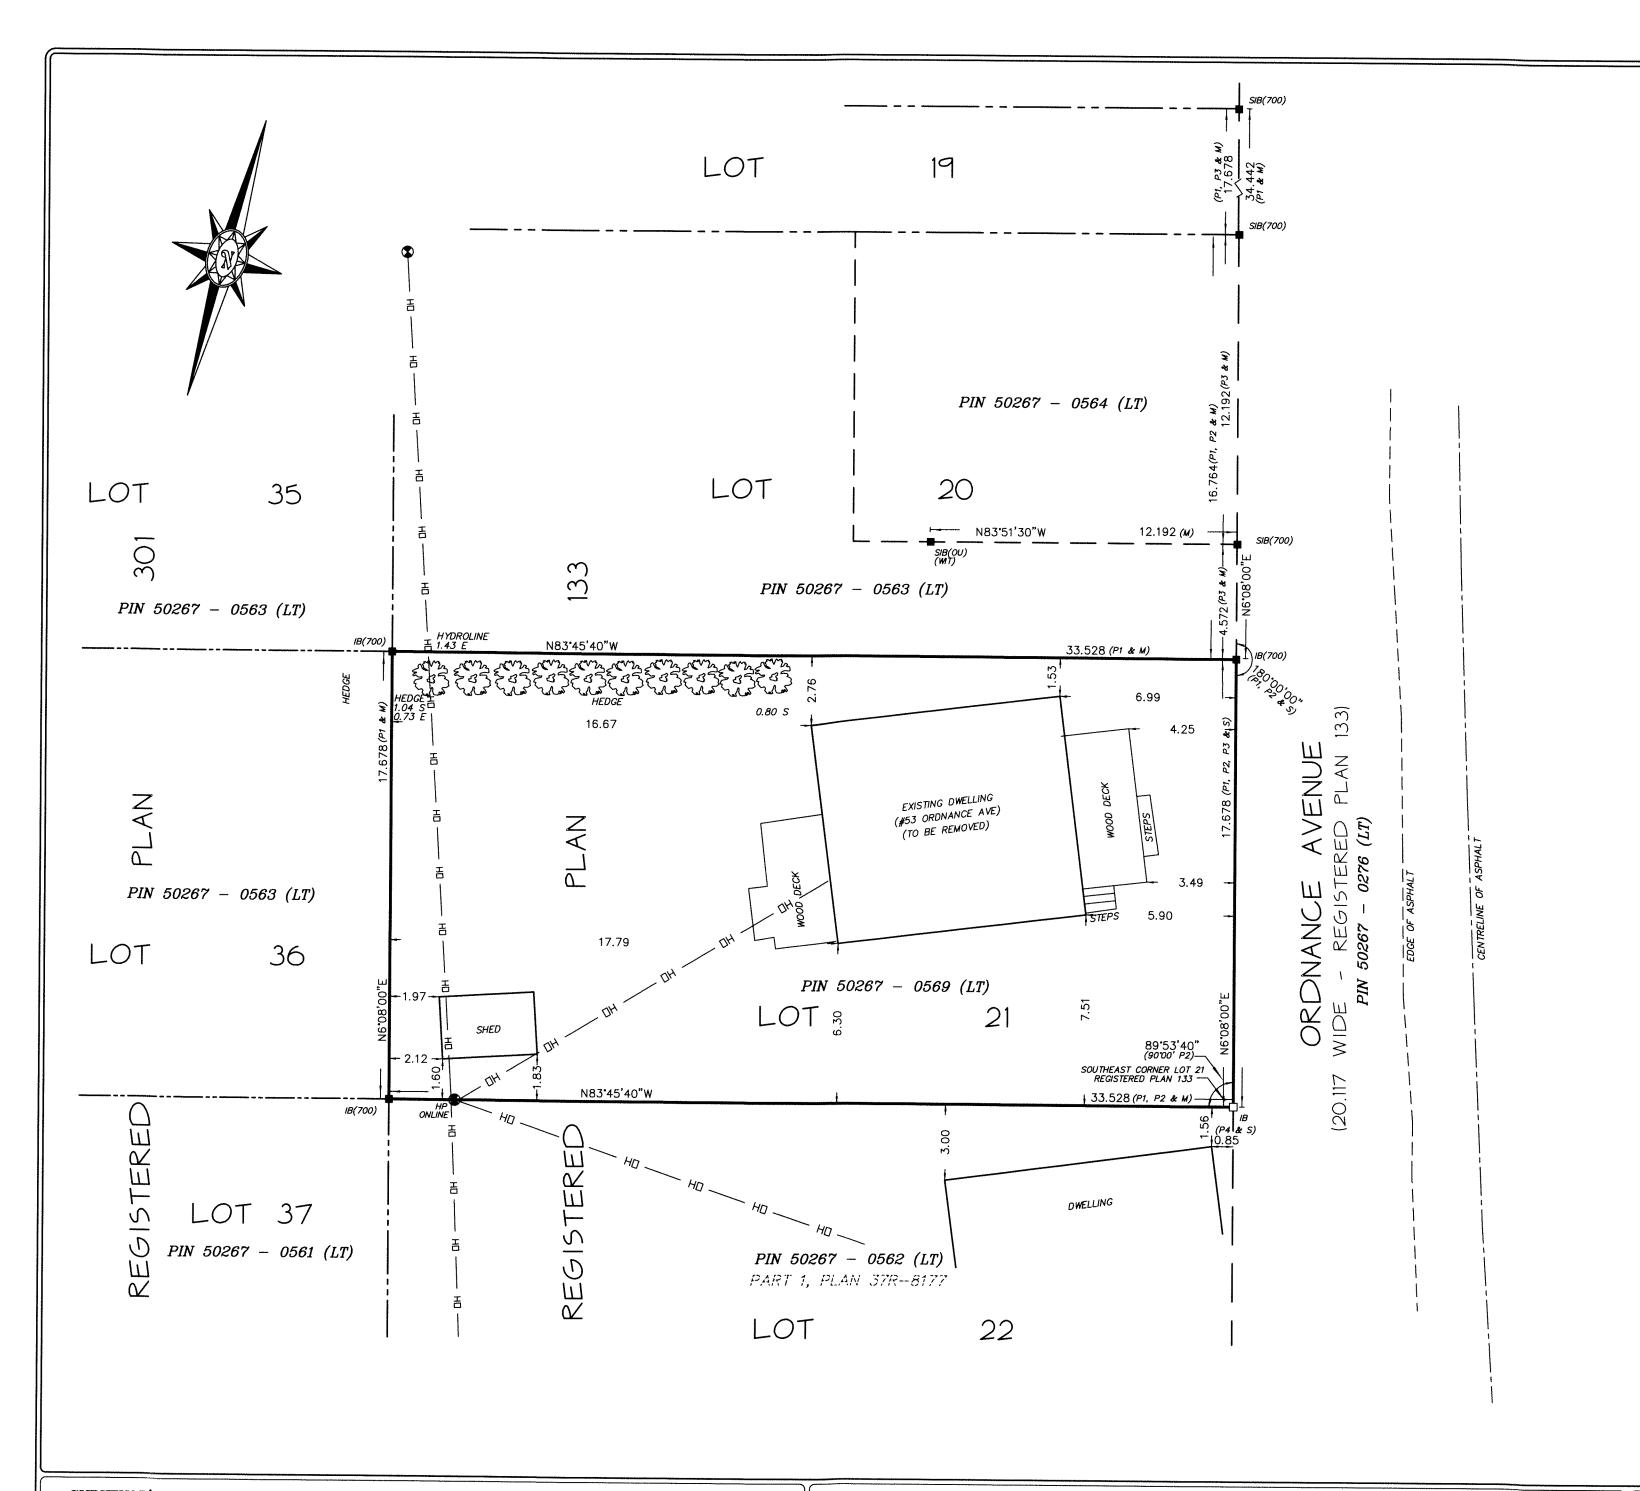

PLAN OF SURVEY

OF ALL OF

LOT 21

REGISTERED PLAN 133 (TURKEY POINT)

IN THE GEOGRAPHIC

TOWNSHIP OF CHARLOTTEVILLE

NORFOLK COUNTY

SCALE: 1 : 150

JEWITT AND DIXON LTD.

ASSOCIATION OF ONTARIO LAND SURVEYORS PLAN SUBMISSION FORM V-15914

SURVEYOR'S CERTIFICATE

DATED: SEPTEMBER 13, 2021

- I CERTIFY THAT:
- 1. THIS SURVEY AND PLAN ARE CORRECT AND IN ACCORDANCE WITH THE SURVEYS ACT, THE SURVEYORS ACT, AND THE LAND TITLES ACT,
- AND THE REGULATIONS MADE UNDER THEM. 2. THE SURVEY WAS COMPLETED ON THE 17TH DAY OF AUGUST, 2021

2.5cm X 2.5cm X 1.2m STANDARD IRON BARS SHOWN -□- SIB 1.6cm X 1.6cm X 0.6m IRON BARS SHOWN -□- IB IRON BARS SHOWN -□- IB Ø 1.6cm ROUND X 0.6m LOT LINES DEED LINES SHOWN ---FENCE LINES SHOWN CENTRE LINES SHOWN ROAD LINES SHOWN — — — — — FOUND IRON BARS SHOWN -- PLANTED IRON BARS SHOWN --

SHOWN (700) SHOWN (WIT) SHOWN (OU) SHOWN (P1) JEWITT AND DIXON LTD. WITNESS MONUMENT ORIGIN UNKNOWN REGISTERED PLAN 133 PLAN 37R-8177

SHOWN (P2) PLAN 3/K-61//
PLAN OF SURVEY BY E. G. SALZER, O.L.S. DATED MARCH 18, 2009 (S-8551) SHOWN (P3) SURVEYOR'S REAL PROPERTY REPORT BY JEWITT & DIXON DATED APRIL 13/00 (00-069) SHOWN (P4)


JEWITT AND DIXON LTD. ONTARIO LAND SURVEYORS

R.R.1, SIMCOE, ONTARIO, N3Y 4J9 (51 PARK ROAD)

PHONE: (519) 426-0842 FAX: (519) 426-1034 E-mail: surveyors@amtelecom.net

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CHECK	_	K.H.
CLIENT		HILTZ
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21-3145-POS

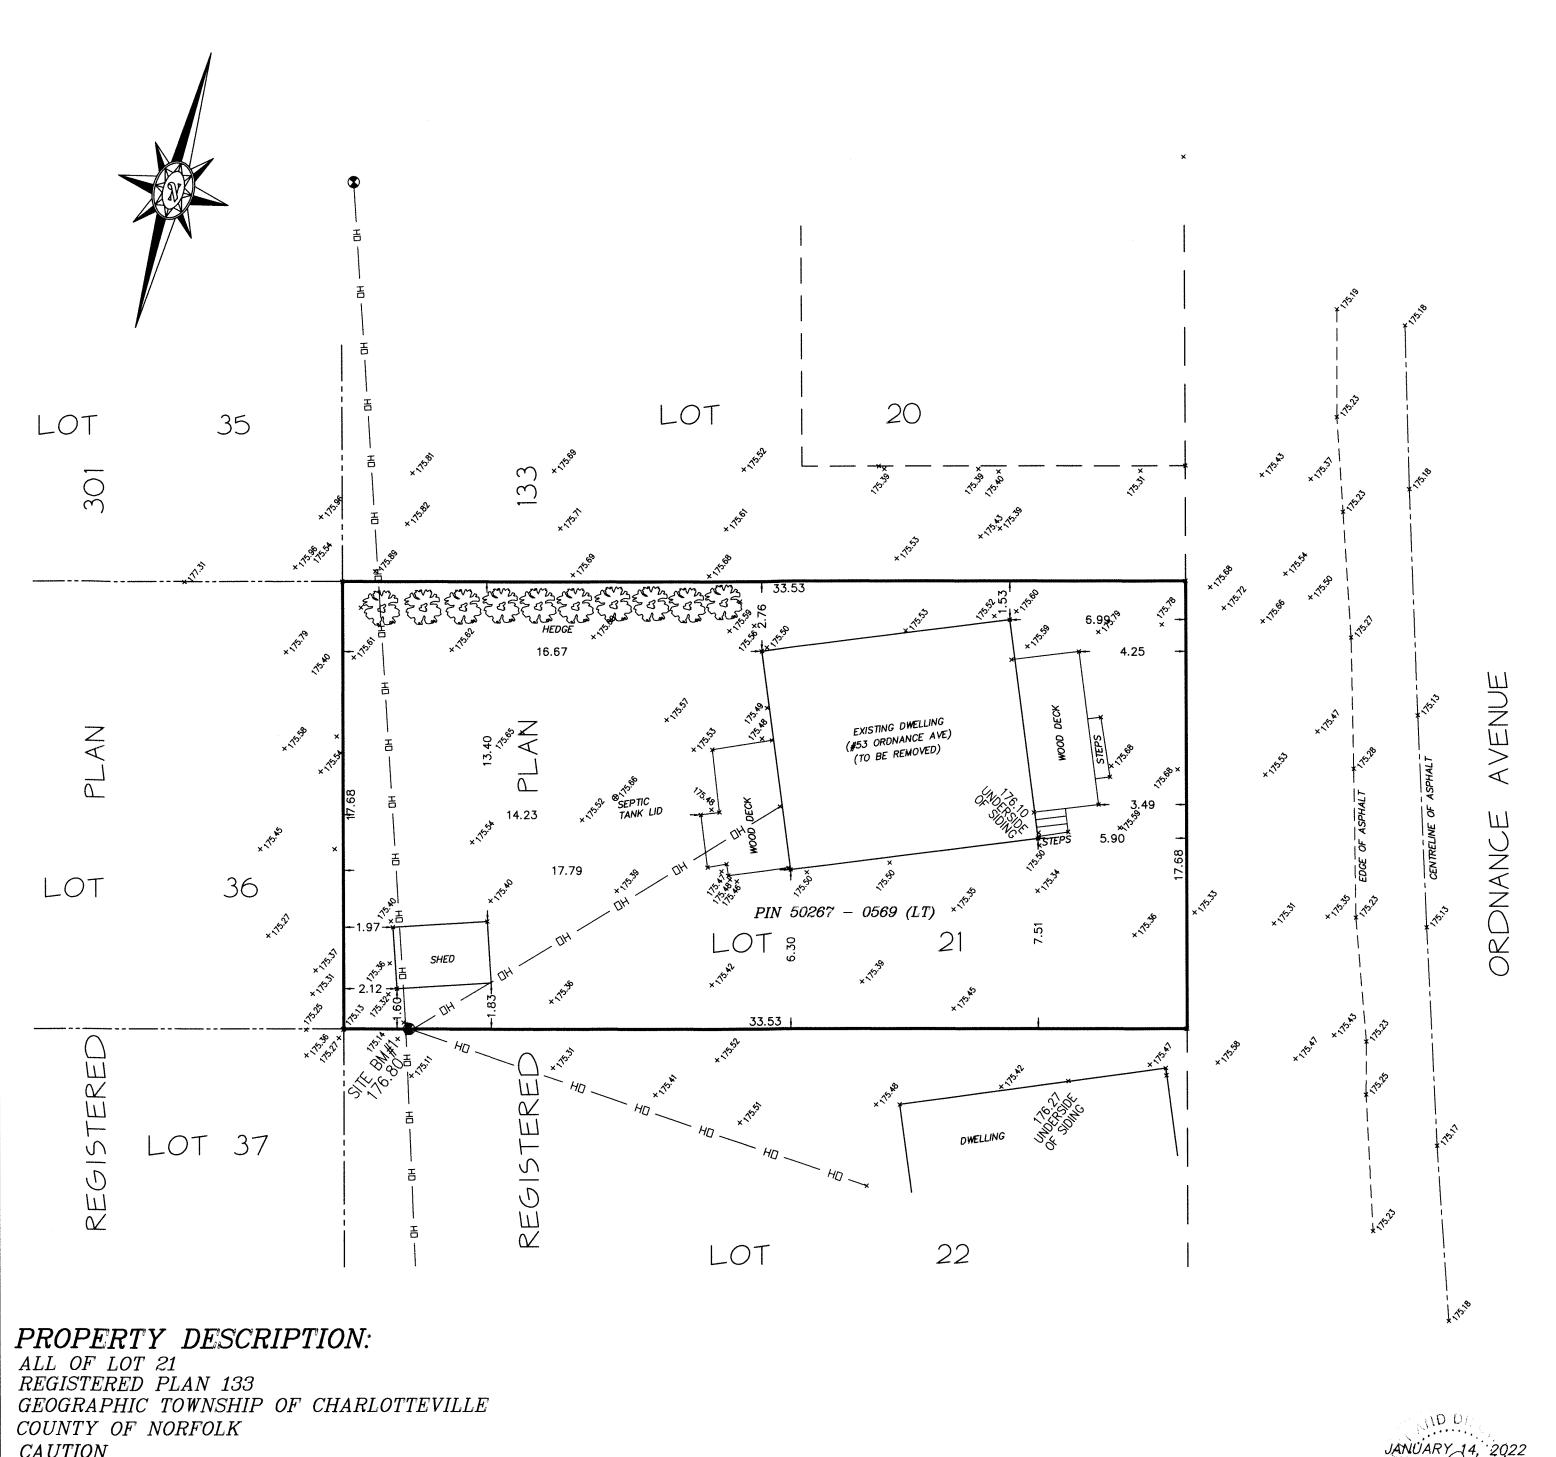

TOPOGRPAHIC SITE PLAN FOR: DARRELL HILTZ **#53 ORDNANCE AVENUE** TURKEY POINT

PIN 50267 - 0569 (LT) SCALE: 1 : 150

JEWITT AND DIXON LTD.

SITE B.M.#1 SPIKE IN FACE OF WOOD HYDRO POLE ELEV = 176.80CGVD28

NOTE: ELEVATIONS ARE REFERRED TO CANADIAN GEODETIC DATUM, CGVD 1928 VERTICAL DATUM

NOTE: MINIMUM PROPOSED TOP OF FOUNDATION MUST TO EQUAL TO OR GREATER THAN 176.80m

> LEGEND BELL BOX SHOWN BM (BENCH MARK CATCH BASIN TOP OF FOUNDATION SHOWN TOF OVERHEAD HYDRO LINE SHOWN O/H SHOWN WV 🛦 WATER VALVE SHOWN HP HYDRO POLE SHOWN GM GAS METER SHOWN MH MANHOLE

JEWITT AND DIXON LTD. ONTARIO LAND SURVEYORS

R.R.1, SIMCOE, ONTARIO, N3Y 4J9 (51 PARK ROAD)

PHONE:	(519)	426-0842	FAX:	(519)	426-103
1	E–mai	l: surveyors	@amtel	ecom.	net

KIM HŮSTED, O.L.S. THIS COPY IS NOT VALID VINLESS EMBOSSED WITH THE SURVEYOR'S SEAL.


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CAUTION

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CONTRACTOR'S NOTES **PLAN NOTES**

- ALL INTERIOR DIMENSIONS ARE TO FACE OF STUDS UNLESS OTHERWISE NOTED.
- ALL EXTERIOR DIMENSIONS ARE TO FACE OF FOUNDATION UNLESS OTHERWISE NOTED.
- INTERIOR BASEMENT DIMENSIONS ARE TO FACE OF FOUNDATION AND LOAD BEARING WALLS ALL EXTERIOR WINDOW AND DOOR OPENINGS ARE ROUGH STUD OPENINGS (R.S.O.).
- INTERIOR DOOR SIZES NOTED ARE DOOR LEAF SIZES. FOR ROUGH STUD OPENING ADD 3" TO WIDTH AND 2" TO
- CONTRACTOR TO VERIFY ALL DIMENSIONS BEFORE STARTING WORK.
- CONTRACTOR TO PROVIDE SOUND ATTENUATION BATTS IN WALLS AROUND THE PERIMETER OF INTERIORS FOR WALL BATHROOMS AND WALLS BETWEEN BEDROOM AND LIVING SPACES AND AS DIRECTED BY HOME
- CONTRACTOR SHALL PROVIDE SOUND ATTENUATION BATTS IN THE CEILING ABOVE THE UTILITY ROOM IN THE BASEMENT.

TYPICAL SLAB ASSEMBLY

TYPICAL BASEMENT FLOOR SLAB

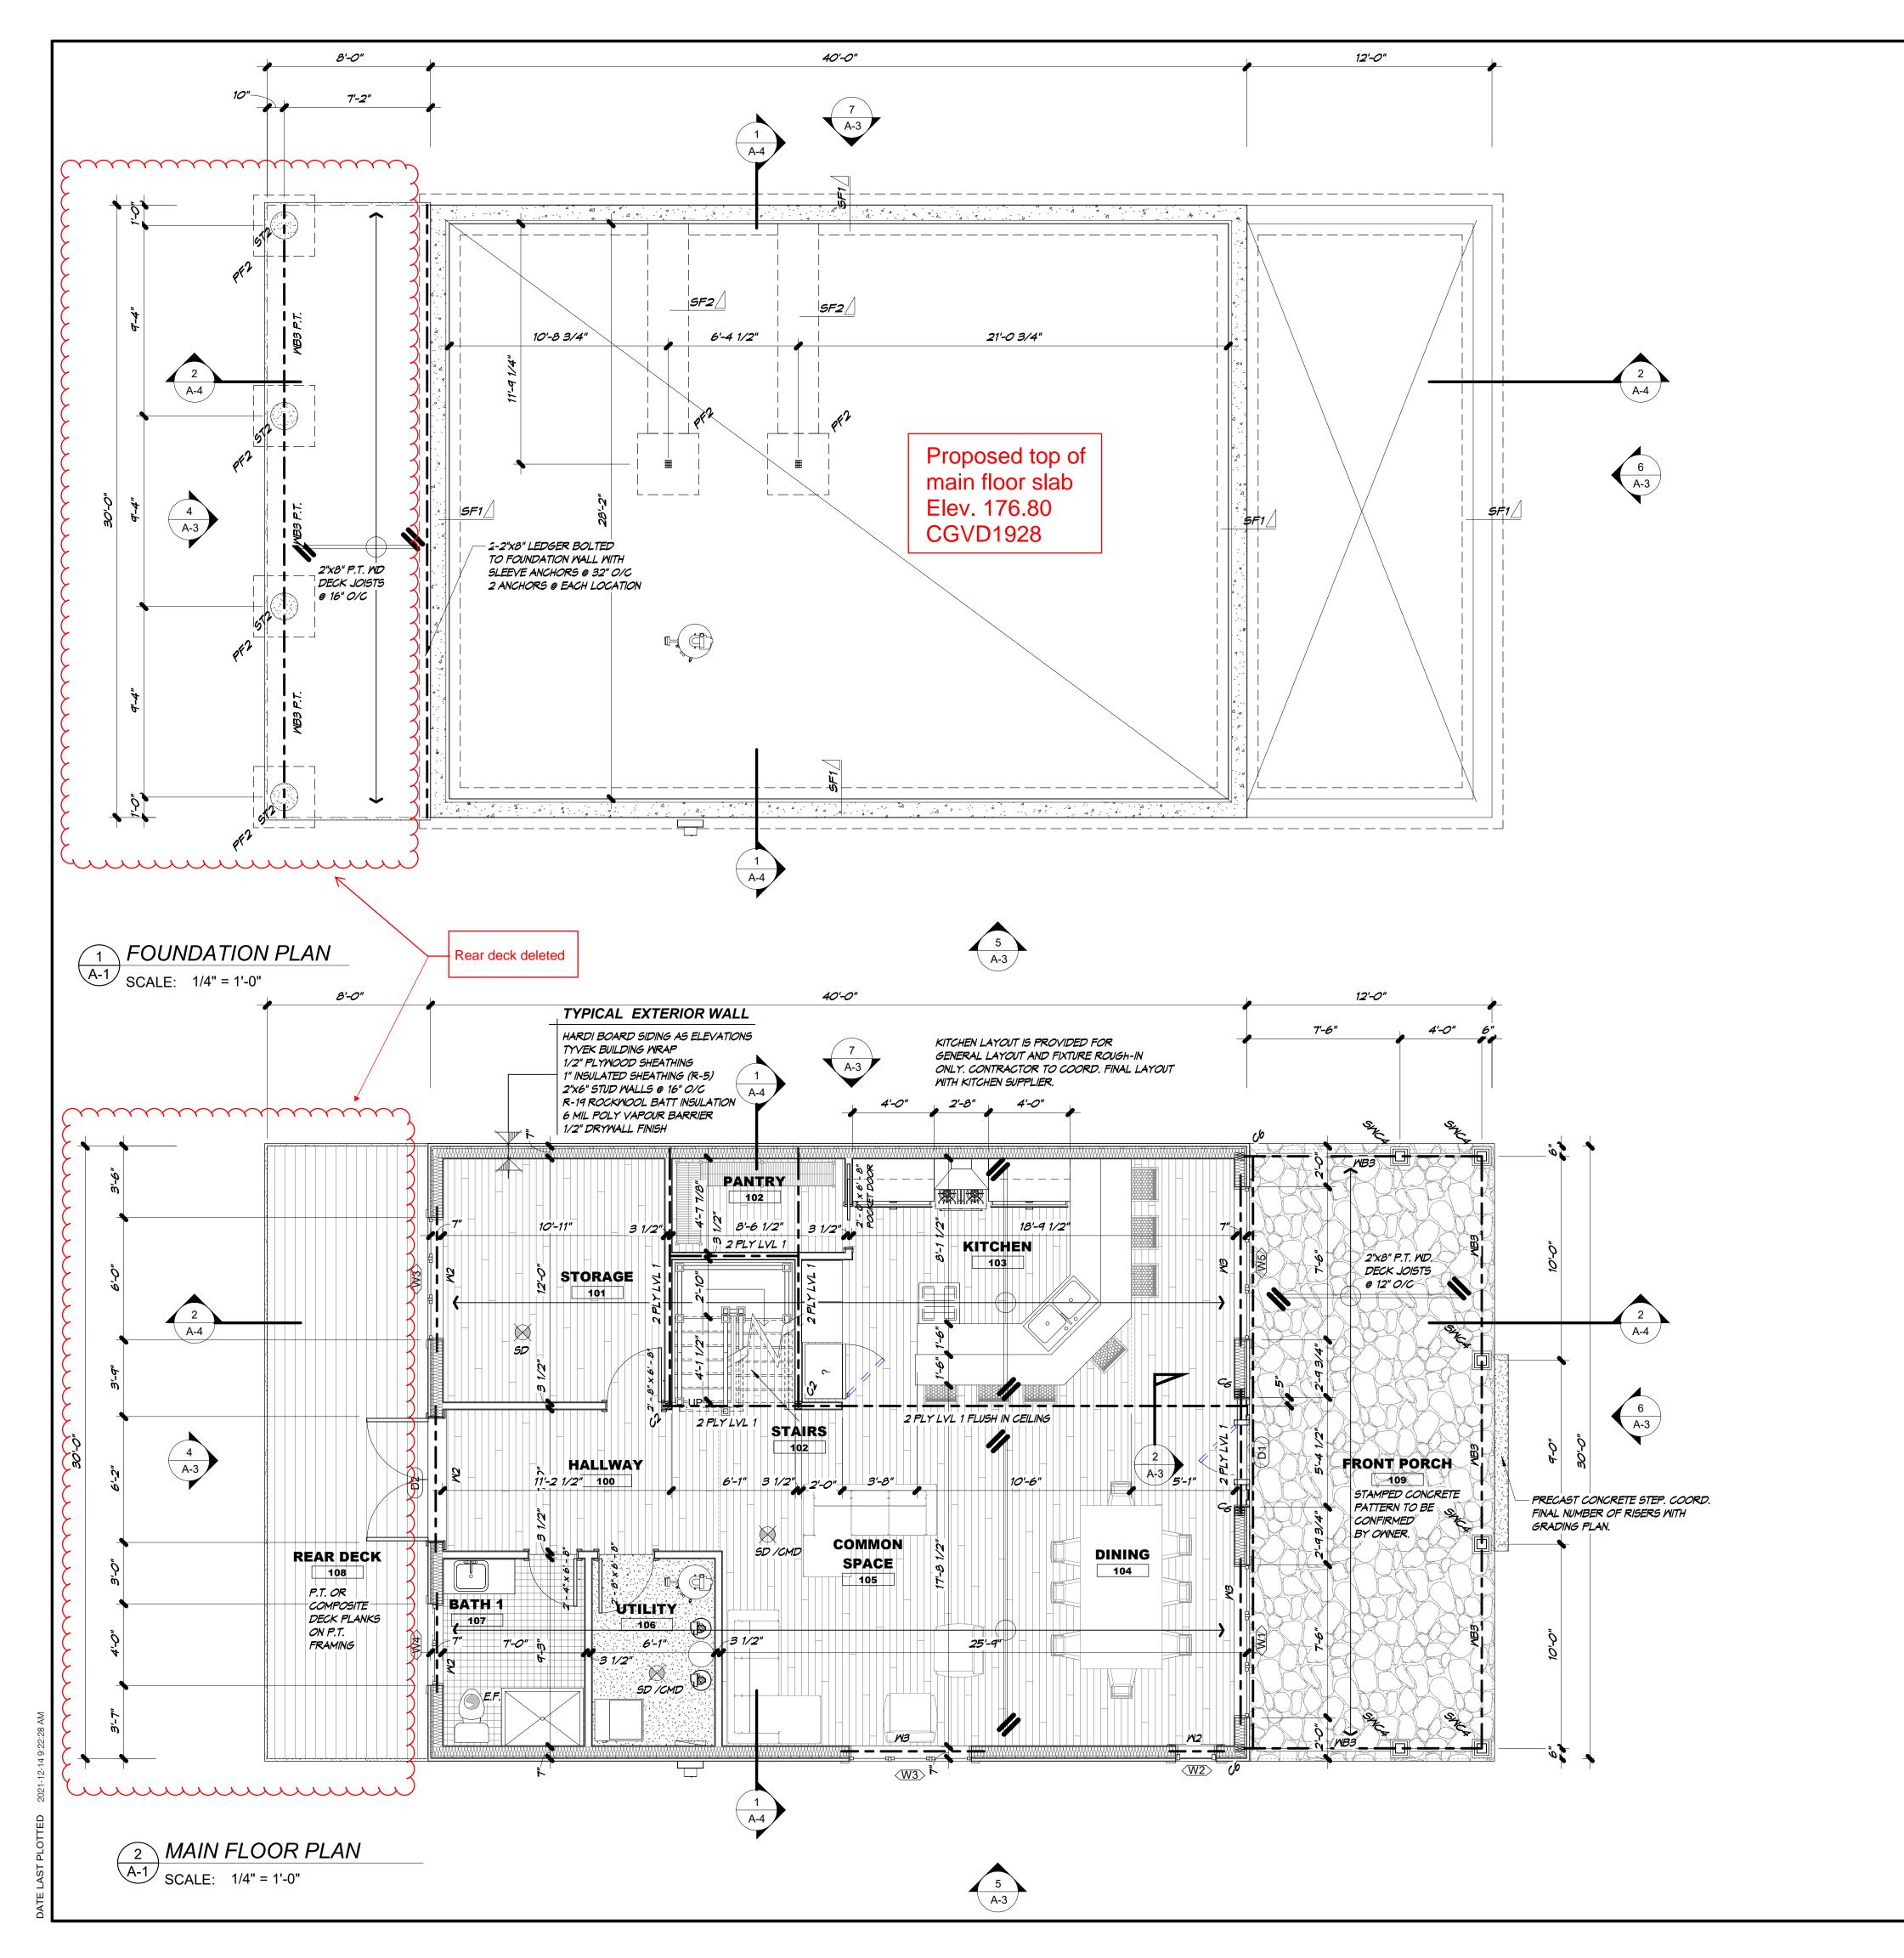4" CONC. SLAB 'N' CLASS (20 MPa) OVER 15 MIL POLY VAPOUR BARRIER OVER 6" CLEAR STONE (3/4") COMPACTED.

TYPICAL GARAGE FLOOR SLAB

6" EXPOSURE CLASS N CONCRETE (25 MPA WITH NO AIR) REINFORCED WITH 6X6X1/4 WWM 6" GRANULAR "A" COMPACTED TO 100% SPMDD

EXTERIOR PORCH SLAB

6" 'C-2' CLASS CONCRETE (32 MPa W/ 5-8% AIR ENTRAINMENT) 10M BAR @ 7 7/8" (200mm) O/C EACH WAY. PROVIDE MIN. 1 1/8" (30mm) COVER TO BOTTOM OF SLAB TO UNDERSIDE OF FIRST LAYER OF BARS. SUPPORT ON EDGES OF FOUNDATION WALL. PROVIDE 3" (75mm) MIN. BEARING. SLAB TO BE SECURED TO FOUNDATION WITH 23 5/8" x 23 5/8" (600mm x600mm)BENT DOWELS SPACED AT 23 5/8" (600mm O/C) MAX.

- BLOCKING IN WALLS
- WHERE INDICATED, BLOCKING IS TO BE INSTALLED BETWEEN OR AGAINST STUDS IN THE WALLS ADJACENT TO THE TOILET, SHOWER AND/OR BATHTUB TO SUPPORT FUTURE INSTALLATION OF GRAB BARS IN

ACCORDANCE WITH O.B.C. 2012 [B] 9.5.2.3.

- BLOCKING LOCATION IN WALLS TO BE IN ACCORDANCE WITH GRAB BAR REQUIREMENTS OF O.B.C. 2012 [B] 3.8.
- POST SUPPORTING BEAMS
- 2.1 POST SIZES INDICATED ARE THE MINIMUM REQUIRED. SIZE OF POSTS CAN NOT BE
- 2.2 POSTS SHALL NOT BE CHANGED WITHOUT REVIEW BY THE DESIGNER PRIOR TO INSTALLATION.
- SMOKE / CARBON MONOXIDE DETECTORS
- LOCATIONS SHOWN IS FOR CONTEXT ONLY.
- CONTRACTOR TO CONFIRM EXACT LOCATIONS. 3.2 AT LEAST ONE SMOKE ALARM & CARBON
- MONOXIDE DETECTOR MUST BE LOCATED ON EVERY FLOOR.
- 3.3 ONE SMOKE ALARM SHALL INSTALLED IN EACH BEDROOM OR ROOM INTENDED FOR SLEEPING.
- 3.4 AT LEAST ONE ADDITIONAL UNIT INSTALLED BETWEEN SLEEPING ROOMS AND THE REMAINDER OF THE STOREY. IF THE SLEEPING ROOMS ARE SERVED BY A HALLWAY THAN THE ALARM SHALL BE INSTALLED IN THE HALLWAY.
- PRE-ENGINEERED WOOD PRODUCTS
- PRODUCTS TO BE SUPPLIED AS SPECIFIED ON DRAWINGS, <u>NO SUBSTITUTIONS</u>.
- STRUCTURAL STEEL
- ALL STRUCTURAL STEEL CONNECTIONS, BEARING, PLATES, ETC., SHALL BE DESIGNED BY THE STEEL FABRICATOR. GENERAL CONTRACTOR SHALL SUPPLY STRUCTURAL STEEL AND CONNECTION DESIGNS SEALED BY P.ENG (PEO).

FOUNDATION NOTES

- LATERALLY UNSUPPORTED FOUNDATION WALLS AS PER [B] 9.15.4.3 (1) SHALL BE REINFORCED (REINFORCING MUST BE DESIGNED BY P.ENG. OR OTHER SUITABLY QUALIFIED PERSON.)
- FOUNDATION WALL OPENING REINFORCING REQUIREMENTS AS PER O.B.C. [B] 9.15.4.3 (3) (A) & (B),
- ALL OPENINGS MUST BE REINFORCED UNDER A DESIGN IN ACCORDANCE WITH PART 4 OF THE O.B.C. WHEN OPENINGS EXCEED THE FOLLOWING CONDITIONS:
- ALL OPENINGS 1.2m OR WIDER IN WIDTH
- FOR WALLS WHERE THE TOTAL WIDTH OF OPENINGS CONSTITUTES MORE THAN 25% OF THE TOTAL WIDTH OF THE WALL.
- PART 4 STRUCTURAL DESIGN MUST BE PERFORMED BY P.ENG. (PEO) OR OTHER PROPERLY QUALIFIED PERSON


SHOP DRAWINGS

PRE-ENGINEERED WOOD PRODUCTS SUCH AS ENGINEERED BEAMS, ROOF TRUSSES, LINTELS, & GIRDERS TO BE DESIGNED & ENGINEERED BY ENGINEERED WOOD PRODUCT MANUFACTURER.

TRUSS MANUFACTURER TO CONFIRM SIZING OF ALL BEAMS, GIRDERS AND LINTELS SUPPORTING ROOF TRUSSES. THIS SIZING SHALL BE CONFIRMED ON TRUSS MANUFACTURER'S SHOP DRAWINGS.

TRUSS SHOP DRAWINGS MUST BE SEALED BY P.ENG (PEO) AND SUBMITTED TO DESIGNER FOR REVIEW PRIOR TO CONSTRUCTION.

ALL PRODUCTS MANUFACTURED BY PROPRIETARY PRODUCT SUPPLIER'S SUCH AS RAILING SYSTEMS MUST BE ACCOMPANIED WITH PRODUCT LITERATURE ILLUSTRATING COMPLIANCE WITH APPLICABLE SB-7 REQUIREMENTS. THIS LITERATURE MUST BE SUBMITTED WITH THE PERMIT DRAWING PACKAGE TO AVOID DELAY IN THE PROCESSING OF THE APPLICATION.

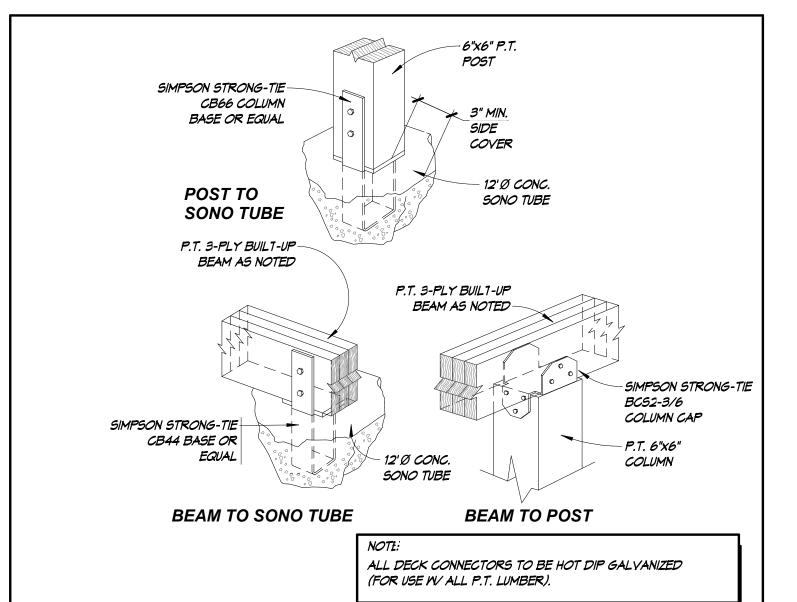

3 TYPICAL PORCH CONNECTIONS A-1 SCALE: 3/4" = 1'-0"

ISSUED FOR 2021.12.15 BUILDING PERMIT APPLICATION ISSUED FOR FINAL 2021.11.29 HOMEOWNER REVIEW ISSUED FOR PLOT 2021.10.24 PLAN REVIEW lo. REVISION DATE

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> ISSUED FOR BUILDING PERMIL

<u>application</u> **DECEMBER 15, 2021**

ONTARIO ASSOCIATION OF ARCHITECTS DEC 15 '21 **DAVID B. BENNETT** LICENCE



David B. Bennett Licensed Technologist OAA

O.B.C. Qualified Design; Small Buildings

22 Walpole Drive Jarvis Ontario N0A 1J0

Telephone : (519) 909-9246 Dave@engageddesign.ca Web Site: www.engageddesign.ca

COTTAGE REPLACEMENT

Hiltz & Schebesch Families 53 ORDNANCE AVE.

TURKEY POINT, ONTARIO NORFOLK COUNTY

Drawing Title

FOUNDATION AND MAIN FLOOR PLANS


Designed By: D.BENNETT Checked By:

Project No.

21-021

Drawing No.

A-

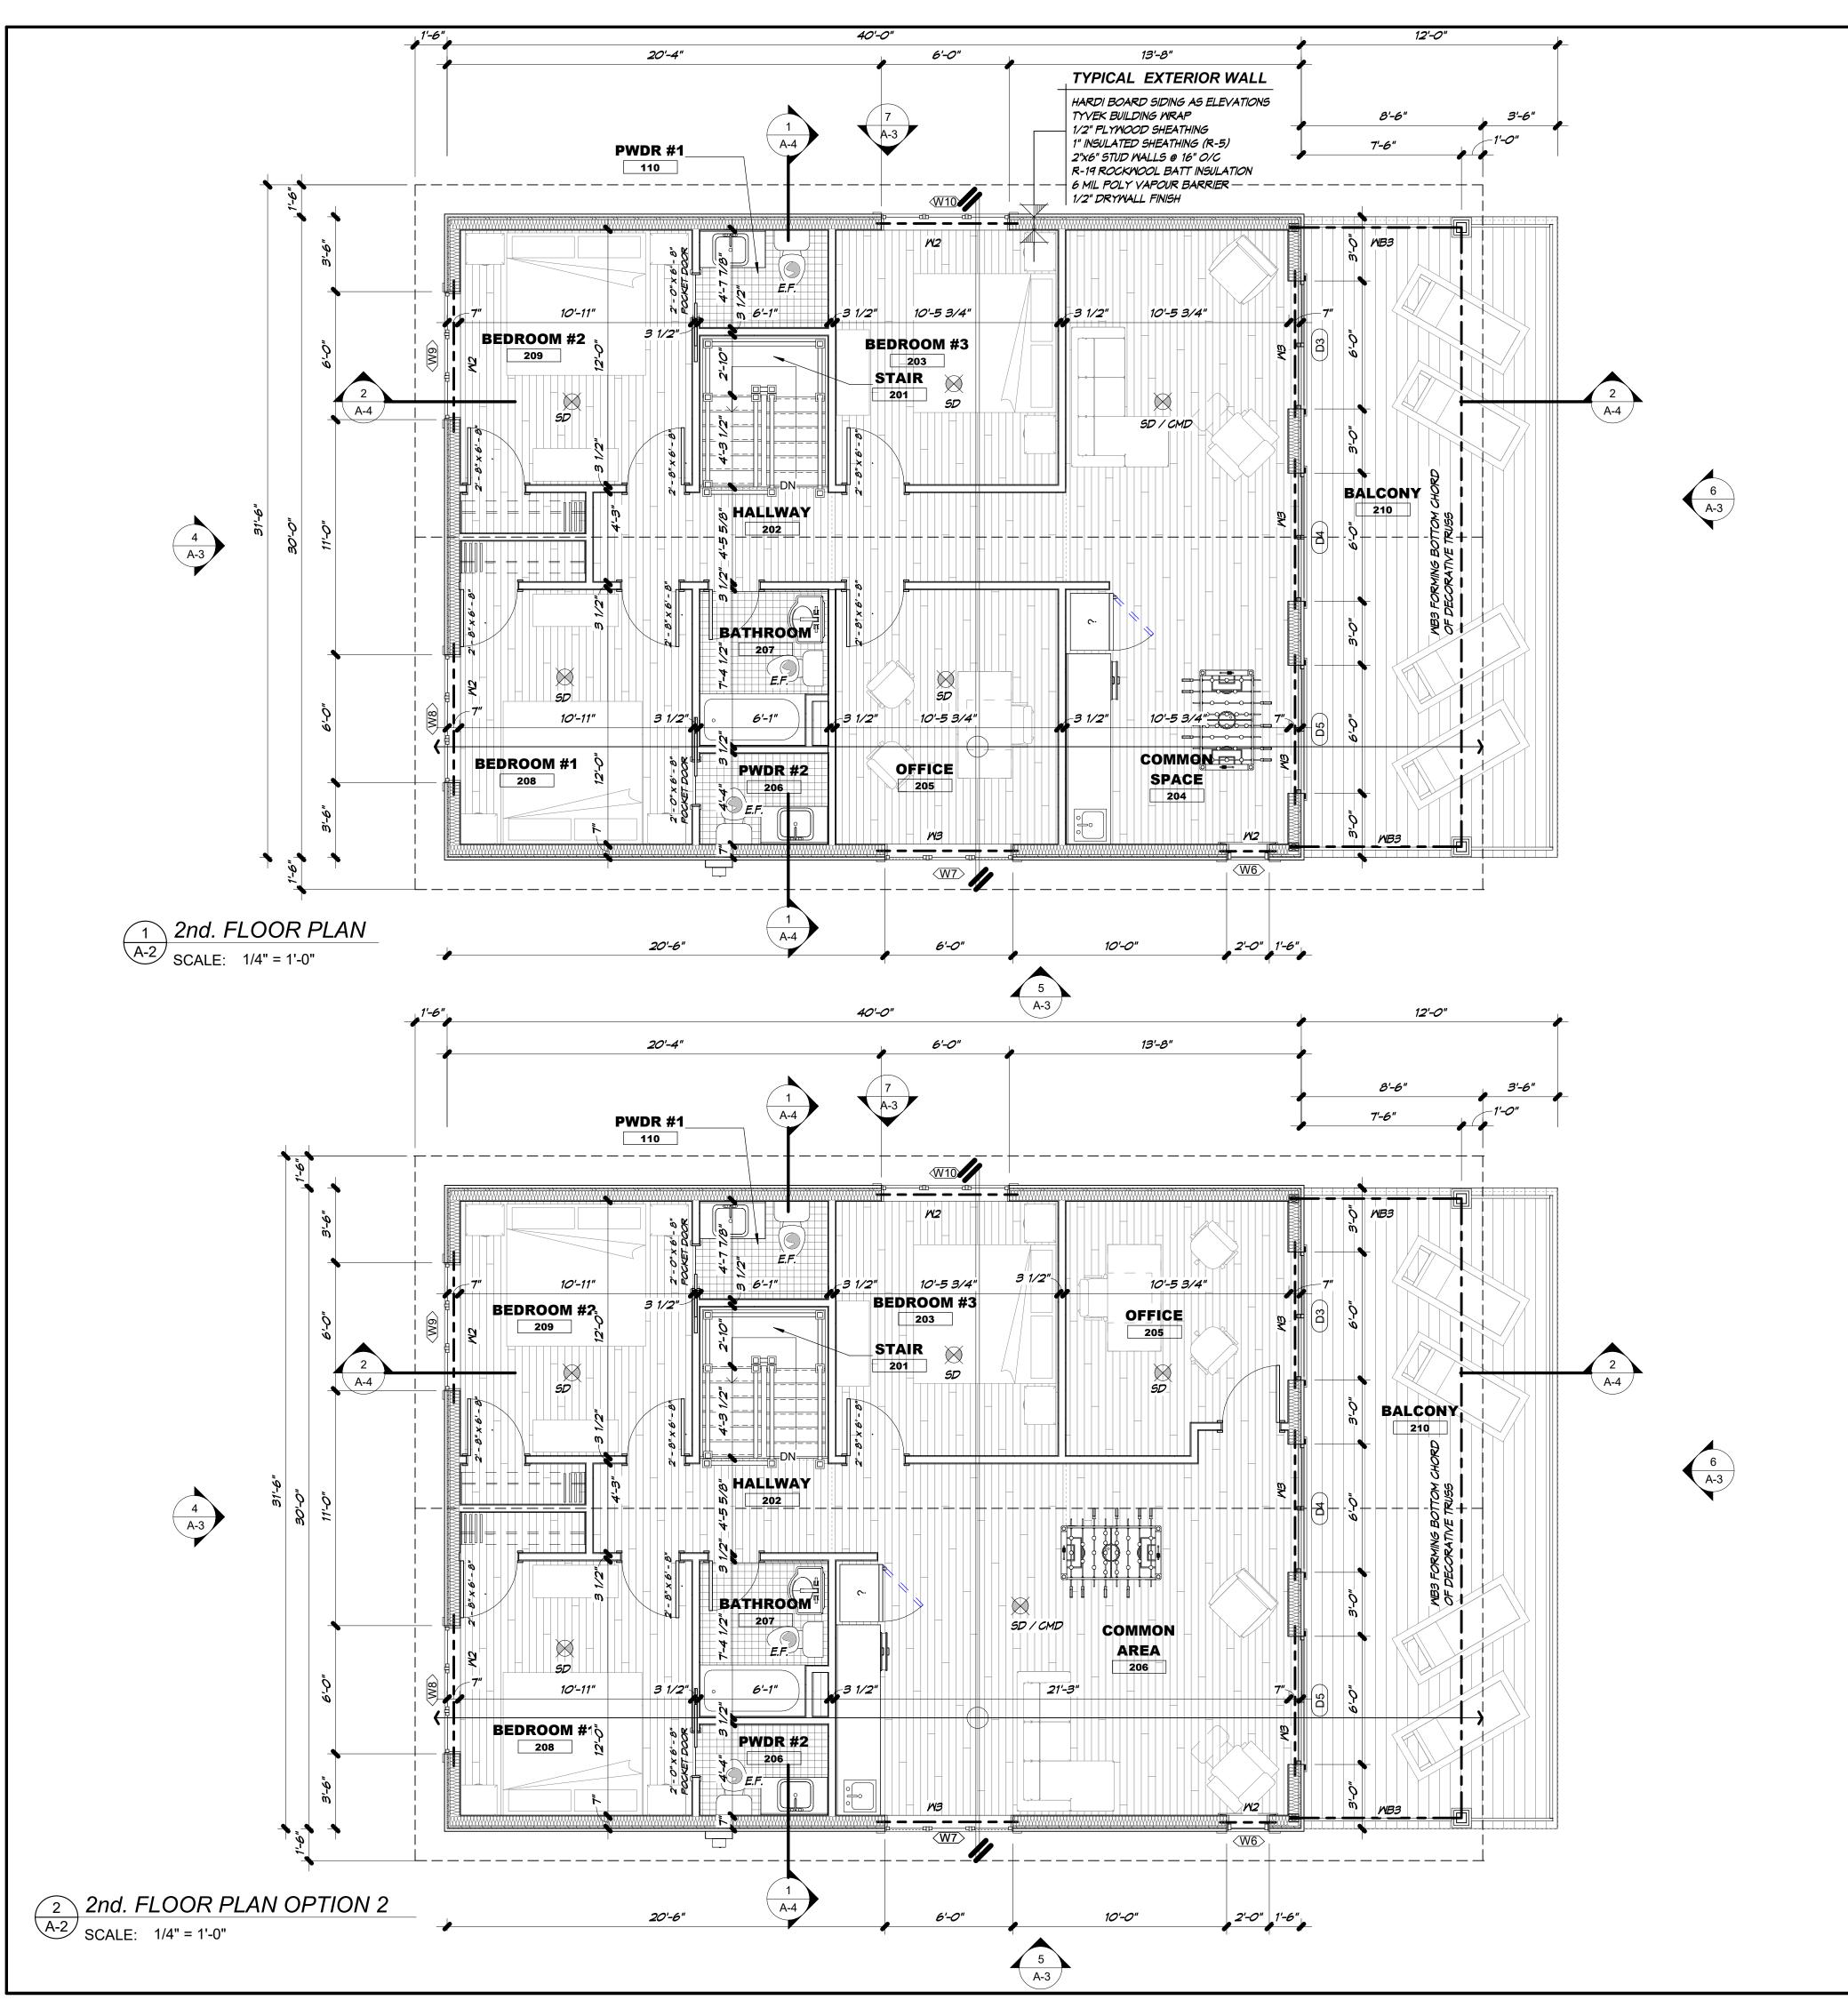

CONTRACTOR'S NOTES

ALL INTERIOR DIMENSIONS ARE TO FACE OF STUDS UNLESS OTHERWISE NOTED.

ALL EXTERIOR DIMENSIONS ARE TO FACE OF FOUNDATION UNLESS OTHERWISE NOTED.

INTERIOR BASEMENT DIMENSIONS ARE TO FACE OF FOUNDATION AND LOAD BEARING WALLS ALL EXTERIOR WINDOW AND DOOR OPENINGS ARE ROUGH STUD OPENINGS (R.S.O.).

INTERIOR DOOR SIZES NOTED ARE DOOR LEAF SIZES. FOR ROUGH STUD OPENING ADD 3" TO WIDTH AND 2" TO

CONTRACTOR TO VERIFY ALL DIMENSIONS BEFORE STARTING WORK.

CONTRACTOR TO PROVIDE SOUND ATTENUATION BATTS IN WALLS AROUND THE PERIMETER OF INTERIORS FOR WALL BATHROOMS AND WALLS BETWEEN BEDROOM AND LIVING SPACES AND AS DIRECTED BY HOME OWNER.

CONTRACTOR SHALL PROVIDE SOUND ATTENUATION BATTS IN THE CEILING ABOVE THE UTILITY ROOM IN THE BASEMENT.

TYPICAL SLAB ASSEMBLY

TYPICAL BASEMENT FLOOR SLAB

4" CONC. SLAB 'N' CLASS (20 MPa) OVER 15 MIL POLY VAPOUR BARRIER OVER 6" CLEAR STONE (3/4") COMPACTED.

TYPICAL GARAGE FLOOR SLAB

6" EXPOSURE CLASS N CONCRETE (25 MPa WITH NO AIR) REINFORCED WITH 6X6X1/4 WWM 6" GRANULAR "A" COMPACTED TO 100% SPMDD

EXTERIOR PORCH SLAB

FOUNDATION NOTES

6" 'C-2' CLASS CONCRETE (32 MPa W/ 5-8% AIR ENTRAINMENT) 10M BAR @ 7 7/8" (200mm) O/C EACH WAY. PROVIDE MIN. 1 1/8" (30mm) COVER TO BOTTOM OF SLAB TO UNDERSIDE OF FIRST LAYER OF BARS. SUPPORT ON EDGES OF FOUNDATION WALL. PROVIDE 3" (75mm) MIN. BEARING. SLAB TO BE SECURED TO FOUNDATION WITH 23 5/8" x 23 5/8" (600mm x600mm)BENT DOWELS SPACED AT 23 5/8" (600mm 0/C) MAX.

FOUNDATION WALL OPENING REINFORCING

ALL OPENINGS MUST BE REINFORCED UNDER

A DESIGN IN ACCORDANCE WITH PART 4 OF

• ALL OPENINGS 1.2m OR WIDER IN WIDTH

• FOR WALLS WHERE THE TOTAL WIDTH OF

THE TOTAL WIDTH OF THE WALL.

PART 4 STRUCTURAL DESIGN MUST BE PERFORMED BY

P.ENG. (PEO) OR OTHER PROPERLY QUALIFIED PERSON.

OPENINGS CONSTITUTES MORE THAN 25% OF

THE O.B.C. WHEN OPENINGS EXCEED THE

REQUIREMENTS AS PER O.B.C.

[B] 9.15.4.3 (3) (A) & (B),

FOLLOWING CONDITIONS:

PLAN NOTES

- BLOCKING IN WALLS
- WHERE INDICATED, BLOCKING IS TO BE INSTALLED BETWEEN OR AGAINST STUDS IN THE WALLS ADJACENT TO THE TOILET, SHOWER AND/OR BATHTUB TO SUPPORT FUTURE INSTALLATION OF GRAB BARS IN ACCORDANCE WITH O.B.C. 2012 [B] 9.5.2.3.
- 1.2 BLOCKING LOCATION IN WALLS TO BE IN ACCORDANCE WITH GRAB BAR REQUIREMENTS OF O.B.C. 2012 [B] 3.8.
- 2. POST SUPPORTING BEAMS
- 2.1 POST SIZES INDICATED ARE THE MINIMUM REQUIRED. <u>SIZE OF POSTS CAN NOT BE</u> REDUCED.
- 2.2 POSTS SHALL NOT BE CHANGED WITHOUT REVIEW BY THE DESIGNER PRIOR TO INSTALLATION.
- SMOKE / CARBON MONOXIDE DETECTORS
- LOCATIONS SHOWN IS FOR CONTEXT ONLY. CONTRACTOR TO CONFIRM EXACT LOCATIONS.
- 3.2 AT LEAST ONE SMOKE ALARM & CARBON MONOXIDE DETECTOR MUST BE LOCATED ON EVERY FLOOR.
- 3.3 ONE SMOKE ALARM SHALL INSTALLED IN EACH BEDROOM OR ROOM INTENDED FOR SLEEPING.
- 3.4 AT LEAST ONE ADDITIONAL UNIT INSTALLED BETWEEN SLEEPING ROOMS AND THE REMAINDER OF THE STOREY. IF THE SLEEPING ROOMS ARE SERVED BY A HALLWAY THAN THE ALARM SHALL BE INSTALLED IN THE
- PRE-ENGINEERED WOOD PRODUCTS
- PRODUCTS TO BE SUPPLIED AS SPECIFIED ON DRAWINGS, <u>NO SUBSTITUTIONS</u>.
- STRUCTURAL STEEL
- 5.1 ALL STRUCTURAL STEEL CONNECTIONS, BEARING, PLATES, ETC., SHALL BE DESIGNED BY THE STEEL FABRICATOR. GENERAL CONTRACTOR SHALL SUPPLY STRUCTURAL STEEL AND CONNECTION DESIGNS SEALED BY

SHOP DRAWINGS

LATERALLY UNSUPPORTED FOUNDATION WALLS AS PER [B] 9.15.4.3 (1) SHALL BE REINFORCED . (REINFORCING MUST BE DESIGNED BY P.ENG. OR OTHER SUITABLY QUALIFIED PERSON.)

> TRUSS SHOP DRAWINGS MUST BE SEALED BY P.ENG (PEO) AND SUBMITTED TO DESIGNER FOR REVIEW PRIOR TO CONSTRUCTION.

ALL PRODUCTS MANUFACTURED BY PROPRIETARY PRODUCT SUPPLIER'S SUCH AS RAILING SYSTEMS MUST BE ACCOMPANIED WITH PRODUCT LITERATURE ILLUSTRATING COMPLIANCE WITH APPLICABLE SB-7 REQUIREMENTS. THIS LITERATURE MUST BE SUBMITTED WITH THE PERMIT DRAWING PACKAGE TO AVOID DELAY

PRE-ENGINEERED WOOD PRODUCTS SUCH AS ENGINEERED BEAMS, ROOF TRUSSES, LINTELS, & GIRDERS TO BE DESIGNED & ENGINEERED BY ENGINEERED WOOD PRODUCT MANUFACTURER.

TRUSS MANUFACTURER TO CONFIRM SIZING OF ALL BEAMS, GIRDERS AND LINTELS SUPPORTING ROOF TRUSSES. THIS SIZING SHALL BE CONFIRMED ON TRUSS MANUFACTURER'S SHOP DRAWINGS.

IN THE PROCESSING OF THE APPLICATION.

1			I	EXTE	RIOR DO	OOR SCHE	EDULE
Door Indentifi cation				door si.	ize		
Door Number	ORIENTATIO N	To Room: Name	Width	Height	Thickness	Door Area	Remarks
Main Flo	or						
D1	EAST	FRONT PORCH	2' - 8"	7'-0"	0' - 2"	18.67 SF	INSULATED STEEL DOOR WITH 2 SIDELIGHTS
D2	WEST	REAR DECK	6'-0"	6'-8"	0' - 2"	40.00 SF	FRENCH DOORS
Main Flo						58.67 SF	
D3	EAST	BALCONY	6'-0"	6'-8"	0' - 2"	40.00 SF	VINYL SLIDING DOOR
D4	EAST	BALCONY	6'-0"	6'-8"	0' - 2"		VINYL SLIDING DOOR
D5	EAST	BALCONY	6'-0"	6'-8"	0' - 2"	40.00 SF	VINYL SLIDING DOOR
2nd. FLC	DOR	.1				120.00 SF	
Grand to	otal					178.67 SF	,

Mark	ORIENTATION	To Room: Name	Width	Height	WINDOW AREA	WINDOW TYPE	COMMENT
	1 - 1 - 1 - 1 - 1 - 1 - 1 - 1 - 1 - 1 -				7 2 27 2		
Main Flo	oor						
W1	EAST	FRONT PORCH	7' - 6"	5' - 6"	41.25 SF	CASEMENT	
M2	SOUTH	DINING	2'-0"	3'-0"	6.00 SF	CASEMENT	
W3	WEST	REAR DECK	6'-0"	3'-0"	18.00 SF	CASEMENT	
W3	SOUTH	COMMON SPACE	6'-0"	3'-0"	18.00 SF	CASEMENT	
N4	WEST	REAR DECK	4' - 0"	2'-8"	10.67 SF	CASEMENT	
W4 W5	WEST EAST	REAR DECK FRONT PORCH	4' - 0" 7' - 6"	2' - 8" 5' - 6"	10.67 SF 41.25 SF 135.17 SF	CASEMENT CASEMENT	
W5 2nd. FL	EAST OOR	FRONT PORCH	7' - 6"	5' - 6"	41.25 SF 135.17 SF	CASEMENT	
W5 2nd. FL W6	EAST OOR SOUTH		7' - 6"	5' - 6" 3' - 0"	41.25 SF 135.17 SF 6.00 SF		
W5 2nd. FL	EAST OOR	FRONT PORCH	7' - 6"	5' - 6"	41.25 SF 135.17 SF	CASEMENT	
W5 2nd. FL W6	EAST OOR SOUTH	FRONT PORCH COMMON SPACE	7' - 6"	5' - 6" 3' - 0"	41.25 SF 135.17 SF 6.00 SF	CASEMENT	
W5 2nd. FL W6 W7	EAST OOR SOUTH SOUTH	FRONT PORCH COMMON SPACE OFFICE	7' - 6" 2' - 0" 6' - 0"	3' - 0" 3' - 0"	41.25 SF 135.17 SF 6.00 SF 18.00 SF	CASEMENT CASEMENT CASEMENT	

No.	REVISION	DATE
	PLAN REVIEW	
1	ISSUED FOR PLOT	2021.10.24
2	ISSUED FOR FINAL HOMEOWNER REVIEW	2021.11.29
3	ISSUED FOR BUILDING PERMIT APPLICATION	2021.12.15

THIS DRAWING IS THE PROPERTY OF "ENGAGED CUSTOM HOME DESIGN" (ECHD) AND AS SUCH IS NOT TO BE REPRÓDUCED IN WHOLE OR IN PART WITHOUT THE WRITTEN PERMISSION OF

THESE DRAWINGS MUST BE CHECKED BY THE CONTRACTOR.

ANY ERRORS OR OMISSIONS MUST BE REPORTED IN WRITING TO "ECHD" PRIOR TO COMMENCEMENT OF CONSTRUCTION.

THESE DRAWINGS MUST NEVER BE SCALED.

ALL MISSING OR UNCLEAR INFORMATION MUST BE REPORTED TO THE DESIGNER IMMEDIATELY FOR FURTHER INSTRUCTION.

All construction shall be carried out in accordance with these drawings.

Any deviations, alterations or changes from the design intent shall be reported by the contractor to the designer prior to implementation of the change. The requested change shall then be reviewed by the designer who will in turn issue additional documentation supporting the change to the building department and owner for approval. Only after the contractor has received approval from the building department regarding said change may construction of the affected area continue. Changes involving adjustments in construction cost must be approved by the owner prior to implementation.

ISSUED FOR BUILDING PERMIU

APPLICATION DECEMBER 15, 2021

ASSOCIATION OF ARCHITECTS DEC 15 '21 DAVID B. BENNETT LICENCE



David B. Bennett Licensed Technologist OAA

O.B.C. Qualified Design ; Small Buildings

22 Walpole Drive Jarvis Ontario N0A 1J0

Telephone : (519) 909-9246 Email: Dave@engageddesign.ca Web Site: www.engageddesign.ca

COTTAGE REPLACEMENT

Hiltz & Schebesch Families

53 ORDNANCE AVE. TURKEY POINT, ONTARIO NORFOLK COUNTY

Drawing Title


2nd. FLOOR PLAN AND OPTIONAL LAYOUT


Designed By: Checked By:

Project No.

Drawing No.

21-021

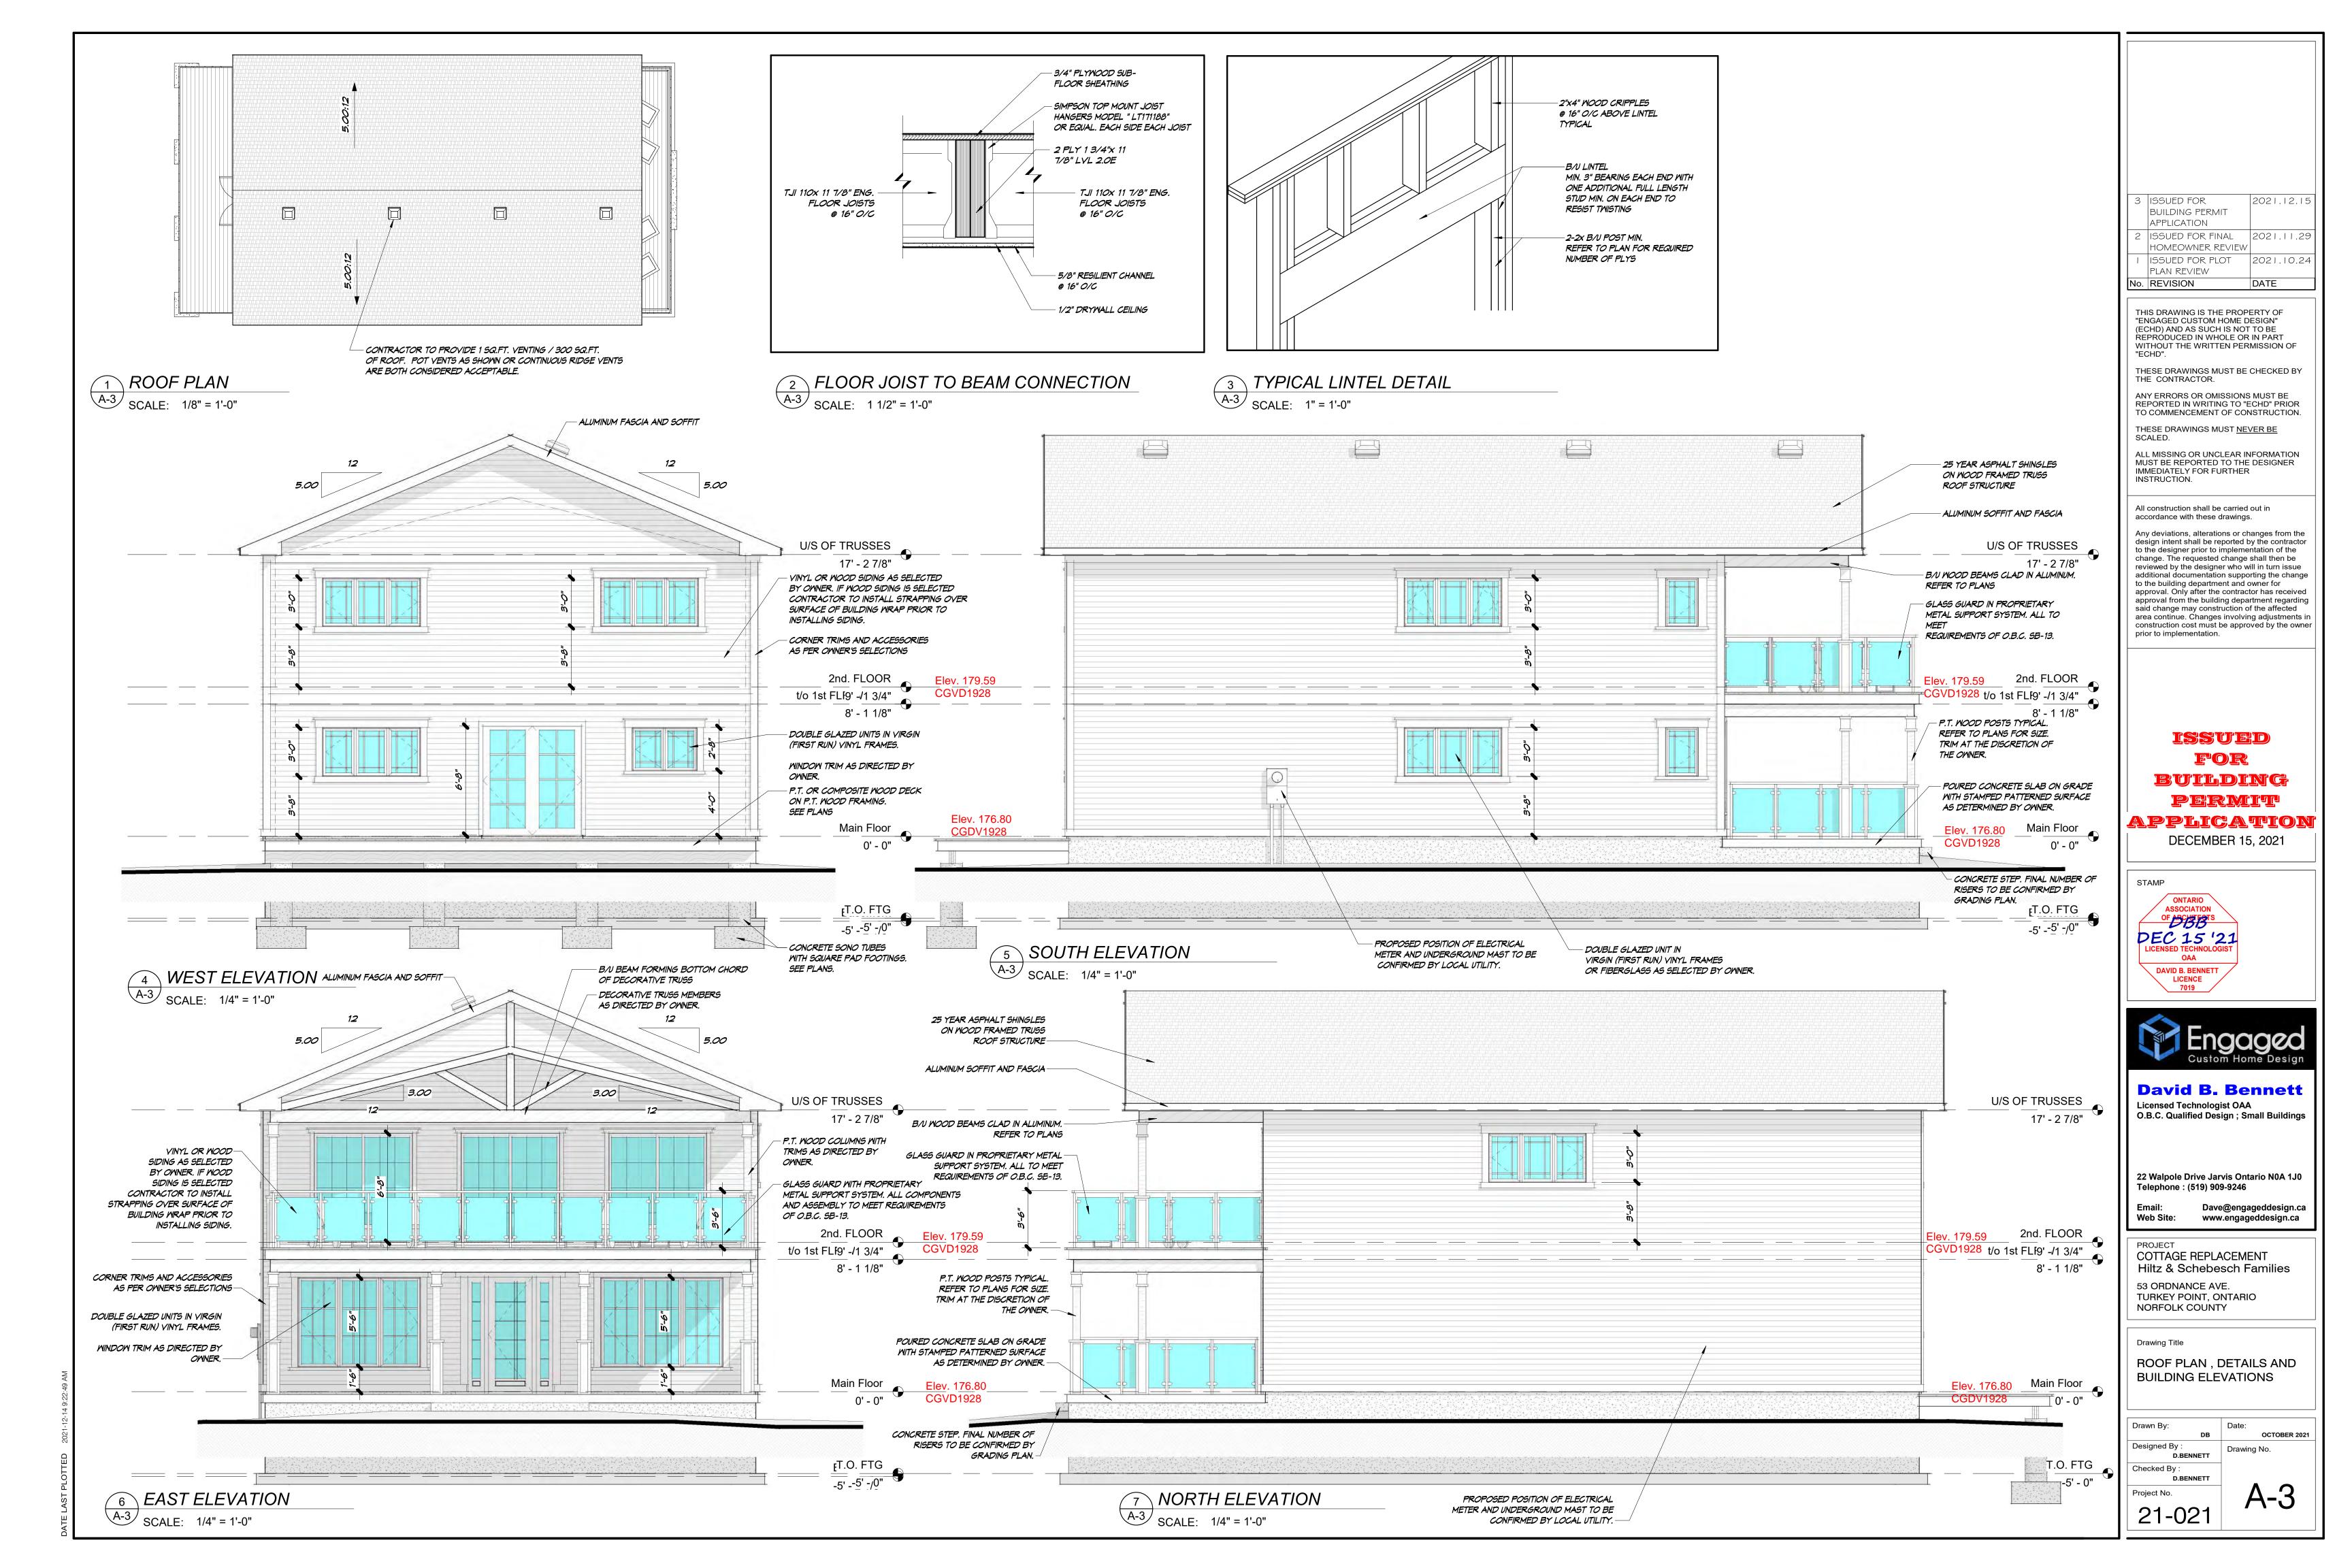

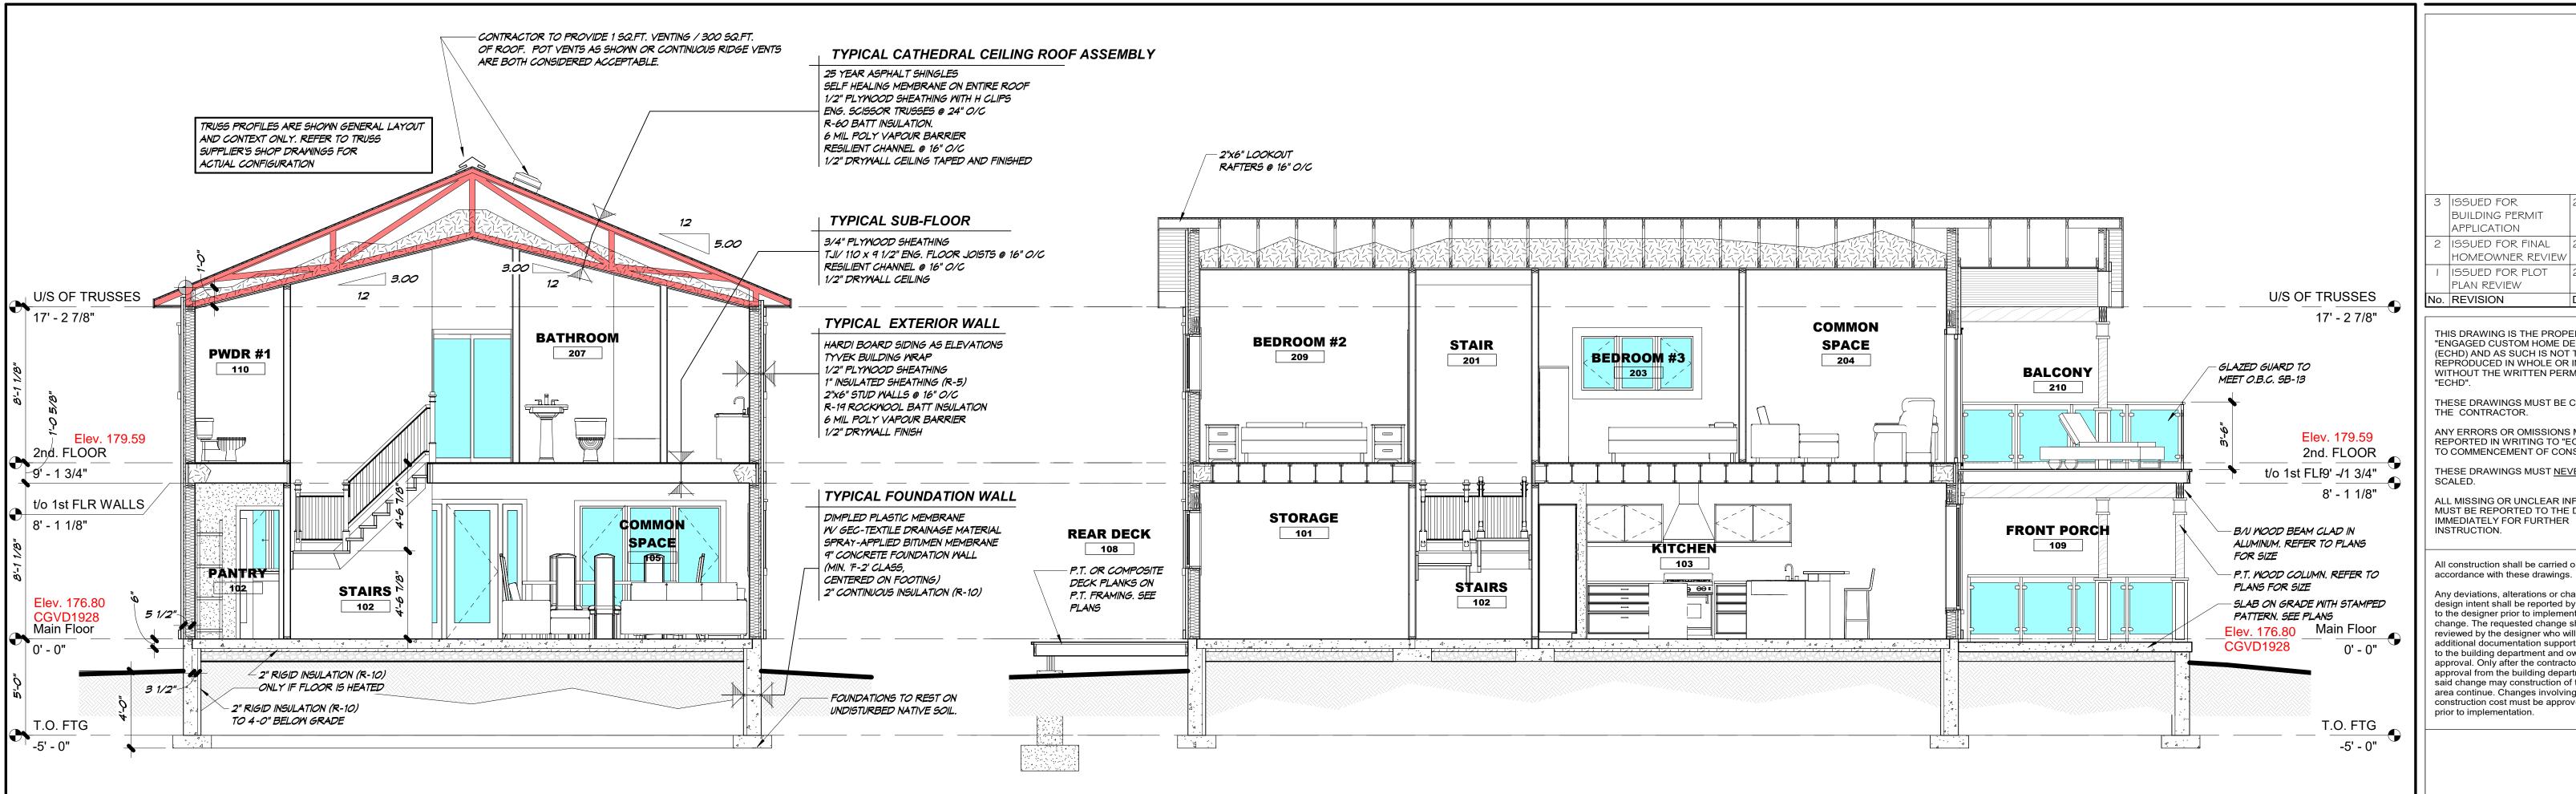

CROSS SECTION

LONGITUDINAL SECTION

3 ISSUED FOR 2021.12.15 BUILDING PERMIT APPLICATION 2 | ISSUED FOR FINAL | 2021.11.29 HOMEOWNER REVIEW ISSUED FOR PLOT 2021.10.24 PLAN REVIEW o. REVISION DATE

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> ISSUED FOR BUILDING PERMUU

APPLICATION

DECEMBER 15, 2021

ONTARIO ASSOCIATION OF ARCHITECTS DEC 15 '21 DAVID B. BENNETT LICENCE 7019



David B. Bennett Licensed Technologist OAA
O.B.C. Qualified Design ; Small Buildings

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Web Site: www.engageddesign.ca

COTTAGE REPLACEMENT

Hiltz & Schebesch Families

53 ORDNANCE AVE. TURKEY POINT, ONTARIO NORFOLK COUNTY

Drawing Title

BUILDING SECTIONS AND DETAILS

Designed By: D .BENNETT Checked By:

Project No.

Drawing No.

21-021

MAP A ZNPL2022198


CONTEXT MAP

Geographic Township of CHARLOTTEVILLE




Legend



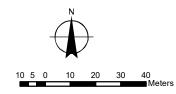

OFFICIAL PLAN MAP

Geographic Township of CHARLOTTEVILLE

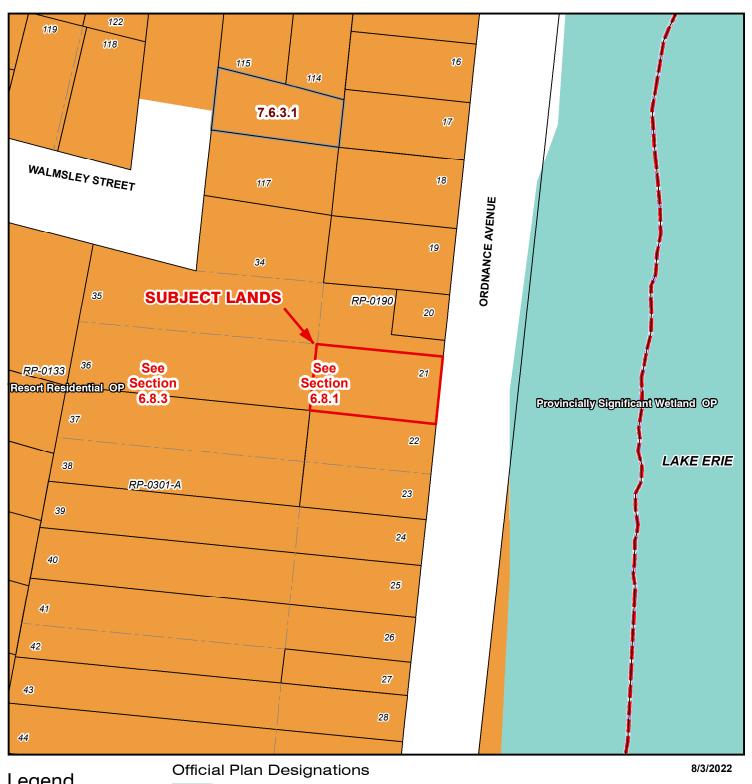



MAP C

PROPOSED ZONING BY-LAW AMENDMENT MAP

Geographic Township of CHARLOTTEVILLE





Subject Lands

Adjacent Lands

Wetland


LPRCA Generic RegLines

(H) - Holding

HL - Hazard Land Zone

PSW - Provincially Significant Wetland Zone

RR - Resort Residential Zone

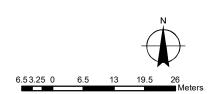

MAP D ZNPL2022198

CONCEPTUAL PLAN

Geographic Township of CHARLOTTEVILLE

