



**Norfolk County**

Robinson Administration Building  
185 Robinson Street, Suite 200  
Simcoe, ON N3Y 5L6

26<sup>th</sup> August, 2022

**Attention: Planning Department**

Dear Madam or Sir:

**RE:** Combined Official Plan/Zoning By-Law Amendment  
Property: 13 Lakeside Lane, Port Dover (the "Property")  
Roll No.: 3310334010061000000  
Owners : Sidway, Irene and Jeff

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We are the solicitors and agents for the owners of the Property, Irene and Jeff Sidway.

**Background**

Irene and Jeff Sidway have owned 13 Lakeside Lane, Port Dover since May of 2012.

In the 10 years of their ownership of their cherished family cottage, the Sidways and their guests have enjoyed the stunning views of Lake Erie and the warm community of Port Dover.

Most importantly, they have created 10 years' worth of priceless family memories.

In order to continue enjoying their property long into the future, the Sidways wish to replace the existing cottage structure with a new single-family dwelling on the existing site.

**Current Official Plan and Zoning**

The subject lands are designated Hazard Land in Norfolk County's Official Plan and zoned Hazard Land in Norfolk County's Zoning By-Law.

**Purpose of Application**

The Hazard Land zone does not permit the construction of a new single-family dwelling.

The herein application seeks to redesignate the northerly portion of the subject lands from the Hazard Land designation to the Urban Residential designation and rezone same from Hazard Land to Residential (R1-B).

This application also seeks reasonable relief from provisions of section 5.1.2 of the Zoning By-Law to permit the applicants' proposed design for the new single-family dwelling.

### **Provincial Policy Statement 2020**

Ontario's Provincial Policy Statement generally directs development to occur outside of lands identified as "hazardous lands", including those adjacent to the Great Lakes-St. Lawrence River System.

While adjacent to the shoreline of Lake Erie, the applicants respectfully submit that the part of the subject lands that are the subject of this application are not in fact hazardous as evidenced by the safe use and existence of the existing single-family dwelling on the subject lands for decades.

The applicants wish to emphasize that they do not seek a redesignation and rezoning of the whole of the Property; their application only affects the northerly portion of the Property.

The application supports Provincial Policy by encouraging urban intensification. Rather than construct a new dwelling on vacant land elsewhere, the Sidways wish to make the most of their existing property.

### **Conclusion**

The application is reasonable in the circumstances and balances the Provincial Policy objectives of directing development outside of hazardous lands with the need for urban intensification.

Irene and Jeff wish for what all cottage owners do – to continue to enjoy their property, and the memories made there, for years to come. In order to do so, they ask that their application be approved.

### **Enclosures**

Please find enclosed:

1. Bank draft for \$4,146.00 for payment of the required application fee (Combined OPA/ZBA fee of \$4,592.00 less the paid pre-consultation fee of \$446.00);
2. Completed Combined Official Plan and Zoning By-Law Amendment Application;

3. Proposed dwelling design plans.

Please contact the undersigned if you require any further information.

Yours truly,

**BRIMAGE LAW GROUP**

Per:

A handwritten signature in blue ink, appearing to read 'Nathan Kolomaya', with a stylized flourish at the end.

Nathan Kolomaya

NK

**For Office Use Only:**

File Number	_____	Public Notice Sign	_____
Related File Number	_____	Application Fee	_____
Pre-consultation Meeting	_____	Conservation Authority Fee	_____
Application Submitted	_____	Well & Septic Info Provided	_____
Complete Application	_____	Planner	_____

**Check the type of planning application(s) you are submitting.**

- ☒ Official Plan Amendment
- ☒ Zoning By-Law Amendment
- ☐ Temporary Use By-law
- ☐ Draft Plan of Subdivision/Vacant Land Condominium
- ☐ Condominium Exemption
- ☐ Site Plan Application
- ☐ Extension of a Temporary Use By-law
- ☐ Part Lot Control
- ☐ Cash-in-Lieu of Parking
- ☐ Renewable Energy Project or Radio Communication Tower

Please summarize the desired end result of this application (for example: a special zoning provision on the subject lands to include additional use(s), changing the zone and/or official plan designation of the subject lands, creating a certain number of lots, or similar)

The desired end result of this application is the redesignation of the northerly part of the subject lands from the Hazard Land designation to the Urban Land designation and the rezoning of same from Hazard Land to Residential (R1-B) in order to permit the construction of a new single-family dwelling in approximately the same location as the existing dwelling.

The proposed zoning amendment also seeks relief of 0.7m from the 1.2m sideyard setback requirement of s. 5.1.2 of the Zoning By-Law to facilitate placement of air conditioning and emergency generator units.

**Property Assessment Roll Number:** 3310334010061000000



### A. Applicant Information

**Name of Owner** SIDWAY, Jeff and Irene

It is the responsibility of the owner or applicant to notify the planner of any changes in ownership within 30 days of such a change.

**Address** 47 Evergreen Hill Road

**Town and Postal Code** Simcoe, Ontario N3Y 1B7

**Phone Number** \_\_\_\_\_

**Cell Number** 519-427-8330

**Email** \_\_\_\_\_

**Name of Applicant** Same as owner

**Address** \_\_\_\_\_

**Town and Postal Code** \_\_\_\_\_

**Phone Number** \_\_\_\_\_

**Cell Number** \_\_\_\_\_

**Email** \_\_\_\_\_

**Name of Agent** Brimage Law Group - Nathan Kolomaya

**Address** 21 Norfolk Street North

**Town and Postal Code** Simcoe, Ontario N3Y 4L1

**Phone Number** 519-426-5840

**Cell Number** \_\_\_\_\_

**Email** nkolomaya@brimage.com

Please specify to whom all communications should be sent. Unless otherwise directed, all correspondence and notices in respect of this application will be forwarded to both owner and agent noted above.

☒ Owner

☒ Agent

☐ Applicant

Names and addresses of any holder of any mortgagees, charges or other encumbrances on the subject lands:

Royal Bank of Canada - 10 York Mills Road, 3rd Floor Toronto, ON M2P 0A2

**B. Location, Legal Description and Property Information**

1. Legal Description (include Geographic Township, Concession Number, Lot Number, Block Number and Urban Area or Hamlet):

LT 8 PL 121; PT LT 9 CON 1 WOODHOUSE AS IN NR411875 T/W NR411875; NORFOLK COUNTY  
(PIN: 50247-0076 (LT))

Municipal Civic Address: 13 Lakeside Lane, Port Dover

Present Official Plan Designation(s): HL

Present Zoning: HL

2. Is there a special provision or site specific zone on the subject lands?

☐ Yes ☒ No If yes, please specify corresponding number:

3. Present use of the subject lands:

Residential

4. Please describe **all existing** buildings or structures on the subject lands and whether they are to be retained, demolished or removed. If retaining the buildings or structures, please describe the type of buildings or structures, and illustrate the setback, in metric units, from front, rear and side lot lines, ground floor area, gross floor area, lot coverage, number of storeys, width, length, and height on your attached sketch which must be included with your application:

Single-family dwelling. Please see attached sketch.

5. If an addition to an existing building is being proposed, please explain what it will be used for (for example: bedroom, kitchen, or bathroom). If new fixtures are proposed, please describe.

6. Please describe **all proposed** buildings or structures/additions on the subject lands. Describe the type of buildings or structures/additions, and illustrate the setback, in metric units, from front, rear and side lot lines, ground floor area, gross floor area, lot coverage, number of storeys, width, length, and height on your attached sketch which must be included with your application:

New single-family dwelling. See attached designs.

7. Are any existing buildings on the subject lands designated under the *Ontario Heritage Act* as being architecturally and/or historically significant? Yes ☐ No ☒

If yes, identify and provide details of the building:

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8. If known, the length of time the existing uses have continued on the subject lands:

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9. Existing use of abutting properties:

Residential

10. Are there any easements or restrictive covenants affecting the subject lands?

☐ Yes ☒ No If yes, describe the easement or restrictive covenant and its effect:

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### C. Purpose of Development Application

**Note: Please complete all that apply.**

1. Please explain what you propose to do on the subject lands/premises which makes this development application necessary:

The applicants propose to construct a new single-family dwelling on the subject lands.

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2. Please explain why it is not possible to comply with the provision(s) of the Zoning By-law/and or Official Plan:

The current HL Official Plan designation and HL zoning do not permit the construction of a dwelling on the subject lands.

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3. Does the requested amendment alter all or any part of the boundary of an area of settlement in the municipality or implement a new area of settlement in the municipality? ☐ Yes ☒ No If yes, describe its effect:

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4. Does the requested amendment remove the subject land from an area of employment? ☐ Yes ☒ No If yes, describe its effect:

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5. Does the requested amendment alter, replace, or delete a policy of the Official Plan?  
☐ Yes ☒ No If yes, identify the policy, and also include a proposed text of the policy amendment (if additional space is required, please attach a separate sheet):

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6. Description of land intended to be severed in metric units:

Frontage: 

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Depth: 

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Width: 

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Lot Area: 

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Present Use: 

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Proposed Use: 

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Proposed final lot size (if boundary adjustment): 

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If a boundary adjustment, identify the assessment roll number and property owner of the lands to which the parcel will be added: 

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Description of land intended to be retained in metric units:

Frontage: 

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Depth: 

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Width: 

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Lot Area: 

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Present Use: 

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Proposed Use: 

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Buildings on retained land: 

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7. Description of proposed right-of-way/easement:

Frontage: 

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Depth: 

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Width: 

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Area: 

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Proposed use: 

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8. Name of person(s), if known, to whom lands or interest in lands to be transferred, leased or charged (if known):

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**9. Site Information****Zoning****Proposed**

Please indicate unit of measurement, for example: m, m<sup>2</sup> or %

Lot frontage	See attached schedule	
Lot depth		
Lot width		
Lot area		
Lot coverage		
Front yard		
Rear yard		
Left Interior side yard		
Right Interior side yard		
Exterior side yard (corner lot)		
Landscaped open space		
Entrance access width		
Exit access width		
Size of fencing or screening		
Type of fencing		

**10. Building Size**

Number of storeys		
Building height		
Total ground floor area		
Total gross floor area		
Total useable floor area		

**11. Off Street Parking and Loading Facilities**

Number of off street parking spaces		
Number of visitor parking spaces		
Number of accessible parking spaces		
Number of off street loading facilities		

12. Residential (if applicable)

Number of buildings existing: \_\_\_\_\_

Number of buildings proposed: \_\_\_\_\_

Is this a conversion or addition to an existing building? ☐ Yes ☐ No

If yes, describe: \_\_\_\_\_

Type	Number of Units	Floor Area per Unit in m2
Single Detached	_____	_____
Semi-Detached	_____	_____
Duplex	_____	_____
Triplex	_____	_____
Four-plex	_____	_____
Street Townhouse	_____	_____
Stacked Townhouse	_____	_____
Apartment - Bachelor	_____	_____
Apartment - One bedroom	_____	_____
Apartment - Two bedroom	_____	_____
Apartment - Three bedroom	_____	_____

Other facilities provided (for example: play facilities, underground parking, games room, or swimming pool):

13. Commercial/Industrial Uses (if applicable)

Number of buildings existing: \_\_\_\_\_

Number of buildings proposed: \_\_\_\_\_

Is this a conversion or addition to an existing building? ☐ Yes ☐ No

If yes, describe:

\_\_\_\_\_

Indicate the gross floor area by the type of use (for example: office, retail, or storage):

\_\_\_\_\_

\_\_\_\_\_

\_\_\_\_\_

Seating Capacity (for assembly halls or similar): \_\_\_\_\_

Total number of fixed seats: \_\_\_\_\_

Describe the type of business(es) proposed: \_\_\_\_\_

Total number of staff proposed initially: \_\_\_\_\_

Total number of staff proposed in five years: \_\_\_\_\_

Maximum number of staff on the largest shift: \_\_\_\_\_

Is open storage required: ☐ Yes ☐ No

Is a residential use proposed as part of, or accessory to commercial/industrial use?

☐ Yes ☐ No If yes please describe:

\_\_\_\_\_  
\_\_\_\_\_

14. Institutional (if applicable)

Describe the type of use proposed: \_\_\_\_\_

Seating capacity (if applicable): \_\_\_\_\_

Number of beds (if applicable): \_\_\_\_\_

Total number of staff proposed initially: \_\_\_\_\_

Total number of staff proposed in five years: \_\_\_\_\_

Maximum number of staff on the largest shift: \_\_\_\_\_

Indicate the gross floor area by the type of use (for example: office, retail, or storage):

\_\_\_\_\_  
\_\_\_\_\_  
\_\_\_\_\_

15. Describe Recreational or Other Use(s) (if applicable)

\_\_\_\_\_  
\_\_\_\_\_  
\_\_\_\_\_  
\_\_\_\_\_  
\_\_\_\_\_

#### D. Previous Use of the Property

1. Has there been an industrial or commercial use on the subject lands or adjacent lands? ☐ Yes ☐ No ☒ Unknown

If yes, specify the uses (for example: gas station or petroleum storage):

2. Is there reason to believe the subject lands may have been contaminated by former uses on the site or adjacent sites? ☐ Yes ☒ No ☐ Unknown

3. Provide the information you used to determine the answers to the above questions:

Owner knowledge of property

4. If you answered yes to any of the above questions in Section D, a previous use inventory showing all known former uses of the subject lands, or if appropriate, the adjacent lands, is needed. Is the previous use inventory attached? ☐ Yes ☐ No

#### E. Provincial Policy

1. Is the requested amendment consistent with the provincial policy statements issued under subsection 3(1) of the *Planning Act*, R.S.O. 1990, c. P. 13? ☒ Yes ☐ No

If no, please explain:

2. It is owner's responsibility to be aware of and comply with all relevant federal or provincial legislation, municipal by-laws or other agency approvals, including the Endangered Species Act, 2007. Have the subject lands been screened to ensure that development or site alteration will not have any impact on the habitat for endangered or threatened species further to the provincial policy statement subsection 2.1.7? ☐ Yes ☒ No

If no, please explain:

The subject lands have already been developed and are located in an existing residential neighbourhood.

3. Have the subject lands been screened to ensure that development or site alteration will not have any impact on source water protection? ☐ Yes ☒ No

If no, please explain:

Redevelopment of an existing developed site.

Note: If in an area of source water Wellhead Protection Area (WHPA) A, B or C please attach relevant information and approved mitigation measures from the Risk Manager Official.

4. Are any of the following uses or features on the subject lands or within 500 metres of the subject lands, unless otherwise specified? Please check boxes, if applicable.

**Livestock facility or stockyard** (submit MDS Calculation with application)

☐ On the subject lands or ☐ within 500 meters – distance \_\_\_\_\_

**Wooded area**

☐ On the subject lands or ☐ within 500 meters – distance \_\_\_\_\_

**Municipal Landfill**

☐ On the subject lands or ☐ within 500 meters – distance \_\_\_\_\_

**Sewage treatment plant or waste stabilization plant**

☐ On the subject lands or ☐ within 500 meters – distance \_\_\_\_\_

**Provincially significant wetland (class 1, 2 or 3) or other environmental feature**

☒ On the subject lands or ☐ within 500 meters – distance Lake Erie shoreline

**Floodplain**

☐ On the subject lands or ☐ within 500 meters – distance \_\_\_\_\_

**Rehabilitated mine site**

☐ On the subject lands or ☐ within 500 meters – distance \_\_\_\_\_

**Non-operating mine site within one kilometre**

☐ On the subject lands or ☐ within 500 meters – distance \_\_\_\_\_

**Active mine site within one kilometre**

☐ On the subject lands or ☐ within 500 meters – distance \_\_\_\_\_

**Industrial or commercial use (specify the use(s))**

☐ On the subject lands or ☐ within 500 meters – distance \_\_\_\_\_

**Active railway line**

☐ On the subject lands or ☐ within 500 meters – distance \_\_\_\_\_

**Seasonal wetness of lands**

☐ On the subject lands or ☐ within 500 meters – distance \_\_\_\_\_

**Erosion**

☐ On the subject lands or ☐ within 500 meters – distance \_\_\_\_\_

**Abandoned gas wells**

☐ On the subject lands or ☐ within 500 meters – distance \_\_\_\_\_

## F. Servicing and Access

1. Indicate what services are available or proposed:

### Water Supply

- ☒ Municipal piped water ☐ Communal wells  
☐ Individual wells ☐ Other (describe below)
- 

### Sewage Treatment

- ☒ Municipal sewers ☐ Communal system  
☐ Septic tank and tile bed in good working order ☐ Other (describe below)
- 

### Storm Drainage

- ☐ Storm sewers ☐ Open ditches  
☐ Other (describe below)
- 

2. Existing or proposed access to subject lands:

- ☒ Municipal road ☐ Provincial highway  
☐ Unopened road ☐ Other (describe below)

Name of road/street: Lakeside Lane

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## G. Other Information

1. Does the application involve a local business? ☐ Yes ☒ No

If yes, how many people are employed on the subject lands?

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2. Is there any other information that you think may be useful in the review of this application? If so, explain below or attach on a separate page.
- 
- 
- 
-

## H. Supporting Material to be submitted by Applicant

In order for your application to be considered complete, **folded** hard copies (number of paper copies as directed by the planner) and an **electronic version (PDF) of the properly named site plan drawings, additional plans, studies and reports** will be required, including but not limited to the following details:

1. Concept/Layout Plan
2. All measurements in metric
3. Key map
4. Scale, legend and north arrow
5. Legal description and municipal address
6. Development name
7. Drawing title, number, original date and revision dates
8. Owner's name, address and telephone number
9. Engineer's name, address and telephone number
10. Professional engineer's stamp
11. Existing and proposed easements and right of ways
12. Zoning compliance table – required versus proposed
13. Parking space totals – required and proposed
14. All entrances to parking areas marked with directional arrows
15. Loading spaces, facilities and routes (for commercial developments)
16. All dimensions of the subject lands
17. Dimensions and setbacks of all buildings and structures
18. Location and setbacks of septic system and well from all existing and proposed lot lines, and all existing and proposed structures
19. Gross, ground and useable floor area
20. Lot coverage
21. Floor area ratio
22. Building entrances, building type, height, grades and extent of overhangs
23. Names, dimensions and location of adjacent streets including daylighting triangles
24. Driveways, curbs, drop curbs, pavement markings, widths, radii and traffic directional signs
25. All exterior stairways and ramps with dimensions and setbacks
26. Retaining walls including materials proposed
27. Fire access and routes
28. Location, dimensions and number of parking spaces (including visitor and accessible) and drive aisles
29. Location of mechanical room, and other building services (e.g. A/C, HRV)
30. Refuse disposal and storage areas including any related screening (if indoors, need notation on site plan)
31. Winter snow storage location



32. Landscape areas with dimensions
33. Natural features, watercourses and trees
34. Fire hydrants and utilities location
35. Fencing, screening and buffering – size, type and location
36. All hard surface materials
37. Light standards and wall mounted lights (plus a note on the site plan that all outdoor lighting is to be dark sky compliant)
38. Business signs (make sure they are not in sight lines)
39. Sidewalks and walkways with dimensions
40. Pedestrian access routes into site and around site
41. Bicycle parking
42. Architectural elevations of all building sides
43. All other requirements as per the pre-consultation meeting

In addition, the following additional plans, studies and reports, including but not limited to, **may** also be required as part of the complete application submission:

- ☐ Zoning Deficiency Form
- ☐ On-Site Sewage Disposal System Evaluation Form (to verify location and condition)
- ☐ Architectural Plan
- ☐ Buildings Elevation Plan
- ☐ Cut and Fill Plan
- ☐ Erosion and Sediment Control Plan
- ☐ Grading and Drainage Control Plan (around perimeter and within site) (existing and proposed)
- ☐ Landscape Plan
- ☐ Photometric (Lighting) Plan
- ☐ Plan and Profile Drawings
- ☐ Site Servicing Plan
- ☐ Storm water Management Plan
- ☐ Street Sign and Traffic Plan
- ☐ Street Tree Planting Plan
- ☐ Tree Preservation Plan
- ☐ Archaeological Assessment
- ☐ Environmental Impact Study

- ☐ Functional Servicing Report
- ☐ Geotechnical Study / Hydrogeological Review
- ☐ Minimum Distance Separation Schedule
- ☐ Noise or Vibration Study
- ☐ Record of Site Condition
- ☐ Storm water Management Report
- ☐ Traffic Impact Study – please contact the Planner to verify the scope required

Site Plan applications will require the following supporting materials:

1. Two (2) complete sets of the site plan drawings folded to 8½ x 11 and an electronic version in PDF format
2. Letter requesting that the Holding be removed (if applicable)
3. A cost estimate prepared by the applicant's engineer
4. An estimate for Parkland dedication by a certified land appraiser
5. Property Identification Number (PIN) printout

Standard condominium exemptions will require the following supporting materials:

- ☐ Plan of standard condominium (2 paper copies and 1 electronic copy)
- ☐ Draft condominium declaration
- ☐ Property Identification Number (PIN) printout

Your development approval might also be dependent on Ministry of Environment and Climate Change, Ministry of Transportation or other relevant federal or provincial legislation, municipal by-laws or other agency approvals.

**All final plans must include the owner's signature as well as the engineer's signature and seal.**

#### **I. Development Agreements**

A development agreement may be required prior to approval for site plan, subdivision and condominium applications. Should this be necessary for your development, you will be contacted by the agreement administrator with further details of the requirements including but not limited to insurance coverage, professional liability for your engineer, additional fees and securities.

#### J. Transfers, Easements and Postponement of Interest


The owner acknowledges and agrees that if required it is their solicitor's responsibility on behalf of the owner for the registration of all transfer(s) of land to the County, and/or transfer(s) of easement in favour of the County and/or utilities. Also, the owner further acknowledges and agrees that it is their solicitor's responsibility on behalf of the owner for the registration of postponements of any charges in favour of the County.

#### K. Permission to Enter Subject Lands

Permission is hereby granted to Norfolk County officers, employees or agents, to enter the premises subject to this application for the purposes of making inspections associated with this application, during normal and reasonable working hours.

#### L. Freedom of Information

For the purposes of the *Municipal Freedom of Information and Protection of Privacy Act*, I authorize and consent to the use by or the disclosure to any person or public body any information that is collected under the authority of the *Planning Act*, R.S.O. 1990, c. P. 13 for the purposes of processing this application.

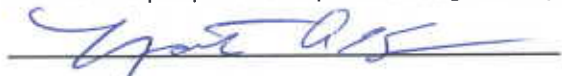

Owner/Applicant Signature

3 August, 2022

Date

#### M. Owner's Authorization

If the applicant/agent is not the registered owner of the lands that is the subject of this application, the owner(s) must complete the authorization set out below.

I/We Irene Sidway and Jeff Sidway am/are the registered owner(s) of the lands that is the subject of this application.

I/We authorize Brimage Law Group to make this application on my/our behalf and to provide any of my/our personal information necessary for the processing of this application. Moreover, this shall be your good and sufficient authorization for so doing.

E-SIGNED by Irene Sidway  
on 2022-08-16 02:06:15 GMT

Owner

3 August, 2022

Date

E-SIGNED by Jeff Sidway  
on 2022-08-08 01:01:53 GMT

Owner

3 August, 2022

Date

**N. Declaration**

I, Nathan Kolomaya of Norfolk County, Province of Ontario

solemnly declare that:

all of the above statements and the statements contained in all of the exhibits transmitted herewith are true and I make this solemn declaration conscientiously believing it to be true and knowing that it is of the same force and effect as if made under oath and by virtue of *The Canada Evidence Act*.

Declared before me at:


Norfolk County

  
Owner/Applicant Signature

In the Province of Ontario

This 26 day of August


A.D., 2022

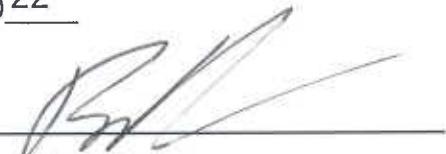  
A Commissioner, etc.

**SCHEDULE: SITE INFORMATION**

	<b>Provision</b>	<b>Permitted</b>	<b>Proposed</b>	<b>Deficiency</b>
Sideyard Setback	5.1.2	1.2m	0.7m	0.5m



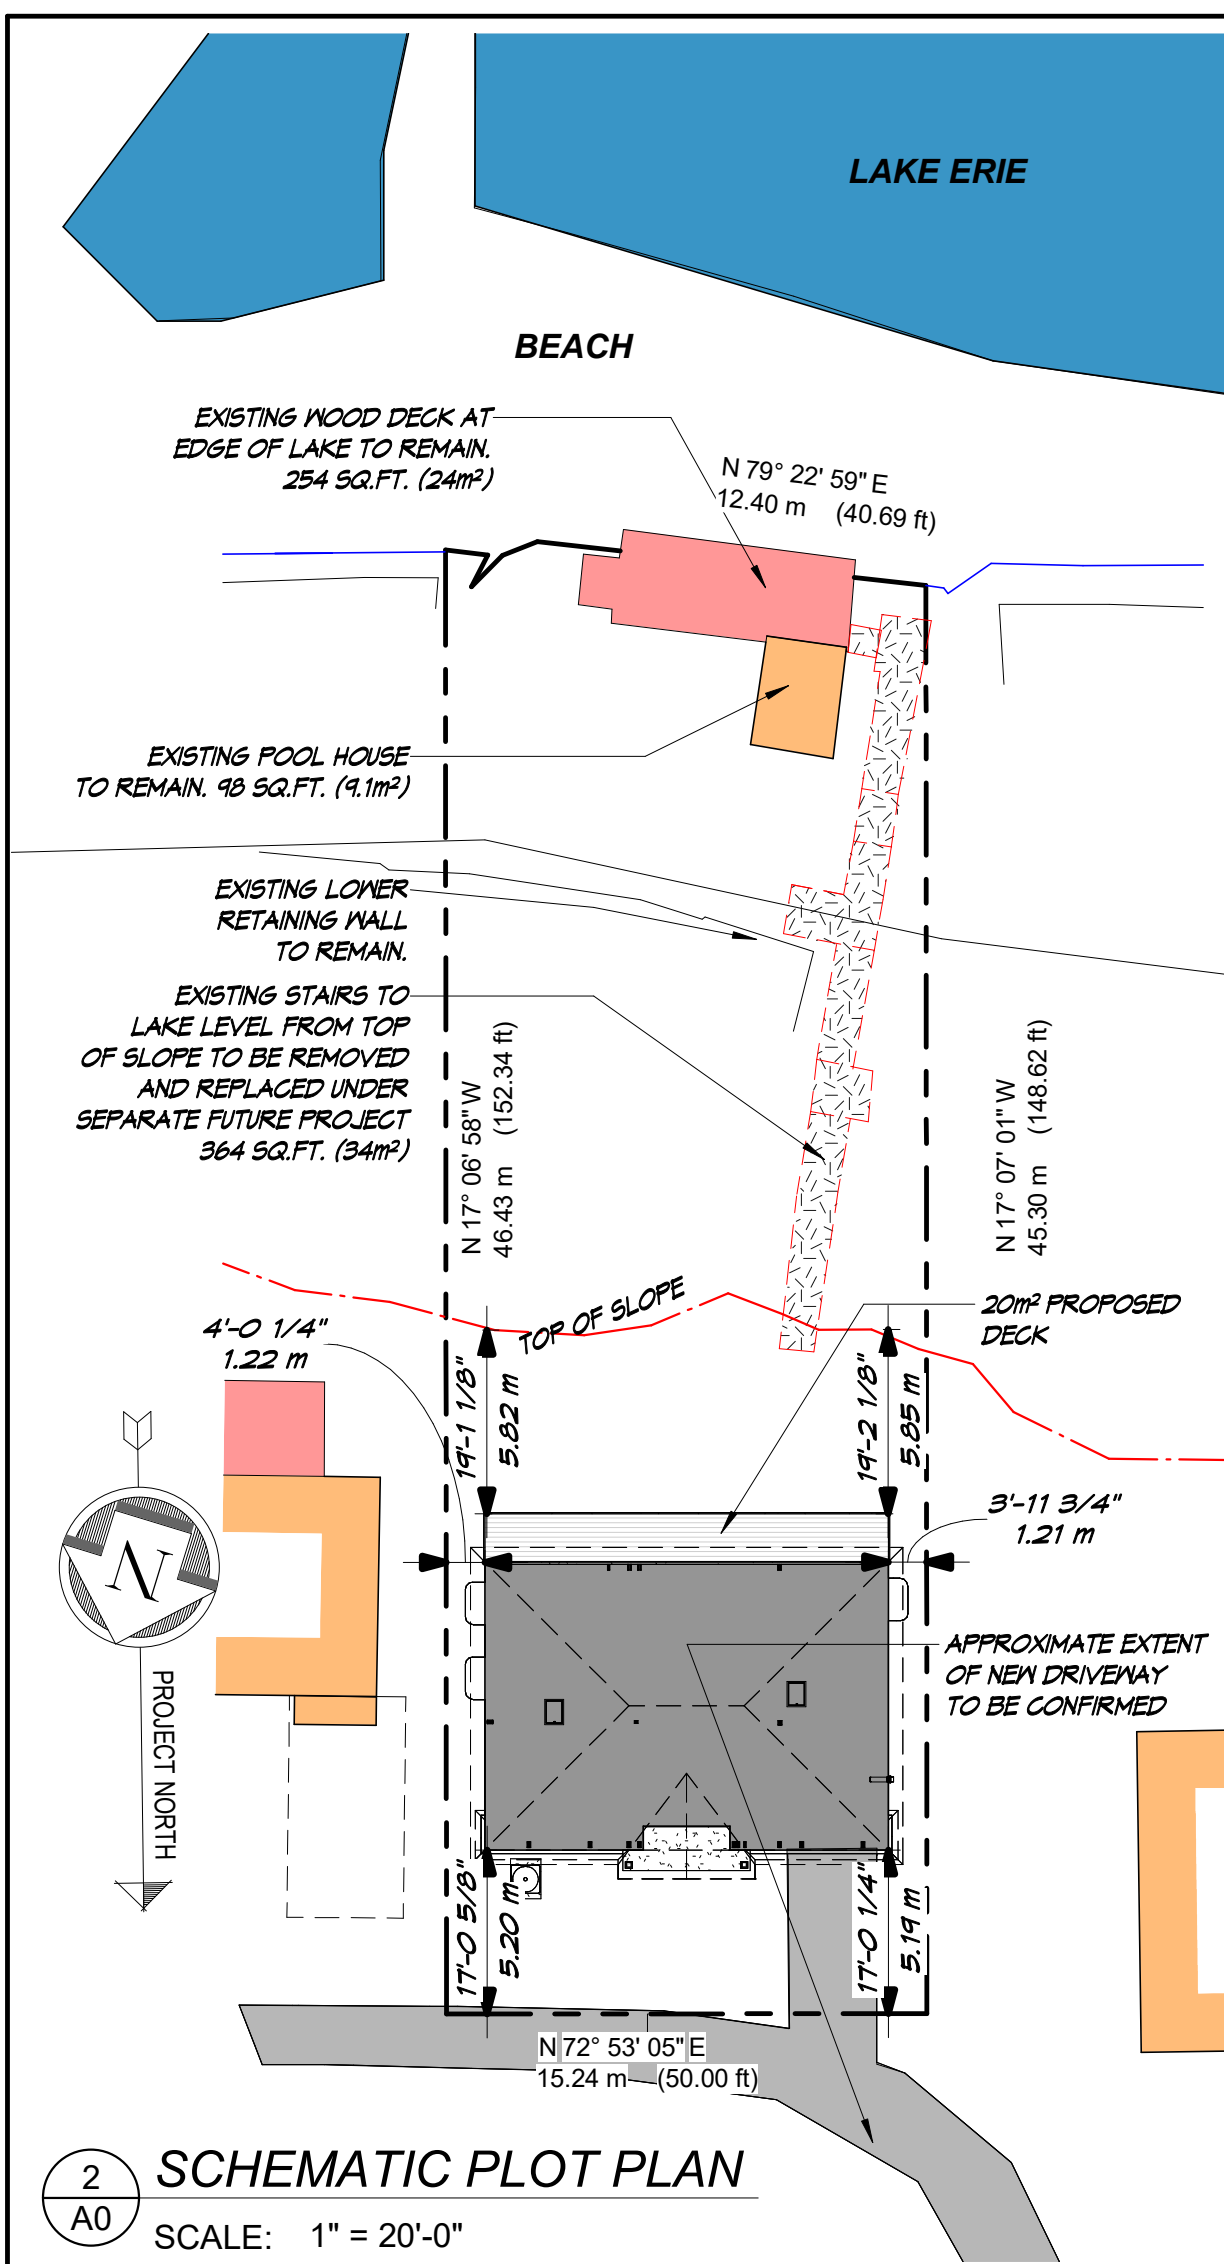

<b>ENERGY EFFICIENCY DESIGN ASSUMPTION MATRIX</b>			
<b>[A] GENERAL NOTES</b>			
<p>THESE DRAWINGS HAVE BEEN PREPARED TO MEET OR EXCEED THE REQUIREMENTS OF SB-12 OF THE ONTARIO BUILDING CODE AS AMENDED JANUARY 1, 2012 (EnerGuide® 0). COMPLIANCE WITH THE NEW REGULATIONS CAN BE ACHIEVED IN ONE OF THE FOUR WAYS. THE SUMMARY BELOW IDENTIFIES THE DESIGN ASSUMPTIONS IN CONJUNCTION WITH THE CLIENT PRIOR TO SUBMISSION FOR BUILDING PERMIT. AS A POINT OF REFERENCE, THIS DESIGN IS BASED ON THE PROSCRIPTIVE SB-12 PACKAGES FOUND IN SB-12-3.1.1.</p> <p>IF THE CONTRACTOR CHOOSES TO ACHIEVE COMPLIANCE THROUGH ONE OF THE THREE ACCEPTED METHODS BASED ON PERFORMANCE, Energy Star® OR EnerGuide® 0 PROGRAMS THEN THE DESIGN MUST BE INDEPENDENTLY VERIFIED BY A CERTIFIED ENERGY EVALUATOR. INDEPENDENT VERIFICATION BY A CERTIFIED ENERGY EVALUATOR, PRIOR TO OCCUPANCY IS RECOMMENDED AS THE MOST EFFECTIVE WAY OF ENSURING COMPLIANCE. THESE CONSULTANTS SPECIALIZE IN PERFORMING THIS TYPE OF ANALYSIS. TESTING AND WILL PROVIDE PAPERWORK CONFIRMING THE RESULTS OF THIS TESTING TO THE BUILDING DEPARTMENT AT THE POINT OF SUBSTANTIAL COMPLETION OF THE HOME.</p>			
<b>[B] SB-12 COMPLIANCE OPTIONS</b>			
<input checked="" type="checkbox"/>	SB-12 Prescriptive [SB-12 - 3.1.1]	Table: <b>SB-12 T3.1.1.2 A (1P)</b>	Package <b>A5 BUT WITH UPGRADED WALL INSULATION</b>
<input type="checkbox"/>	SB-12 Performance * [SB-12 - 3.1.1]	*Attach energy performance calculations using an approved software	
<input type="checkbox"/>	Energy Star® * [SB-12 - 3.1.1]	* Attach BOP form. House must be labeled on completion by Energy Star	
<input type="checkbox"/>	EnerGuide® 0 *	* House must be evaluated by NRCan advisor and meet a rating of 80	

STAMP

ONTARIO  
ASSOCIATION  
OF ARCHITECTS

PROFESSIONAL ENGINEER 1983-1992

*DBB*

2022.05.19

LICENSED TECHNOLOGIST  
OAA

DAVID B. BENNETT  
LICENCE  
7019

Drawn By: <b>D.BENNETT</b>	Date: <b>MARCH 2021</b>
Designed By : <b>D.B.</b>	Drawing No.     <b>A0</b>
Checked By : <b>D.B.</b>	
Project No. <b>21-005</b>	

ENGINEERED WOOD BEAMS	
<p>LVL 1 = 1 3/4"x11 7/8" LVL 2.0E BY MICROLAM  LVL 2 = 3 1/2"x11 7/8" LVL 2.0E BY MICROLAM  LVL 3 = 5 1/4"x 9 1/2" LVL 2.0E BY MICROLAM  LVL 4 = 5 1/4"x11 7/8" LVL 2.0E BY MICROLAM  LVL 5 = 5 1/4"x14" LVL 2.0E BY MICROLAM</p>	
<p>ALL BEAMS TO HAVE MIN 3 1/2" BEARINGS AT EACH END,  ALL JOISTS MIN. 1 1/2" BEARINGS AT EACH END</p>	

NOTE: MASONRY LINTEL SCHEDULE:

O.B.C. (B) 9.20.5.2 AND TABLE 9.20.5.2B. THIS CHART CAN ONLY BE USED FOR BRICK VENEER. IF MATERIALS ARE USED, THESE VALUES WILL REQUIRE FURTHER REVIEW.

X 3 1/2 X 1/2 X 1/4" ANGLE = 8'-0" MAX SPAN	L4 = L- 5 X 3 1/2 X 3/8" ANGLE = 11'-5" MAX SPAN
X 3 1/2 X 3/16" ANGLE = 8'-4" MAX SPAN	L5 = L- 6 X 4 X 1/2" ANGLE = 13'-5" MAX SPAN
X 3 1/2 X 5/16" ANGLE = 10'-10" MAX SPAN	

BEAM SCHEDULE

50X22 STEEL BEAM	SB3 = M250X33	STEEL BEAM
100X22 STEEL BEAM	SB4 = M310X39	STEEL BEAM

6" PAD SCHEDULE:

4'X8'X14" CONCRETE PAD WITH 3-15M RE-BAR EACH WAY

4'X6'X16" CONCRETE PAD WITH 3-15M RE-BAR EACH WAY

4'X4'X20" CONCRETE PAD WITH 15M RE-BAR @ 12" O/C E/M

4'X8'X22" CONCRETE PAD WITH 15M RE-BAR @ 12" O/C E/M

QUOS STRIP FOOTING SCHEDULE:

STRIP	18'x6" CONCRETE WITH
EXTERIOR WALLS	2-15M REBAR CONTINUOUS
STRIP	18'x6" CONCRETE WITH
INTERIOR WALLS	2-15M REBAR CONTINUOUS

SHALL BE CENTERED UNDER COLUMNS. CONTRACTOR TO COORDINATE PAD LOCATIONS W/ DIMENSIONS LOCATING

SHALL BE CENTERED UNDER CONCRETE FOUNDATION WALLS AND INTERIOR LOAD BEARING STUD WALLS. CONTRACTOR TO FOOTING AND WALL DIMENSIONS ON PLANS AND REPORT ANY DISCREPANCIES TO THE DESIGNER PRIOR TO CONSTRUCTION. IF THE FOUNDATION WALLS IS REQUIRED, ALL RE-BAR SHALL BE DONNELED INTO FOOTINGS MIN. 2" EMBEDMENT FOR TIE-IN DONNELS)

WORK WALLS SHALL BE REINFORCED ACCORDING TO O.B.C. 2012 REQUIREMENTS.

STEEL TELE-POST SCHEDULE:

P1 = POST RATED FOR 8 kip AND CENTERED ON FOOTING PAD

P2 = POST RATED FOR 20 kip AND CENTERED ON FOOTING PAD

P3 = POST RATED FOR 30 kip AND CENTERED ON FOOTING PAD












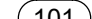
DECK PIER FOUNDATION SCHEDULE:

ST1 = 12" DIA. CONCRETE SONO TUBE FOUNDATION ON PAD FOOTING. REFER TO PAD FOOTING SCHEDULE FOR FOOTING SIZE.

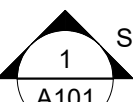ST2 = 16" DIA. CONCRETE SONO TUBE FOUNDATION ON PAD FOOTING. REFER TO PAD FOOTING SCHEDULE FOR FOOTING SIZE.

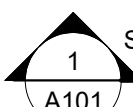
SQ1 = 16'x16" SQUARE PIER FOUNDATION WITH 10M DONNELS @ CORNERS EMBEDDED INTO ON PAD FOOTING. 3" MIN. COVER. REFER TO PAD FOOTING SCHEDULE FOR FOOTING SIZE.
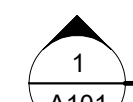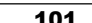
## SYMBOLS LEGEND

	SIM	BUILDING ELEVATION REFERENCE		ELEVATION REFERENCE		BATHROOM EXHAUST FAN
	SIM	BUILDING SECTION REFERENCE		<u>View Name</u> SCALE: 1/8" = 1'-0"		SMOKE DETECTOR
	SIM	DETAIL SECTION REFERENCE	<b>Room name</b> 	ROOM NAME - NUMBER REFERENCE		SMOKE / CARBON MONOXIDE DETECTOR
				EXTERIOR WINDOW REFERENCE		SD / CMD
				EXTERIOR DOOR REFERENCE		

## ABBREVIATIONS

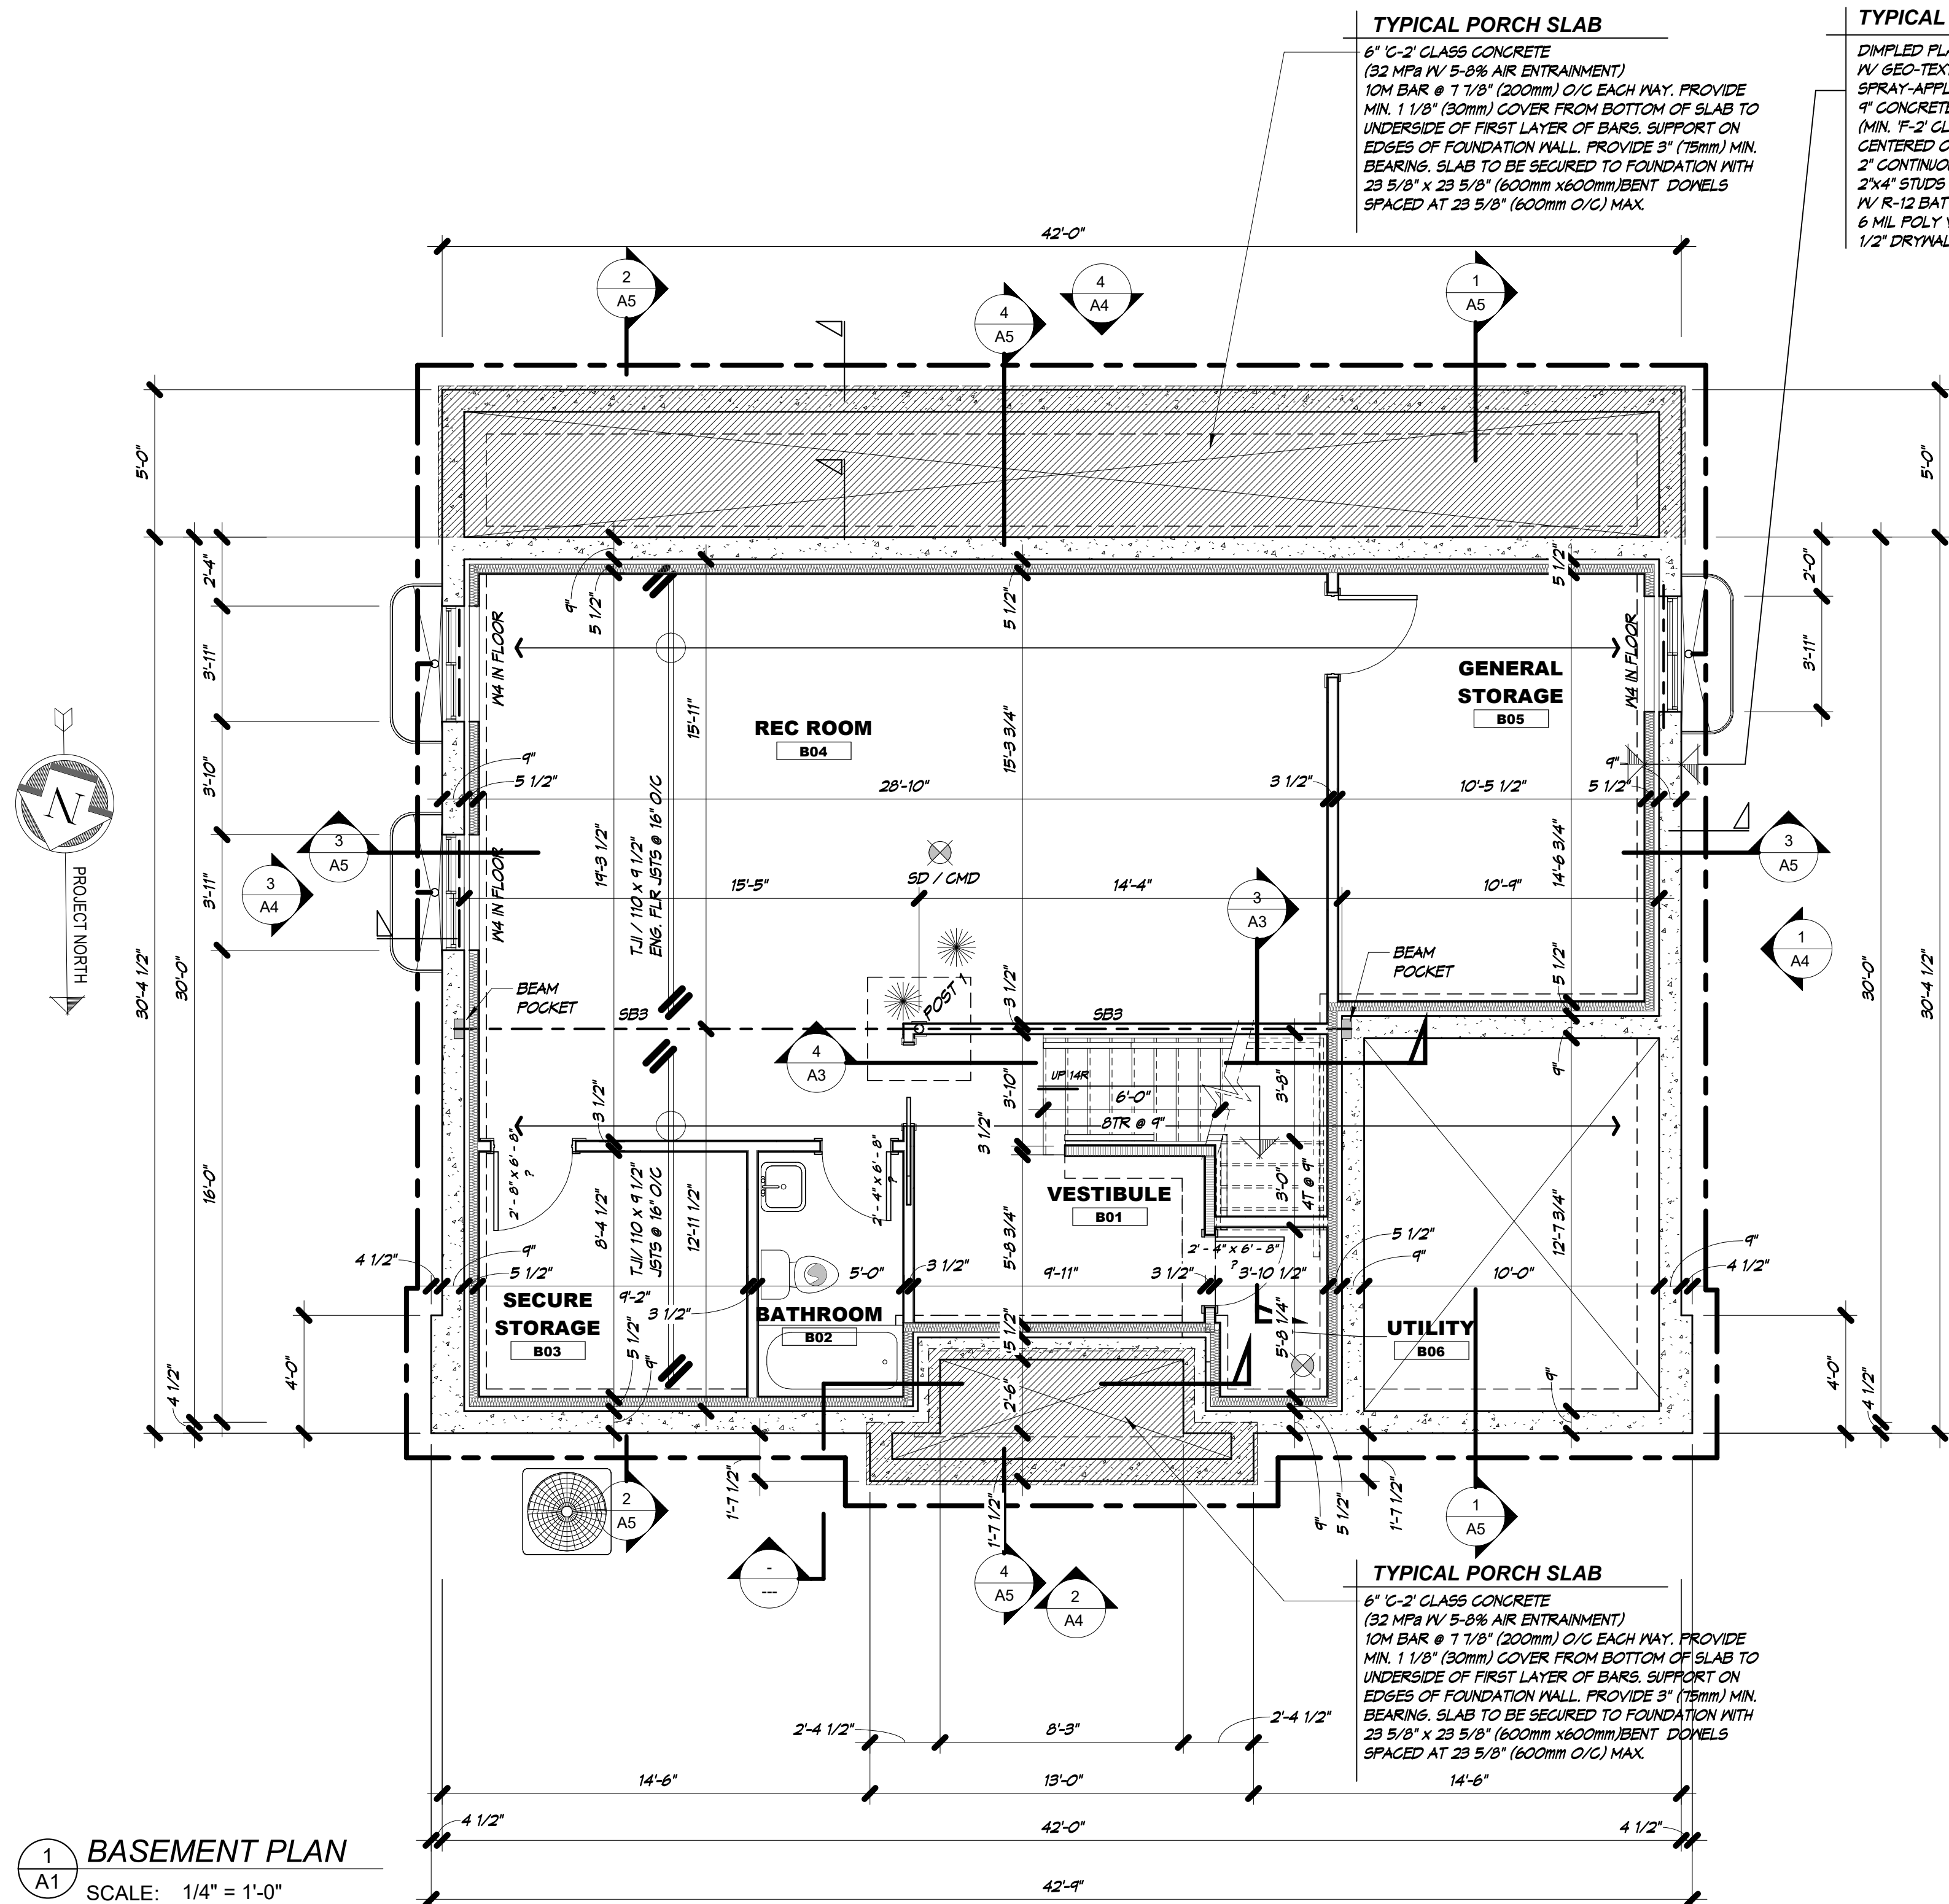

**GENERAL NOTES**

- DRAWING CONTENT AND DIMENSIONS
  - 1.1. CONTENT OF DRAWINGS DOES NOT RELEASE CONTRACTOR FROM COMPLIANCE WITH THE ONTARIO BUILDING CODE 2012 (O.B.C.), MUNICIPAL BY-LAWS, AND ANY OTHER REGULATIONS OR AUTHORITIES THAT HAVE JURISDICTION.
  - 1.2. DO NOT SCALE DRAWINGS.
  - 1.3. REFER TO THE TITLE BLOCK OF EACH DRAWING FOR NOTES THAT ARE PARTICULAR TO THE PLANS AND DETAILS THEREIN.
  - 1.4. ALL DIMENSIONS ARE RELATIVE TO THE COMPOSITION OF BUILDING ASSEMBLIES AS INDICATED. REFER TO THE TITLE BLOCK OF EACH DRAWING FOR NOTES.
  - 1.5. ELEVATIONS AND CORRESPONDING DIMENSIONS ARE RELATIVE TO TOP OF SUBFLOOR ONLY. CONTRACTOR IS RESPONSIBLE FOR SITE GRADING UNLESS OTHERWISE INDICATED ON PLANS.
  - 1.6. CONTRACTOR SHALL REVIEW PLANS AND REPORT ANY DISCREPANCIES TO THE DESIGNER PRIOR TO CONSTRUCTION.
- BUILDING SERVICES AND EQUIPMENT
  - 2.1. CONTRACTOR SHALL DETERMINE EXACT LOCATION OF SERVICES AND EQUIPMENT. IF SHOWN ON PLANS, THESE LOCATIONS SHALL BE VERIFIED BY CONTRACTOR PRIOR TO CONSTRUCTION.
  - 2.2. IT IS THE RESPONSIBILITY OF THE CONTRACTOR TO PROVIDE ALL NECESSARY DRAWINGS FOR MECHANICAL, ELECTRICAL AND PLUMBING SYSTEMS. THE DESIGN OF THESE SYSTEMS SHALL BE PREPARED BY A QUALIFIED DESIGNER IN ACCORDANCE WITH O.B.C. 2012.
- EXTERIOR CLADDING
  - 3.1. MATERIAL TO BE AS SPECIFIED. FINAL SIZE, COLOUR AND PATTERN TO BE DETERMINED BY CONSULTING THE OWNER.
- WOOD MATERIALS
  - 4.1. ALL LUMBER MATERIALS MUST BE No. 2 GRADE SPRUCE-PINE-FIR OR BETTER, OR AS SPECIFIED.
  - 4.2. ALL ENGINEERED WOOD PRODUCTS TO BE SUPPLIED AS SPECIFIED, NO SUBSTITUTIONS.
- WOOD AND STEEL LINTELS
  - 5.1. ALL WOOD AND STEEL LINTEL SIZES INDICATED IN SCHEDULES ARE MINIMUM SIZES AS REQUIRED BY THE O.B.C. SEE STRUCTURAL SCHEDULES FOR FURTHER INFORMATION.
  - 5.2. CORRESPONDING LINTELS ARE NOMINAL ACTUAL DOOR AND WINDOW SIZES TO BE DETERMINED UPON SELECTION BY CONTRACTOR.
- STEEL BEAMS
  - 6.1. ALL STEEL BEAM SIZES INDICATED ARE MINIMUM SIZES AS REQUIRED BY THE O.B.C. SEE STRUCTURAL SCHEDULES FOR FURTHER INFORMATION.
- STEEL POSTS
  - 7.1. SHOP DRAWINGS FOR POSTS SUPPORTING LOADS GREATER THAN 8,000 LBS. (8 kip) SHALL BE SUBMITTED TO DESIGNER FOR REVIEW AND APPROVAL PRIOR TO CONSTRUCTION.
- FLOOR SYSTEM
  - 8.1. MINIMUM END BEARING FOR NOMINAL WOOD FLOOR JOISTS SHALL BE 1 1/2". MINIMUM BEARING FOR LINTELS OR BEAMS SHALL BE 3 1/2" UNLESS OTHERWISE NOTED.
  - 8.2. MINIMUM BEARING LENGTH OF PRE-ENGINEERED FLOOR JOISTS SHALL MEET OR EXCEED MANUFACTURER'S SPECIFICATIONS.
  - 8.3. SUB-FLOOR SHALL BE GLUED AND SCREWED TO ALL JOISTS TO REDUCE FLEX IN FLOOR SYSTEM.
  - 8.4. ALL BLOCKING PANELS BETWEEN JOISTS SHALL BE SAME PRODUCT AS JOISTS.
  - 8.5. POINT LOADS FROM ABOVE SHALL BE SOLID BLOCKED (SQUASH BLOCKS) TO BEARING BELOW. BLOCKING TO MAINTAIN WIDTH OF ABOVE POST AS A MINIMUM.
- FLOOR FINISHES
  - 9.1. DESIGNER HAS ASSUMED THE INSTALLATION OF STANDARD FINISH MATERIALS SUCH AS CARPET, LINOLEUM, OR HARDWOOD. FINISHES THAT EXERT ADDITIONAL LOADS SUCH AS CERAMIC TILE, STONE OR PORCELAIN TILE HAVE NOT BEEN ACCOUNTED FOR. REPORT THESE REVISED SELECTIONS TO THE DESIGNER FOR FURTHER INSTRUCTION.
- DOORS AND WINDOWS
  - 10.1. ROUGH STUD OPENINGS (R.S.O.) FOR EXTERIOR DOORS, WINDOWS, AND THEIR CORRESPONDING LINTELS ARE NOMINAL. ACTUAL DOOR AND WINDOW SIZES TO BE DETERMINED UPON SELECTION BY CONTRACTOR.
  - 10.2. EXTERIOR DOORS TO BE INSULATED STEEL STANLEY OR EQUAL.
  - 10.3. WINDOWS TO BE VIRGIN VINYL FRAMED DOUBLE GLAZED UNITS AS SPECIFIED BY OWNER.
- SMOKE AND CARBON MONOXIDE DETECTORS
  - 11.1. SMOKE AND CARBON MONOXIDE DETECTORS SHALL BE LOCATED AND DESIGNED AS PER O.B.C.
- SHOP DRAWINGS
  - 12.1. SHOP DRAWINGS OF SPECIAL MATERIALS OR EQUIPMENT INDICATED ON PLANS SHALL BE SUBMITTED TO THE DESIGNER BY THE CONTRACTOR PRIOR TO CONSTRUCTION.

**FOUNDATION NOTES**

- LATERALLY UNSUPPORTED FOUNDATION WALLS AS PER [B] 9.15.4.3 (1) SHALL BE REINFORCED. (REINFORCING MUST BE DESIGNED BY P.E.N.G. OR OTHER SUITABLY QUALIFIED PERSON.)
  - FOUNDATION WALL OPENING REINFORCING REQUIREMENTS AS PER O.B.C. [B] 9.15.4.3 (3) (A) & (B).
- ALL OPENINGS MUST BE REINFORCED UNDER A DESIGN IN ACCORDANCE WITH PART 4 OF THE O.B.C. WHEN OPENINGS EXCEED THE FOLLOWING CONDITIONS:
- ALL OPENINGS 1.2m OR WIDER IN WIDTH
  - FOR WALLS WHERE THE TOTAL WIDTH OF OPENINGS CONSTITUTES MORE THAN 25% OF THE TOTAL WIDTH OF THE WALL.
- PART 4 STRUCTURAL DESIGN MUST BE PERFORMED BY P.E.N.G. (P.E.O.) OR OTHER SUITABLY QUALIFIED PERSON.

**CONTRACTOR'S NOTES**

ALL INTERIOR DIMENSIONS ARE TO FACE OF STUDS UNLESS OTHERWISE NOTED.

ALL EXTERIOR DIMENSIONS ARE TO FACE OF FOUNDATION UNLESS OTHERWISE NOTED.

INTERIOR BASEMENT DIMENSIONS ARE TO FACE OF FOUNDATION AND LOAD BEARING WALLS. ALL EXTERIOR WINDOW AND DOOR OPENINGS ARE ROUGH STUD OPENINGS (R.S.O.).

INTERIOR DOOR SIZES NOTED ARE DOOR LEAF SIZES. FOR ROUGH STUD OPENING ADD 3" TO WIDTH AND 2" TO HEIGHT.

CONTRACTOR TO VERIFY ALL DIMENSIONS BEFORE STARTING WORK.

CONTRACTOR TO PROVIDE SOUND ATTENUATION BATTS IN WALLS AROUND THE PERIMETER OF INTERIORS FOR WALL BATHROOMS AND WALLS BETWEEN BEDROOM AND LIVING SPACES AND AS DIRECTED BY HOME OWNER.

CONTRACTOR SHALL PROVIDE SOUND ATTENUATION BATTS IN THE CEILINGS ABOVE THE UTILITY ROOM IN THE BASEMENT.

**PLAN NOTES**

- BLOCKING IN WALLS
  - 1.1. WHERE INDICATED, BLOCKING IS TO BE INSTALLED BETWEEN OR AGAINST STUDS IN THE WALLS ADJACENT TO THE TOILET, SHOWER AND/OR BATHTUB TO SUPPORT FUTURE INSTALLATION OF GRAB BARS IN ACCORDANCE WITH O.B.C. 2012 [B] 9.5.2.3.
- BLOCKING LOCATION IN WALLS TO BE IN ACCORDANCE WITH GRAB BAR REQUIREMENTS OF O.B.C. 2012 [B] 9.8.
- POST SUPPORTING BEAMS
  - 2.1. POST SIZES INDICATED ARE THE MINIMUM REQUIRED. SIZE OF POSTS CAN NOT BE REDUCED.
  - 2.2. POSTS SHALL NOT BE CHANGED WITHOUT REVIEW BY THE DESIGNER PRIOR TO INSTALLATION.
- SMOKE / CARBON MONOXIDE DETECTORS
  - 3.1. LOCATIONS SHOWN IS FOR CONTEXT ONLY. CONTRACTOR TO CONFIRM EXACT LOCATIONS.
  - 3.2. AT LEAST ONE SMOKE ALARM & CARBON MONOXIDE DETECTOR MUST BE LOCATED ON EVERY FLOOR.
  - 3.3. ONE SMOKE ALARM SHALL BE INSTALLED IN EACH BEDROOM OR ROOM INTENDED FOR SLEEPING.
  - 3.4. AT LEAST ONE ADDITIONAL UNIT INSTALLED BETWEEN SLEEPING ROOMS AND THE REMAINDER OF THE STOREY. IF THE SLEEPING ROOMS ARE SERVED BY A HALLWAY THEN THE ALARM SHALL BE INSTALLED IN THE HALLWAY.

- PRE-ENGINEERED WOOD PRODUCTS
  - 4.1. PRODUCTS TO BE SUPPLIED AS SPECIFIED ON DRAWINGS, NO SUBSTITUTIONS.
- STRUCTURAL STEEL
  - 5.1. ALL STRUCTURAL STEEL CONNECTIONS, BEARINGS, PLATES, ETC., SHALL BE DESIGNED BY THE STEEL FABRICATOR. GENERAL CONTRACTOR SHALL SUPPLY STRUCTURAL STEEL AND CONNECTION DESIGNS SEALED BY P.E.N.G. (P.E.O.).

**SHOP DRAWINGS**

PRE-ENGINEERED WOOD PRODUCTS SUCH AS ENGINEERED BEAMS, ROOF TRUSSES, LINTELS, & GIRDERS TO BE DESIGNED & ENGINEERED BY ENGINEERED WOOD PRODUCT MANUFACTURER.

TRUSS MANUFACTURER TO CONFIRM SIZES OF ALL BEAMS, GIRDERS AND LINTELS SUPPORTING ROOF TRUSSES. THIS SIZING SHALL BE CONFIRMED ON TRUSS MANUFACTURER'S SHOP DRAWINGS.

TRUSS SHOP DRAWINGS MUST BE SEALED BY P.E.N.G. (P.E.O.) AND SUBMITTED TO DESIGNER FOR REVIEW PRIOR TO CONSTRUCTION.

ALL PRODUCTS MANUFACTURED BY PROPRIETARY PRODUCT SUPPLIER'S SUCH AS RAILING SYSTEMS MUST BE ACCOMPANIED WITH PRODUCT LITERATURE ILLUSTRATING COMPLIANCE WITH APPLICABLE SB-1 REQUIREMENTS. THIS LITERATURE MUST BE SUBMITTED WITH THE PERMIT DRAWING PACKAGE TO AVOID DELAY IN THE PROCESSING OF THE APPLICATION.

**TYPICAL SLAB ASSEMBLY****TYPICAL BASEMENT FLOOR SLAB**

4" CONC. SLAB N' CLASS (20 MPa)  
OVER 15 MIL POLY VAPOUR BARRIER OVER  
6" CLEAR STONE (3/4") COMPACTED.

**TYPICAL GARAGE FLOOR SLAB**

6" EXPOSURE CLASS N CONCRETE (25 MPa WITH NO AIR)  
REINFORCED WITH 6X6X1/4 INVM  
6" GRANULAR "A" COMPACTED TO 100% SPHND

**EXTERIOR PORCH SLAB**

6" C-2 CLASS CONCRETE  
(32 MPa IV 5-8% AIR ENTRAINMENT)  
10M BAR @ 7 1/8" (200mm) O/C EACH WAY. PROVIDE MIN. 1 1/8" (30mm) COVER TO BOTTOM OF SLAB TO UNDERSIDE OF FIRST LAYER OF BARS. SUPPORT ON EDGES OF FOUNDATION WALL. PROVIDE 3" (75mm) MIN. BEARING. SLAB TO BE SECURED TO FOUNDATION WITH 23 5/8" x 23 5/8" (600mm x 600mm) BENT DOWELS SPACED AT 23 5/8" (600mm) O/C MAX.

3	COORDINATED WITH PILE FOUNDATION DESIGN, ISSUED FOR LRCA APPROVAL AND FOR BUILDING PERMIT APPLICATION	2022.05.19
2	ISSUED TO STRUCTURAL ENGINEER FOR PART 4 REVIEW	2021.04.30
1	ISSUED TO CLIENT FOR FINAL REVIEW	2021.03.29
No.	REVISION	DATE

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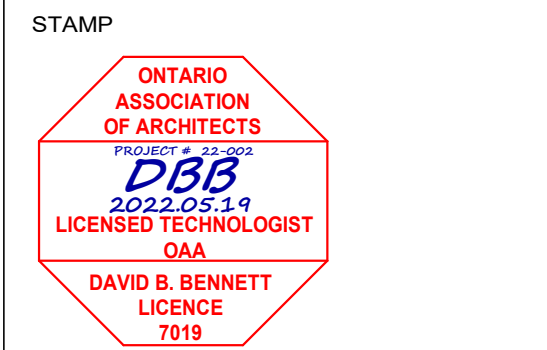
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**ISSUED FOR BUILDING PERMIT APPLICATION**  
MAY 19, 2022



**Engaged**  
Custom Home Design

**David B. Bennett**  
Licensed Technologist OAA  
O.B.C. Qualified Design ; Small Buildings

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Email: Dave@engageddesign.ca  
Web Site: www.engageddesign.ca

PROJECT  
NEW COTTAGE  
For : Irene & Jeff Sidway  
13 LAKESIDE LANE  
PORT DOVER, ONTARIO  
NORFOLK COUNTY


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**PROPOSED FOUNDATION PLAN**

Drawn by: D. BENNETT	Date: MARCH 2021
Designed by: D.B.	Drawing No.
Checked by: D.B.	
Project No.	<b>A1</b>
<b>21-005</b>	









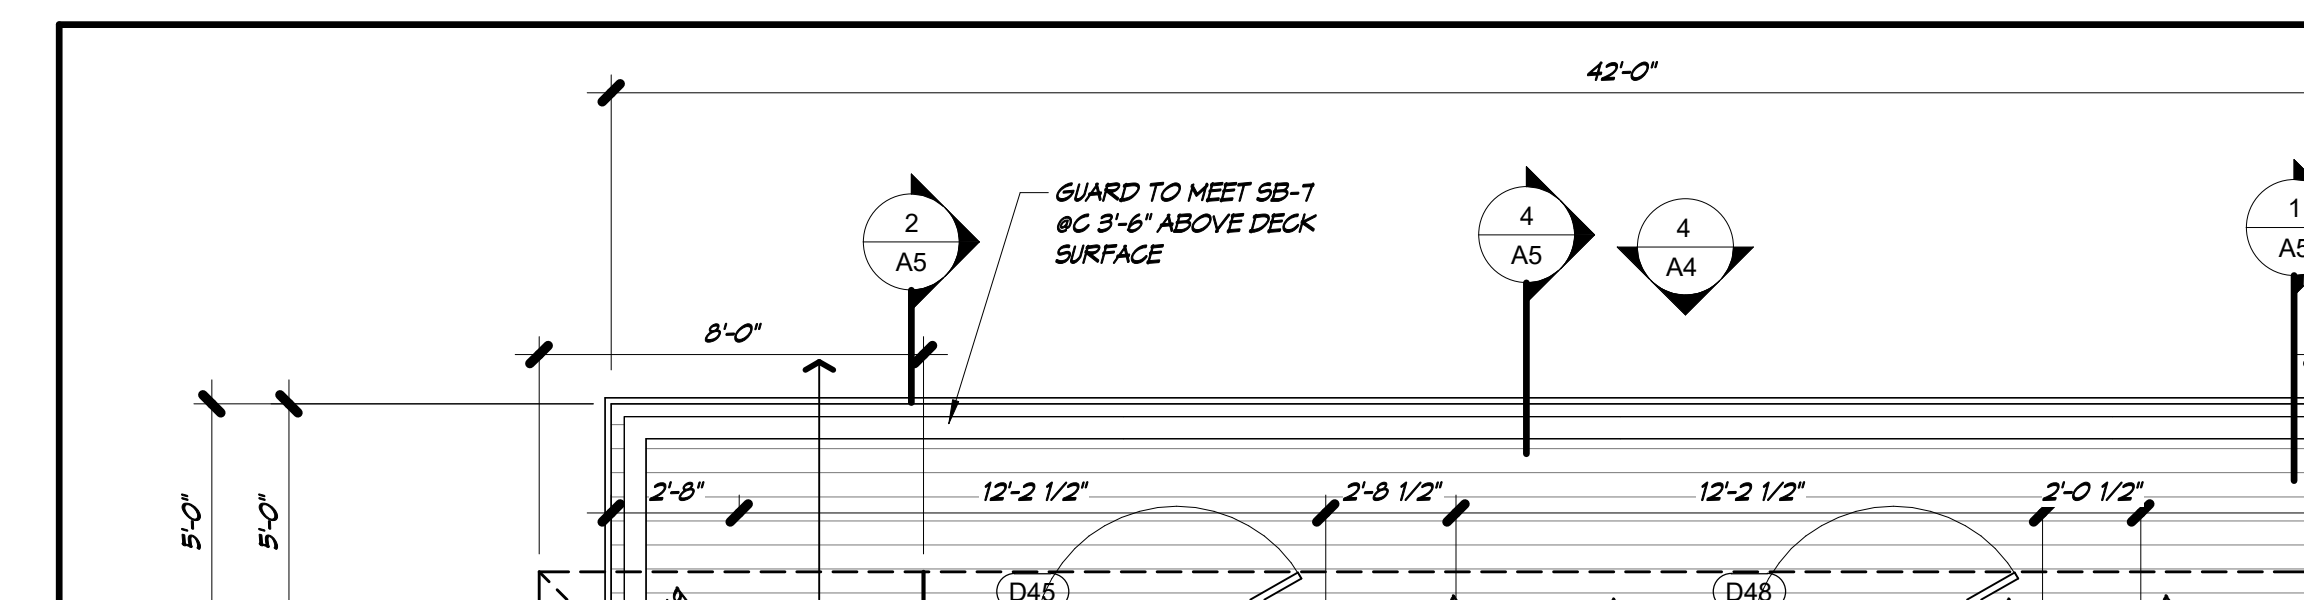




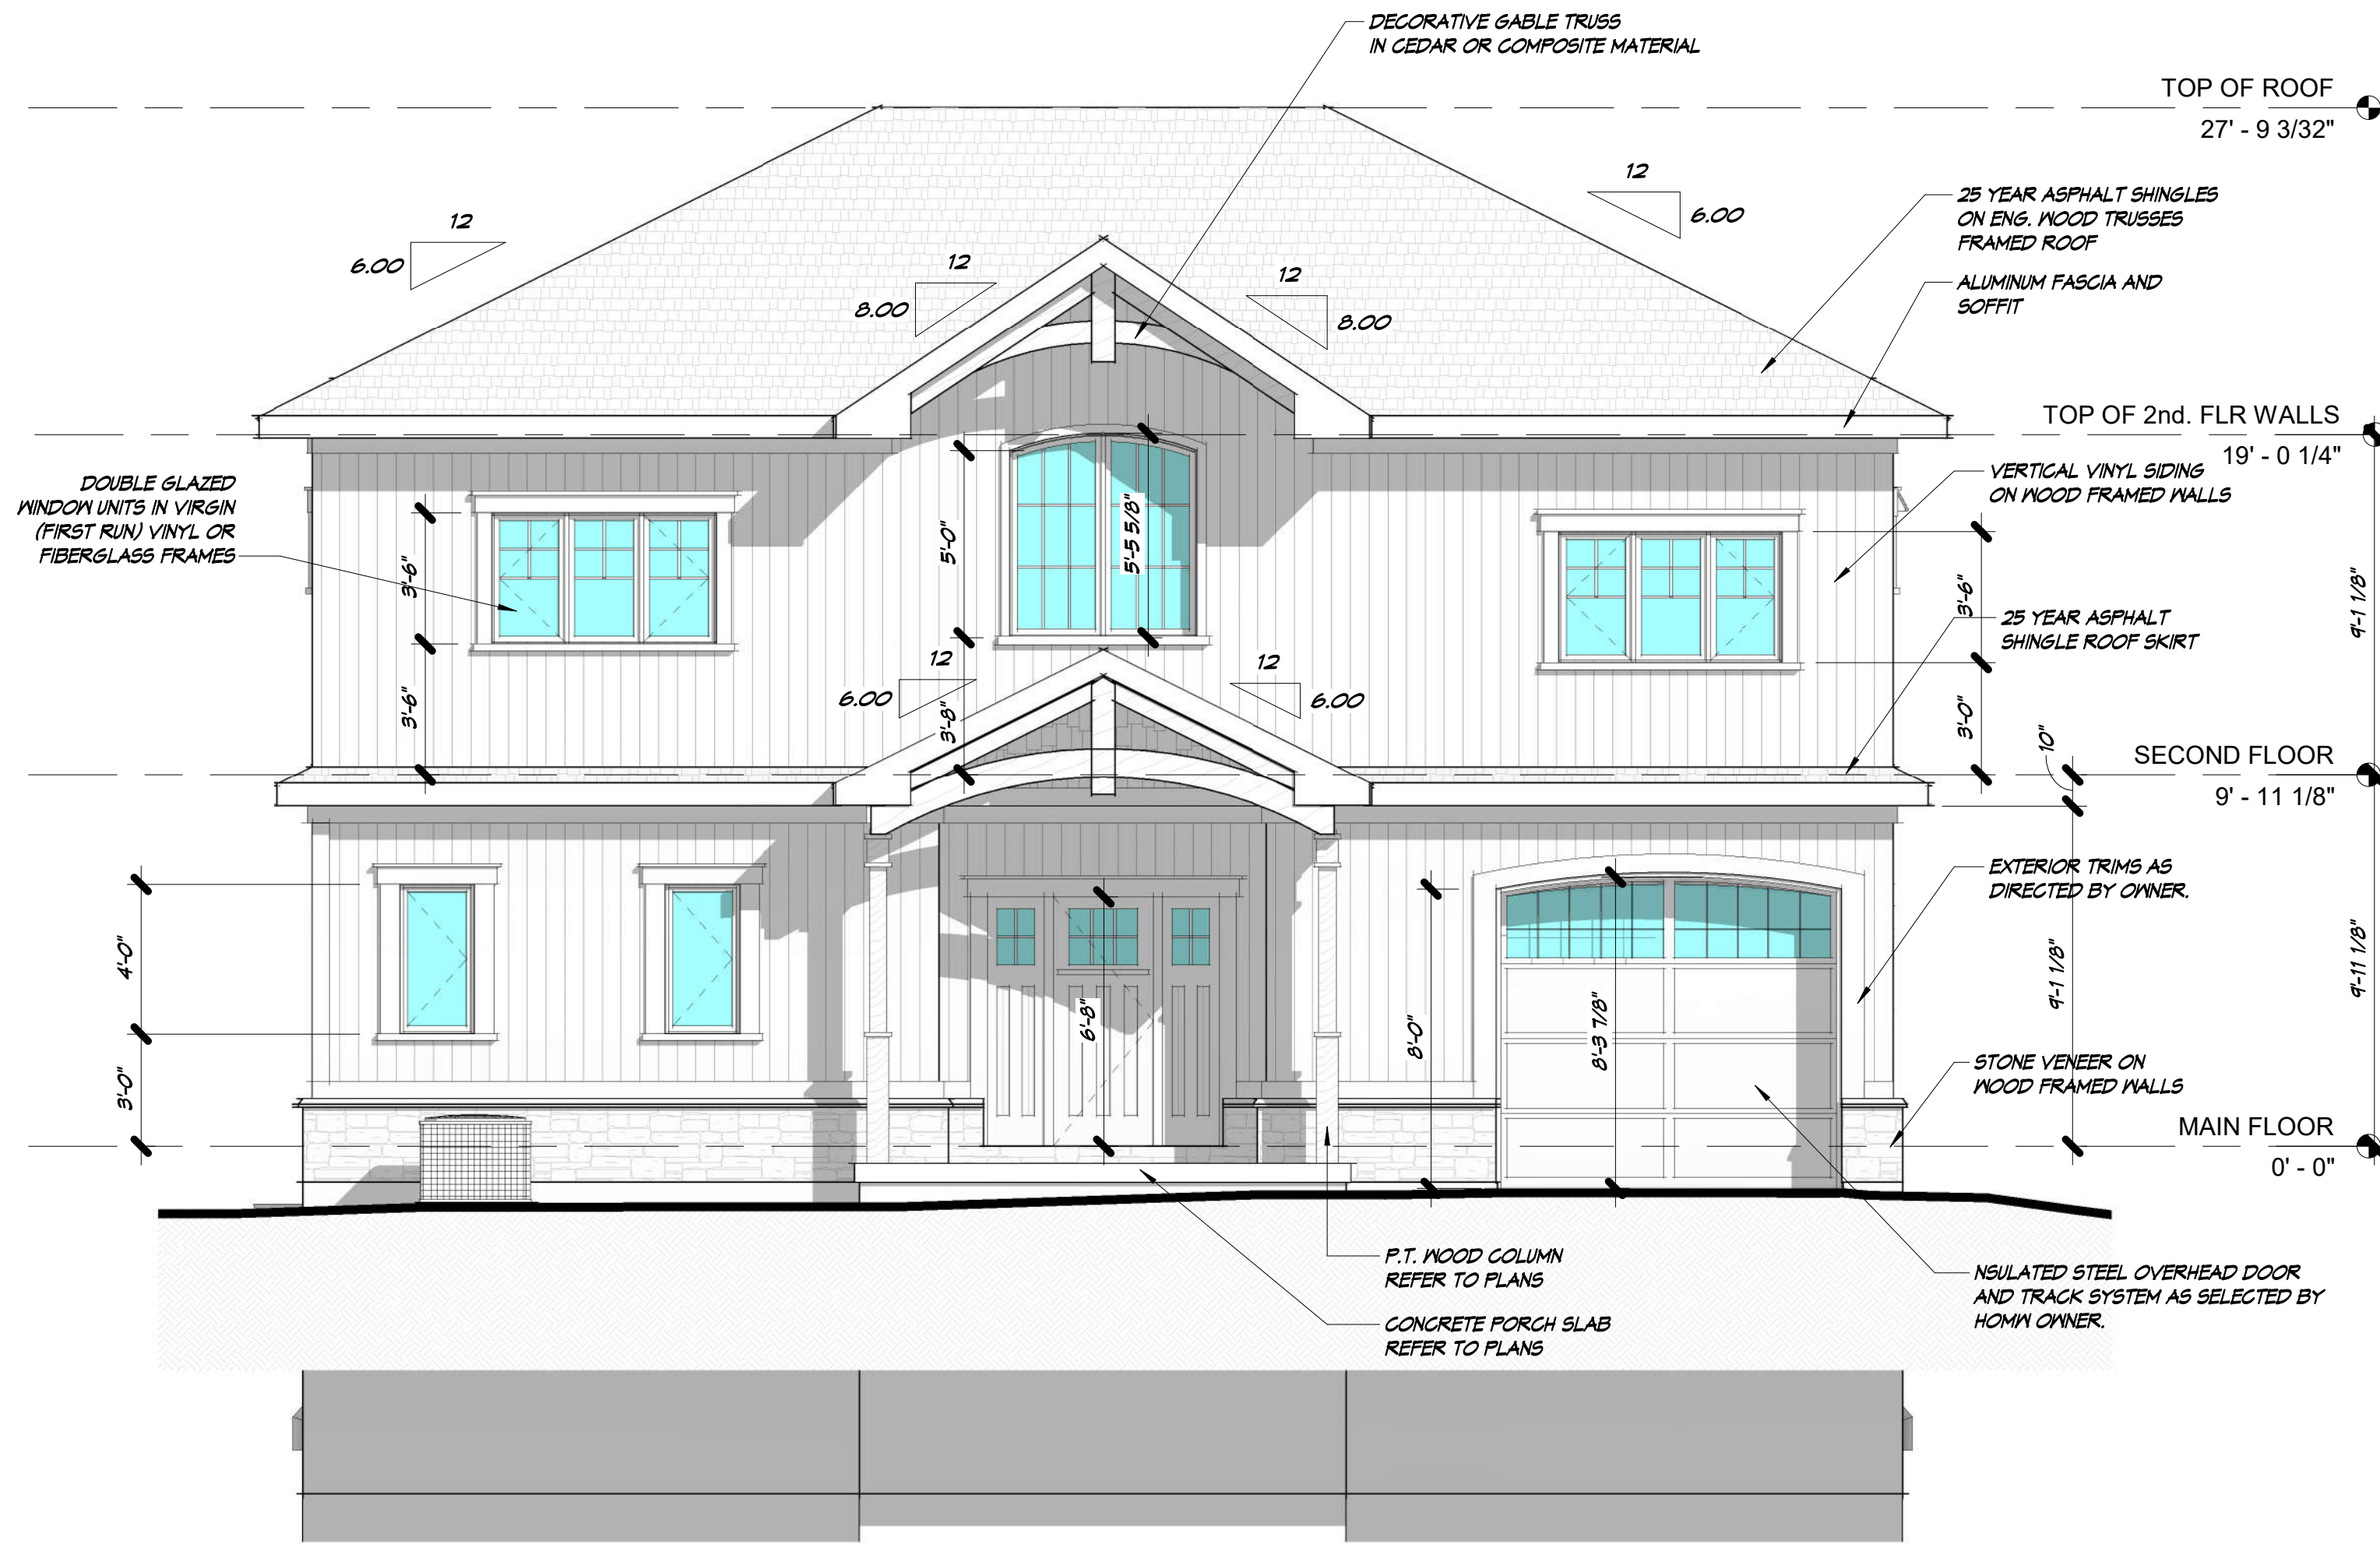

2 NORTH ELEVATION - PROPOSED  
A4 SCALE: 1/4" = 1'-0"

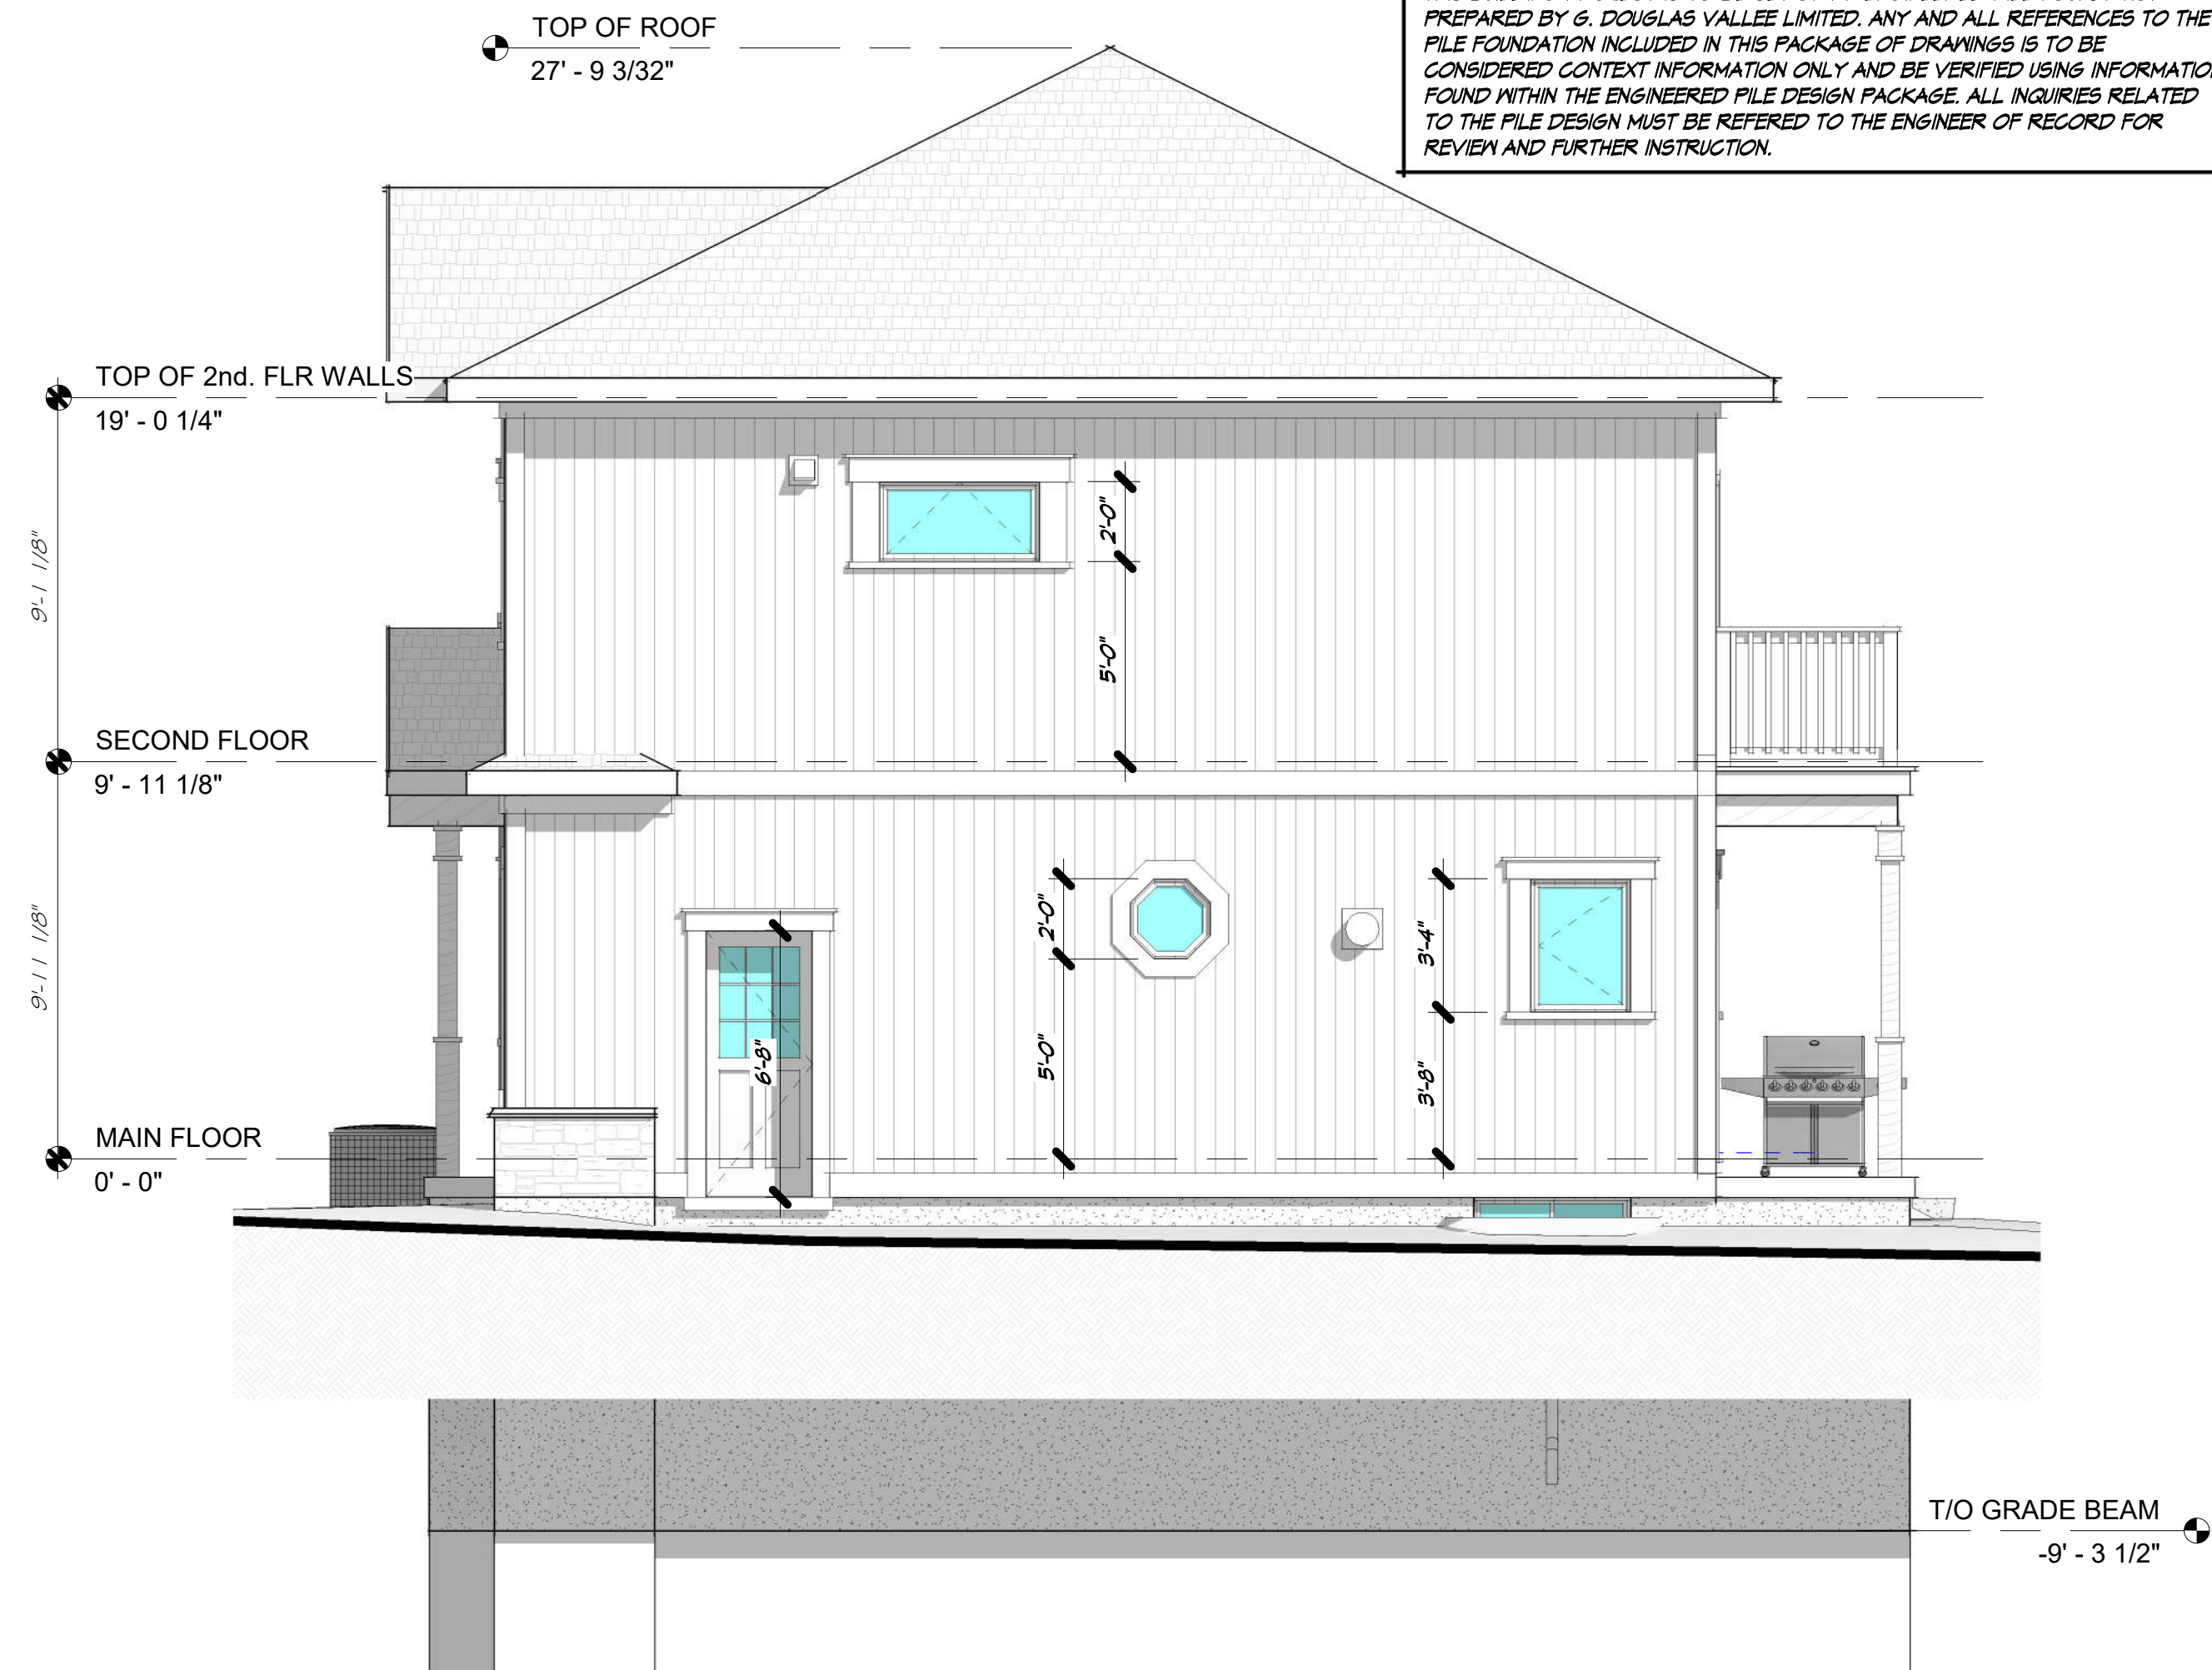

1 EAST ELEVATION - PROPOSED  
A4 SCALE: 1/4" = 1'-0"

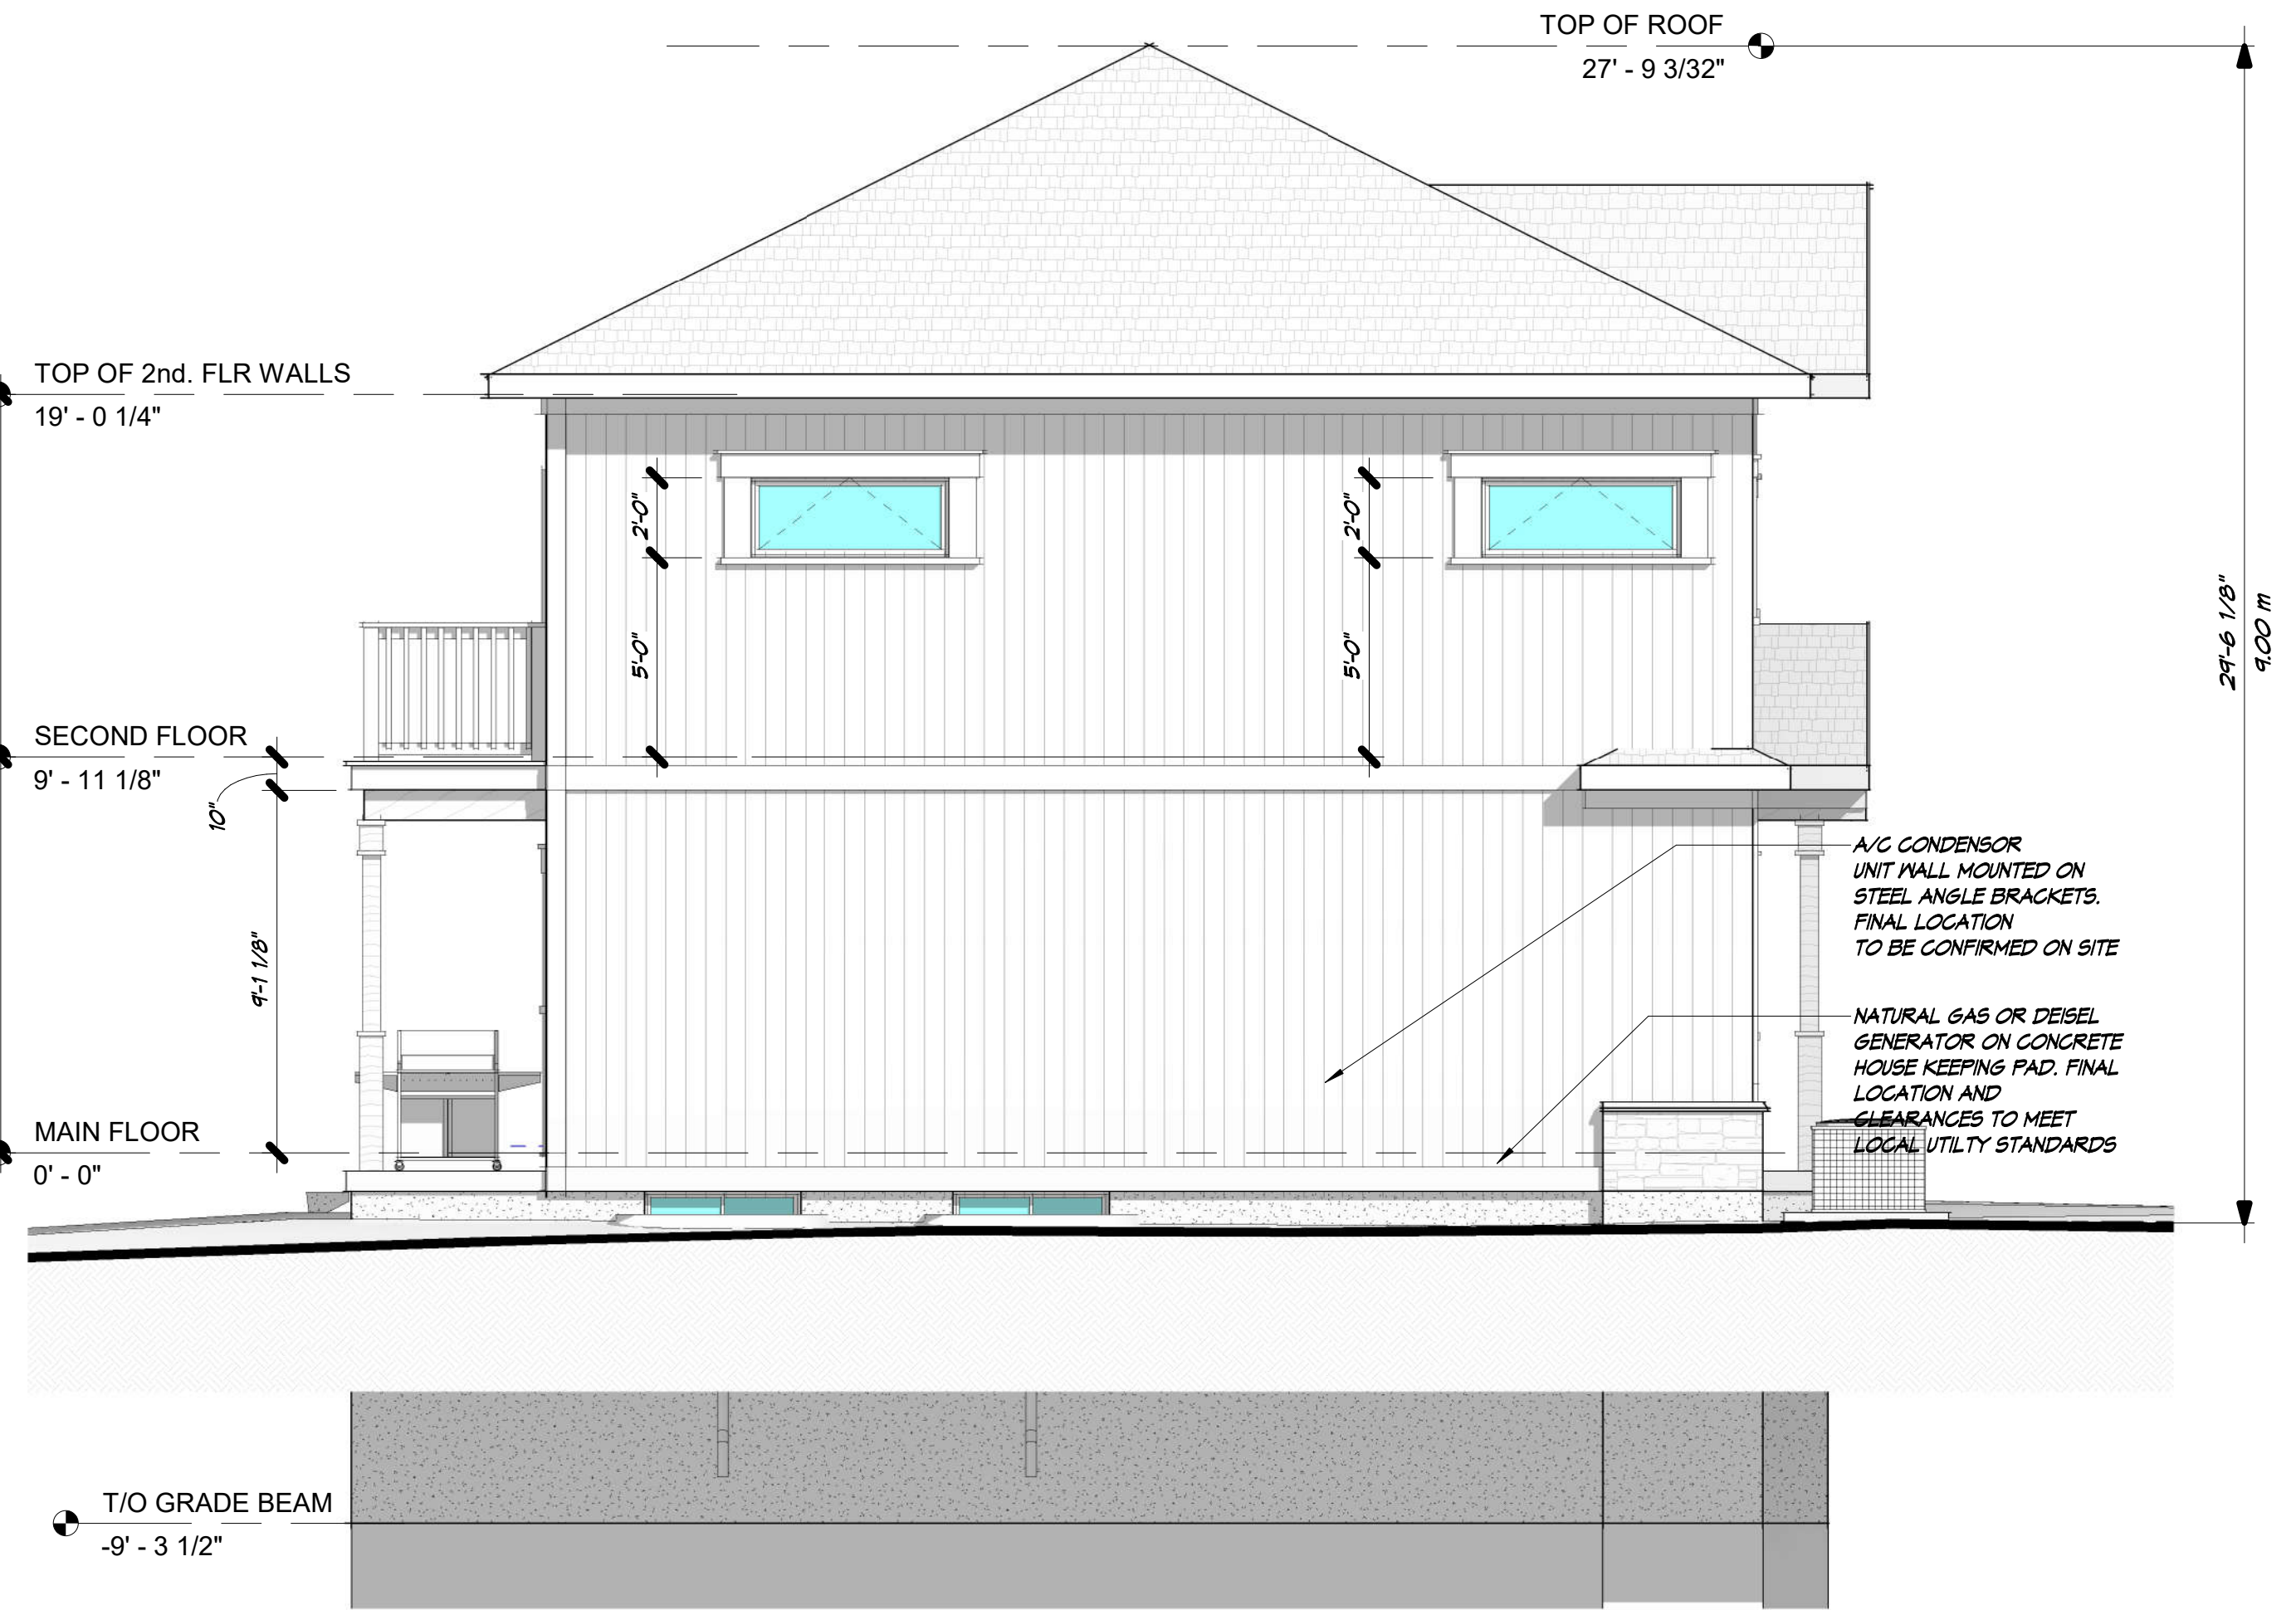

3 WEST ELEVATION - PROPOSED  
A4 SCALE: 1/4" = 1'-0"



4 SOUTH ELEVATION - PROPOSED  
A4 SCALE: 1/4" = 1'-0"

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No. REVISION		DATE

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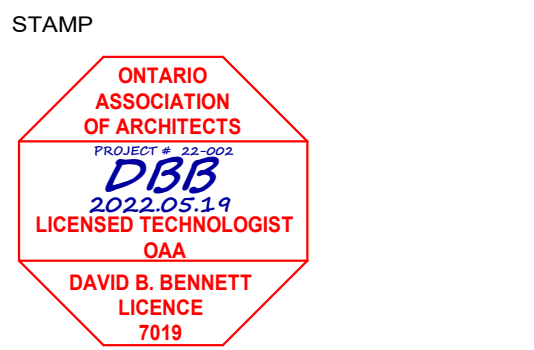
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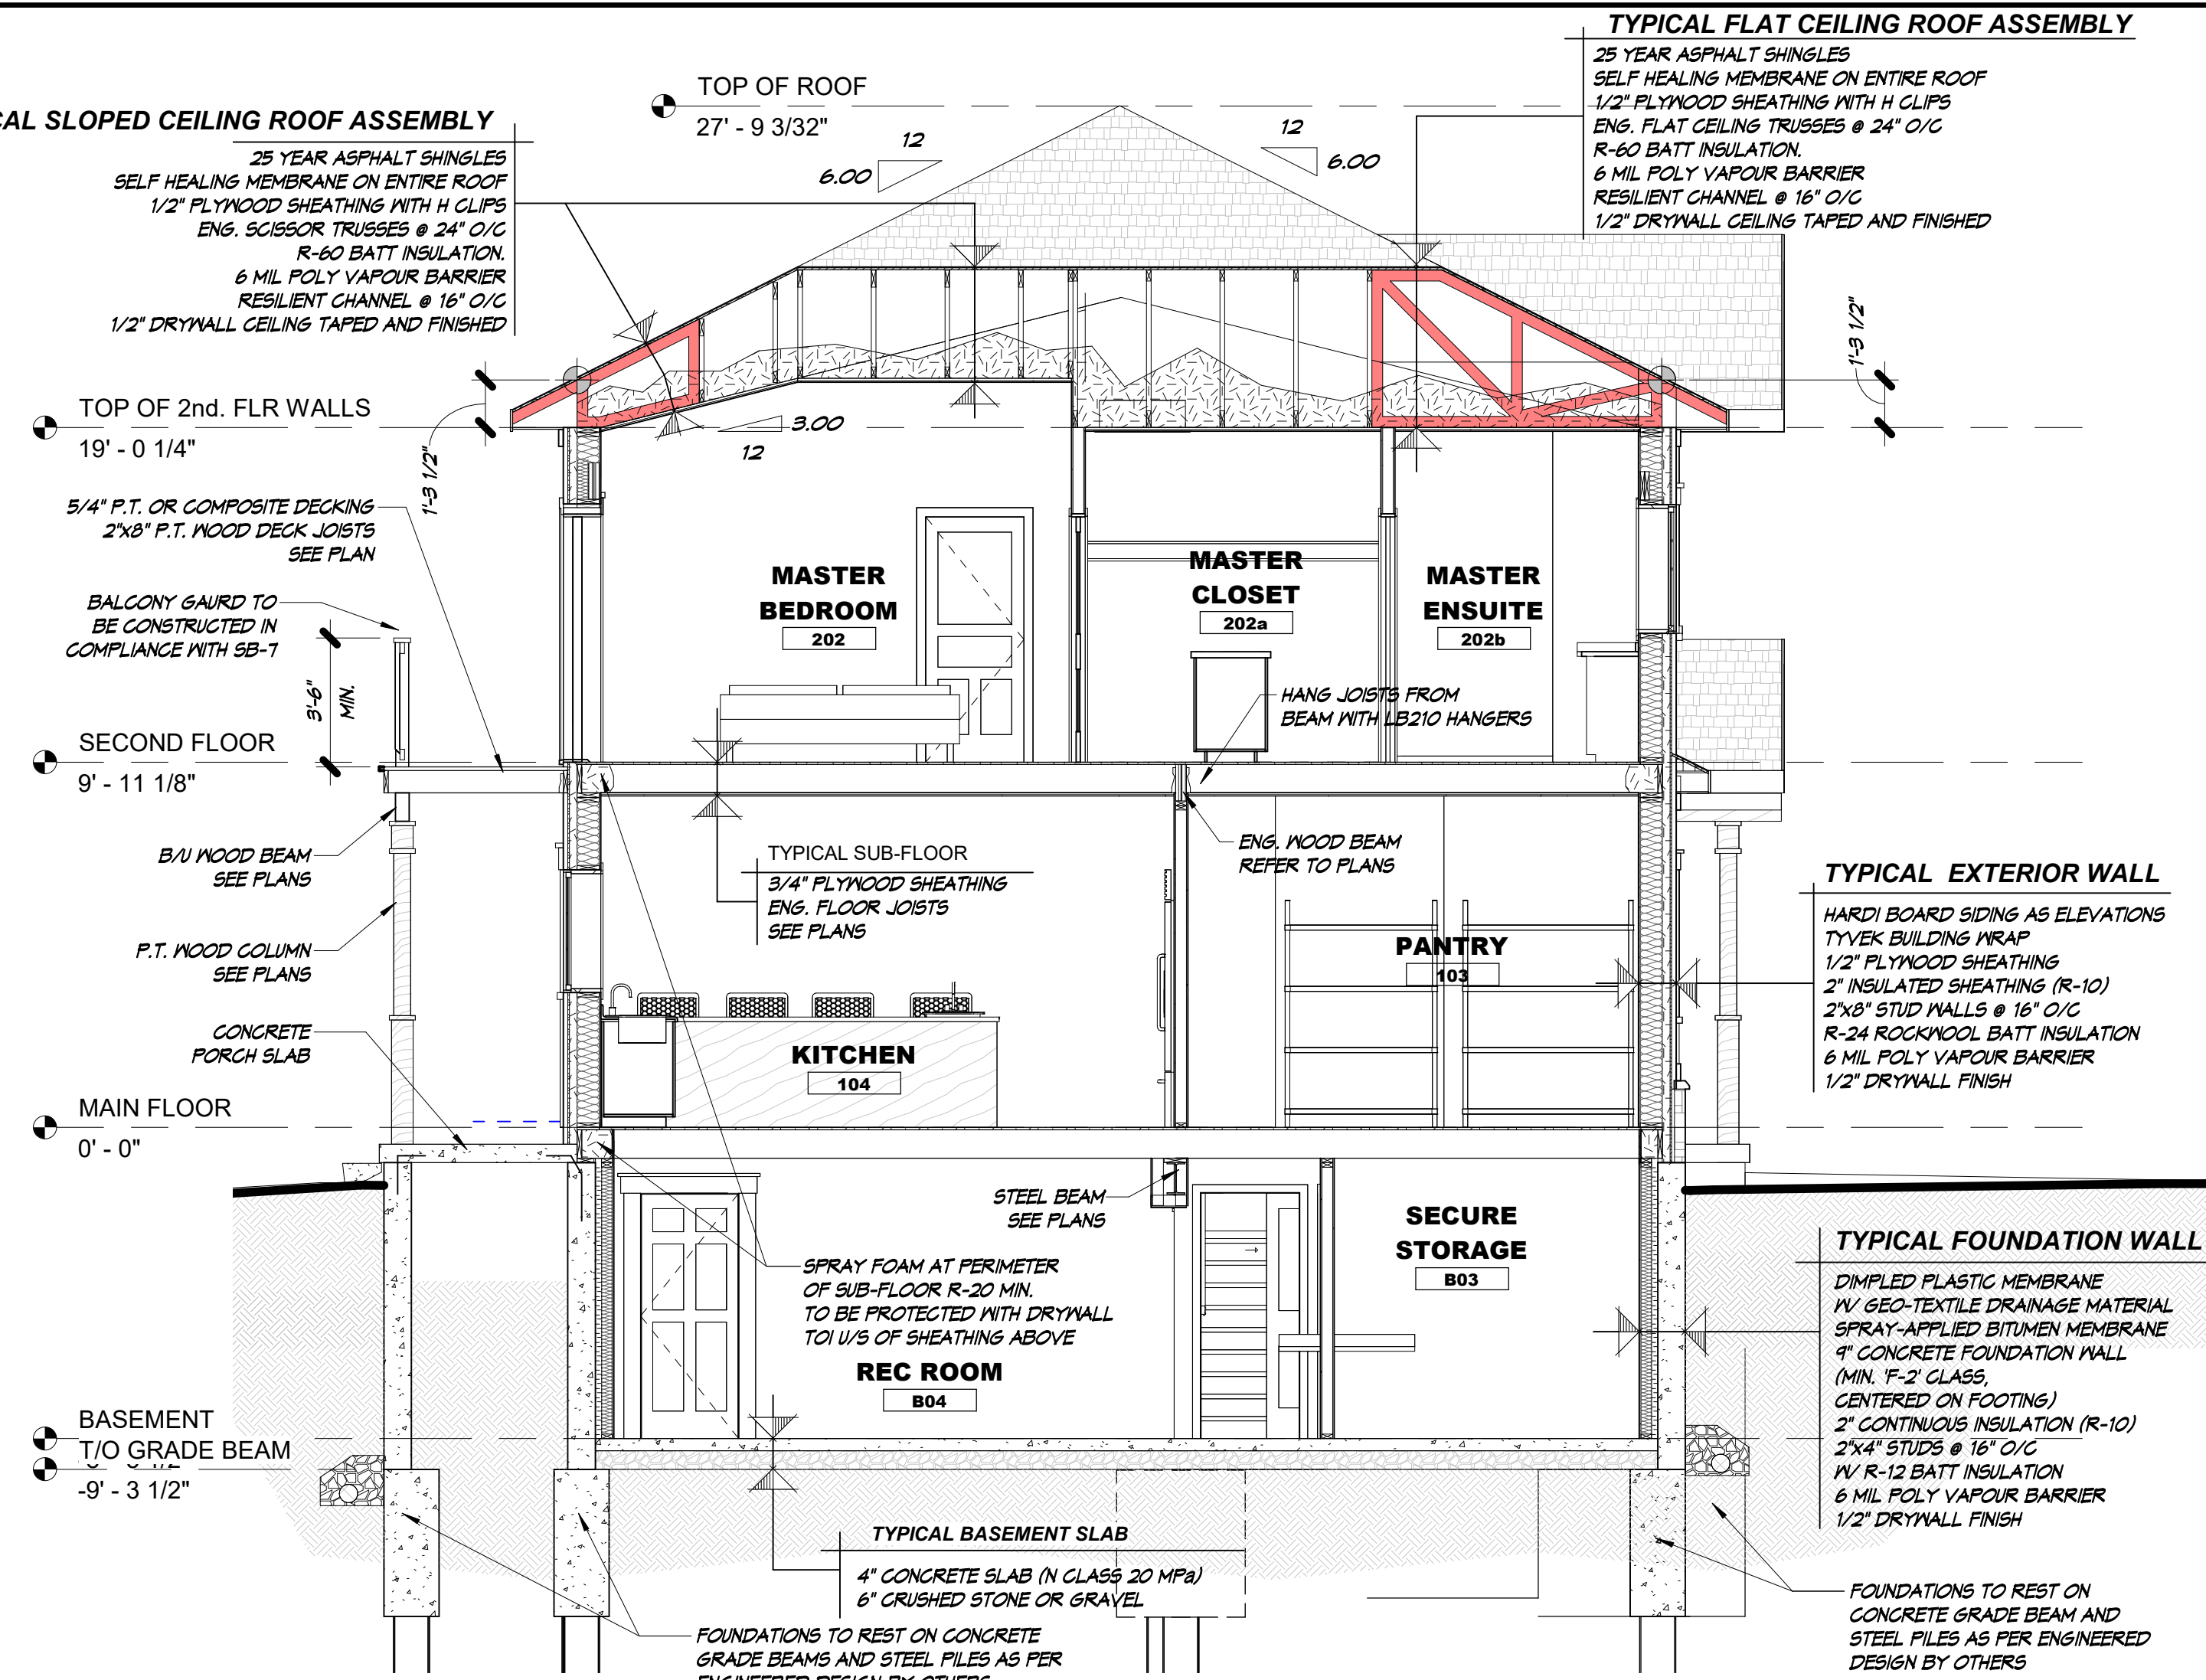
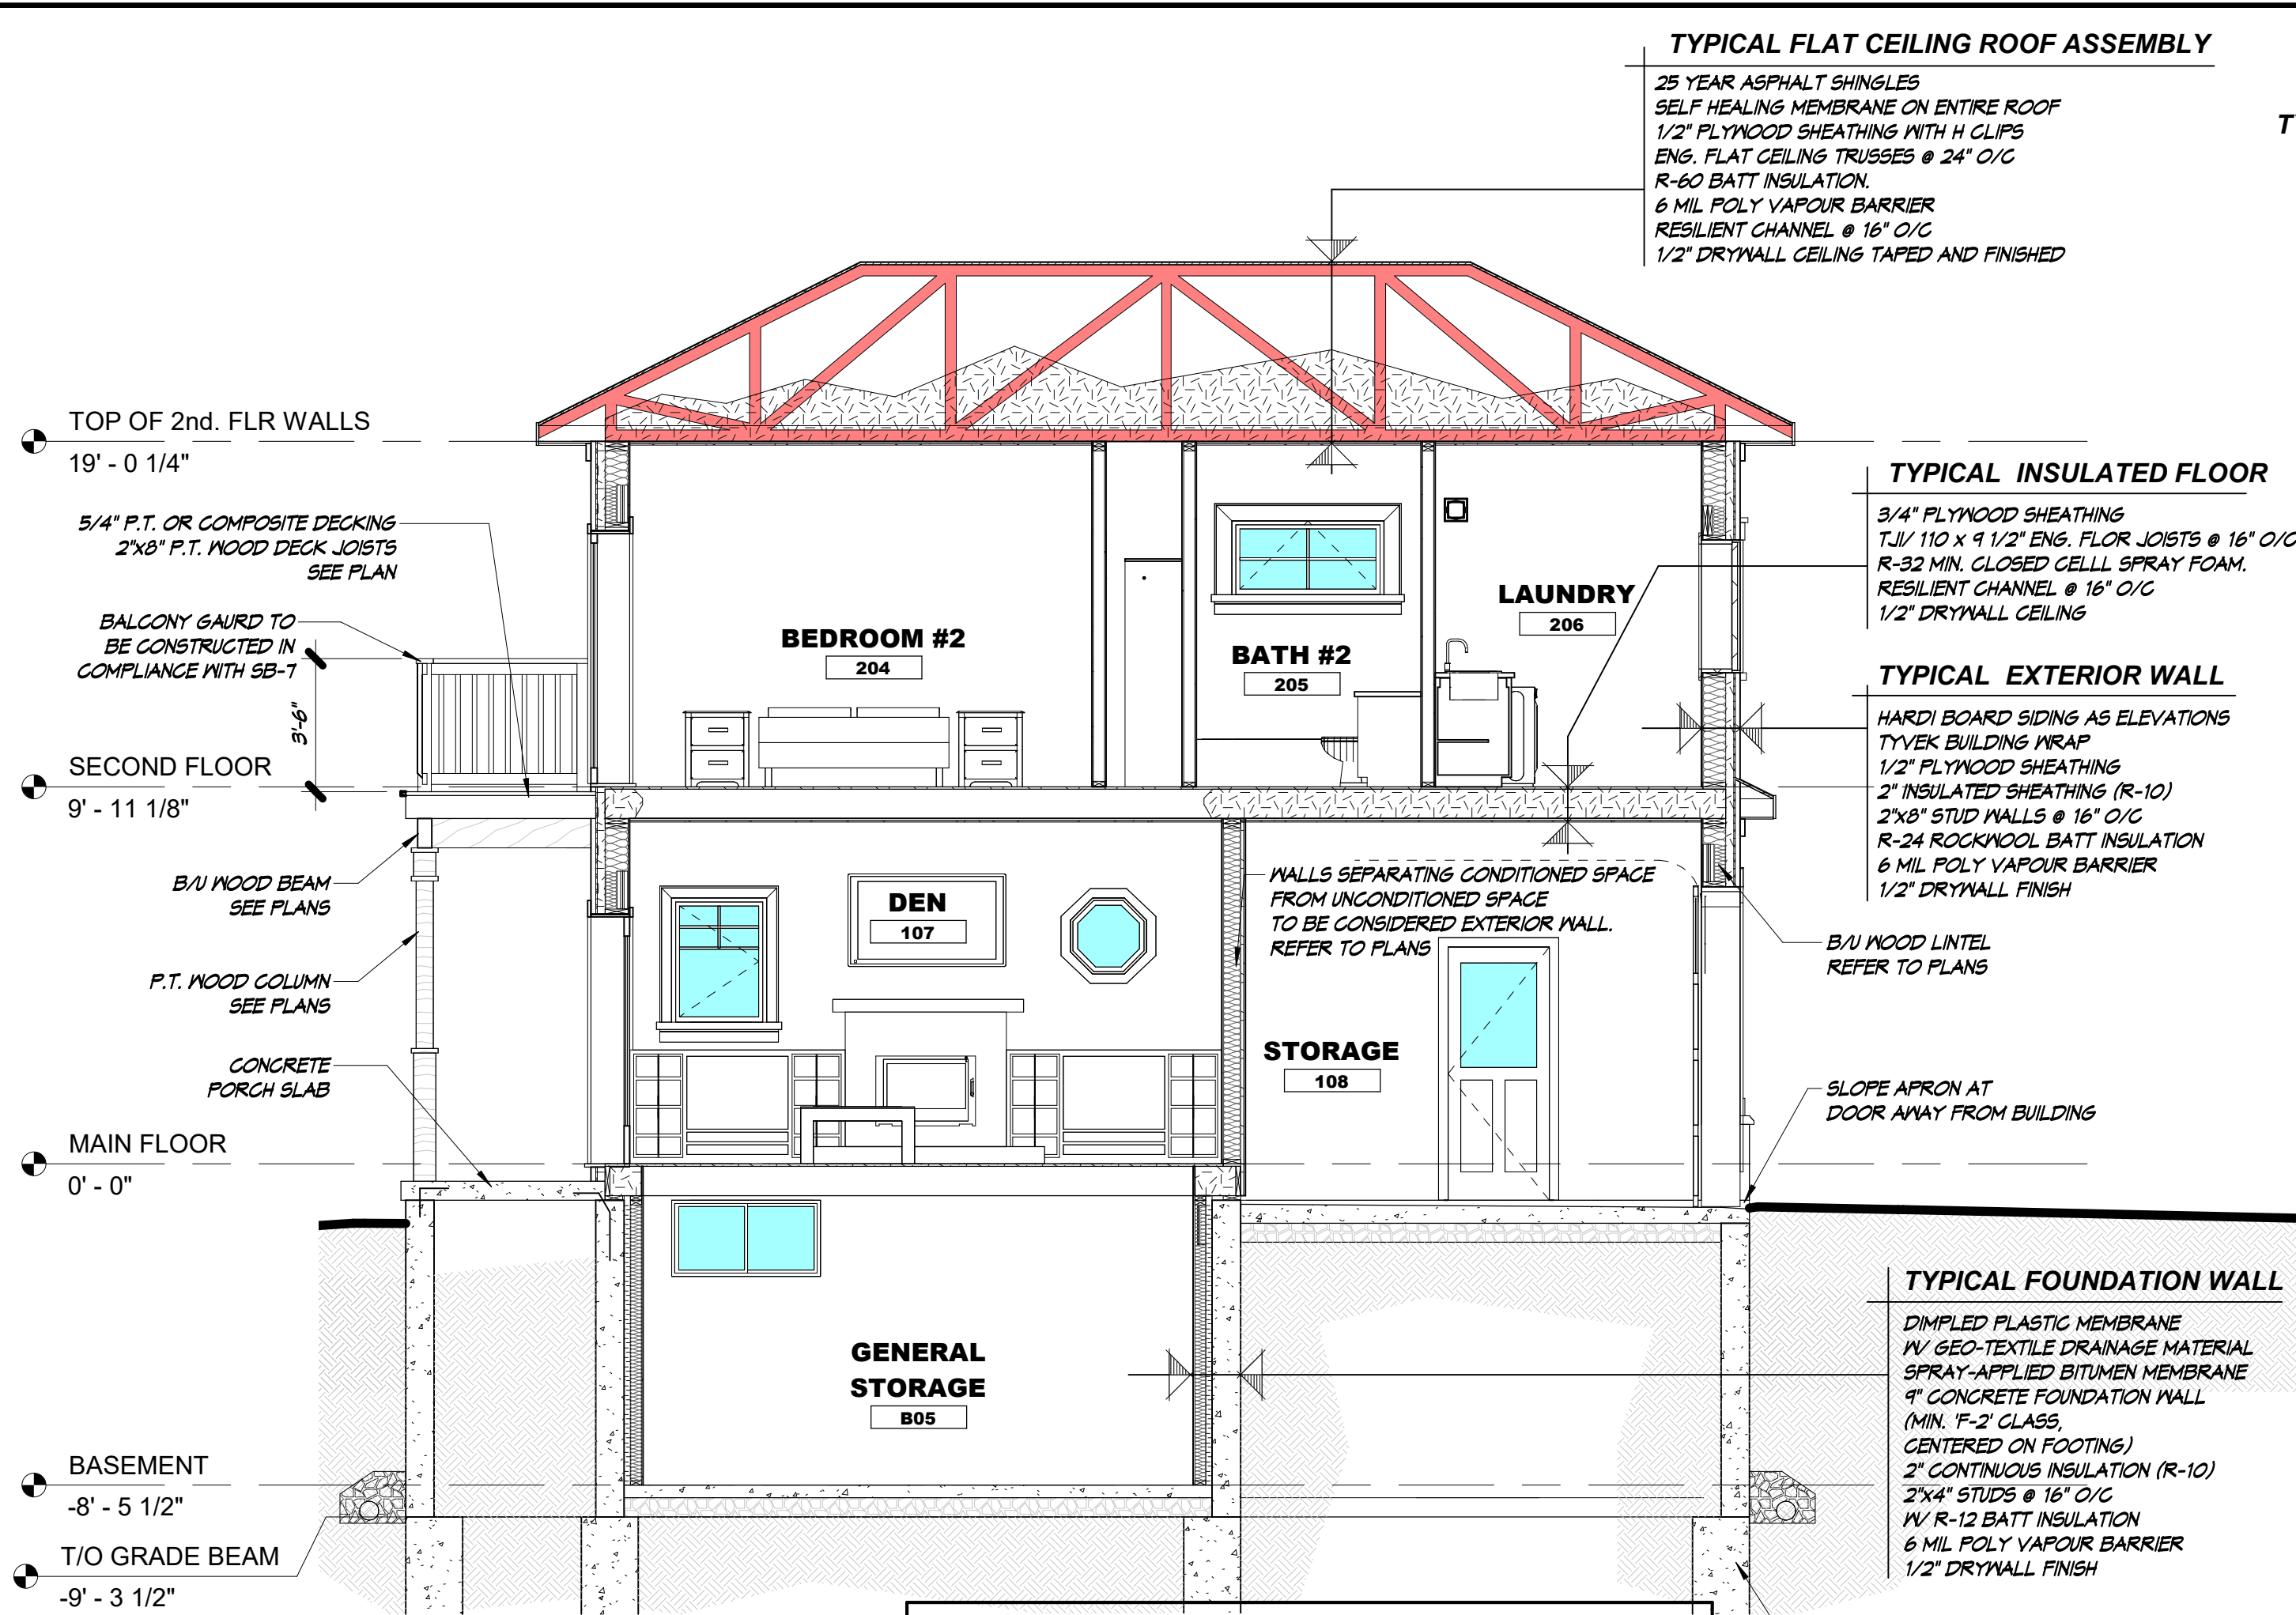
22 Walpole Drive Jarvis Ontario N0A 1J0  
Telephone : (519) 909-8246  
Email: Dave@engageddesign.ca  
Web Site: www.engageddesign.ca

PROJECT  
NEW COTTAGE  
For : Irene & Jeff Sidway  
13 LAKESIDE LANE  
PORT DOVER, ONTARIO  
NORFOLK COUNTY

Drawing Title  
BUILDING ELEVATIONS


Drawn By: D.BENNETT	Date: MARCH 2021
Designed By: D.B.	Drawing No.
Checked By: D.B.	
Project No. 21-005	A4






1 SECTION THRU SECOND BEDROOM  
A5 SCALE: 1/4" = 1'-0"

2 SECTION THRU MASTER BEDROOM  
A5 SCALE: 1/4" = 1'-0"

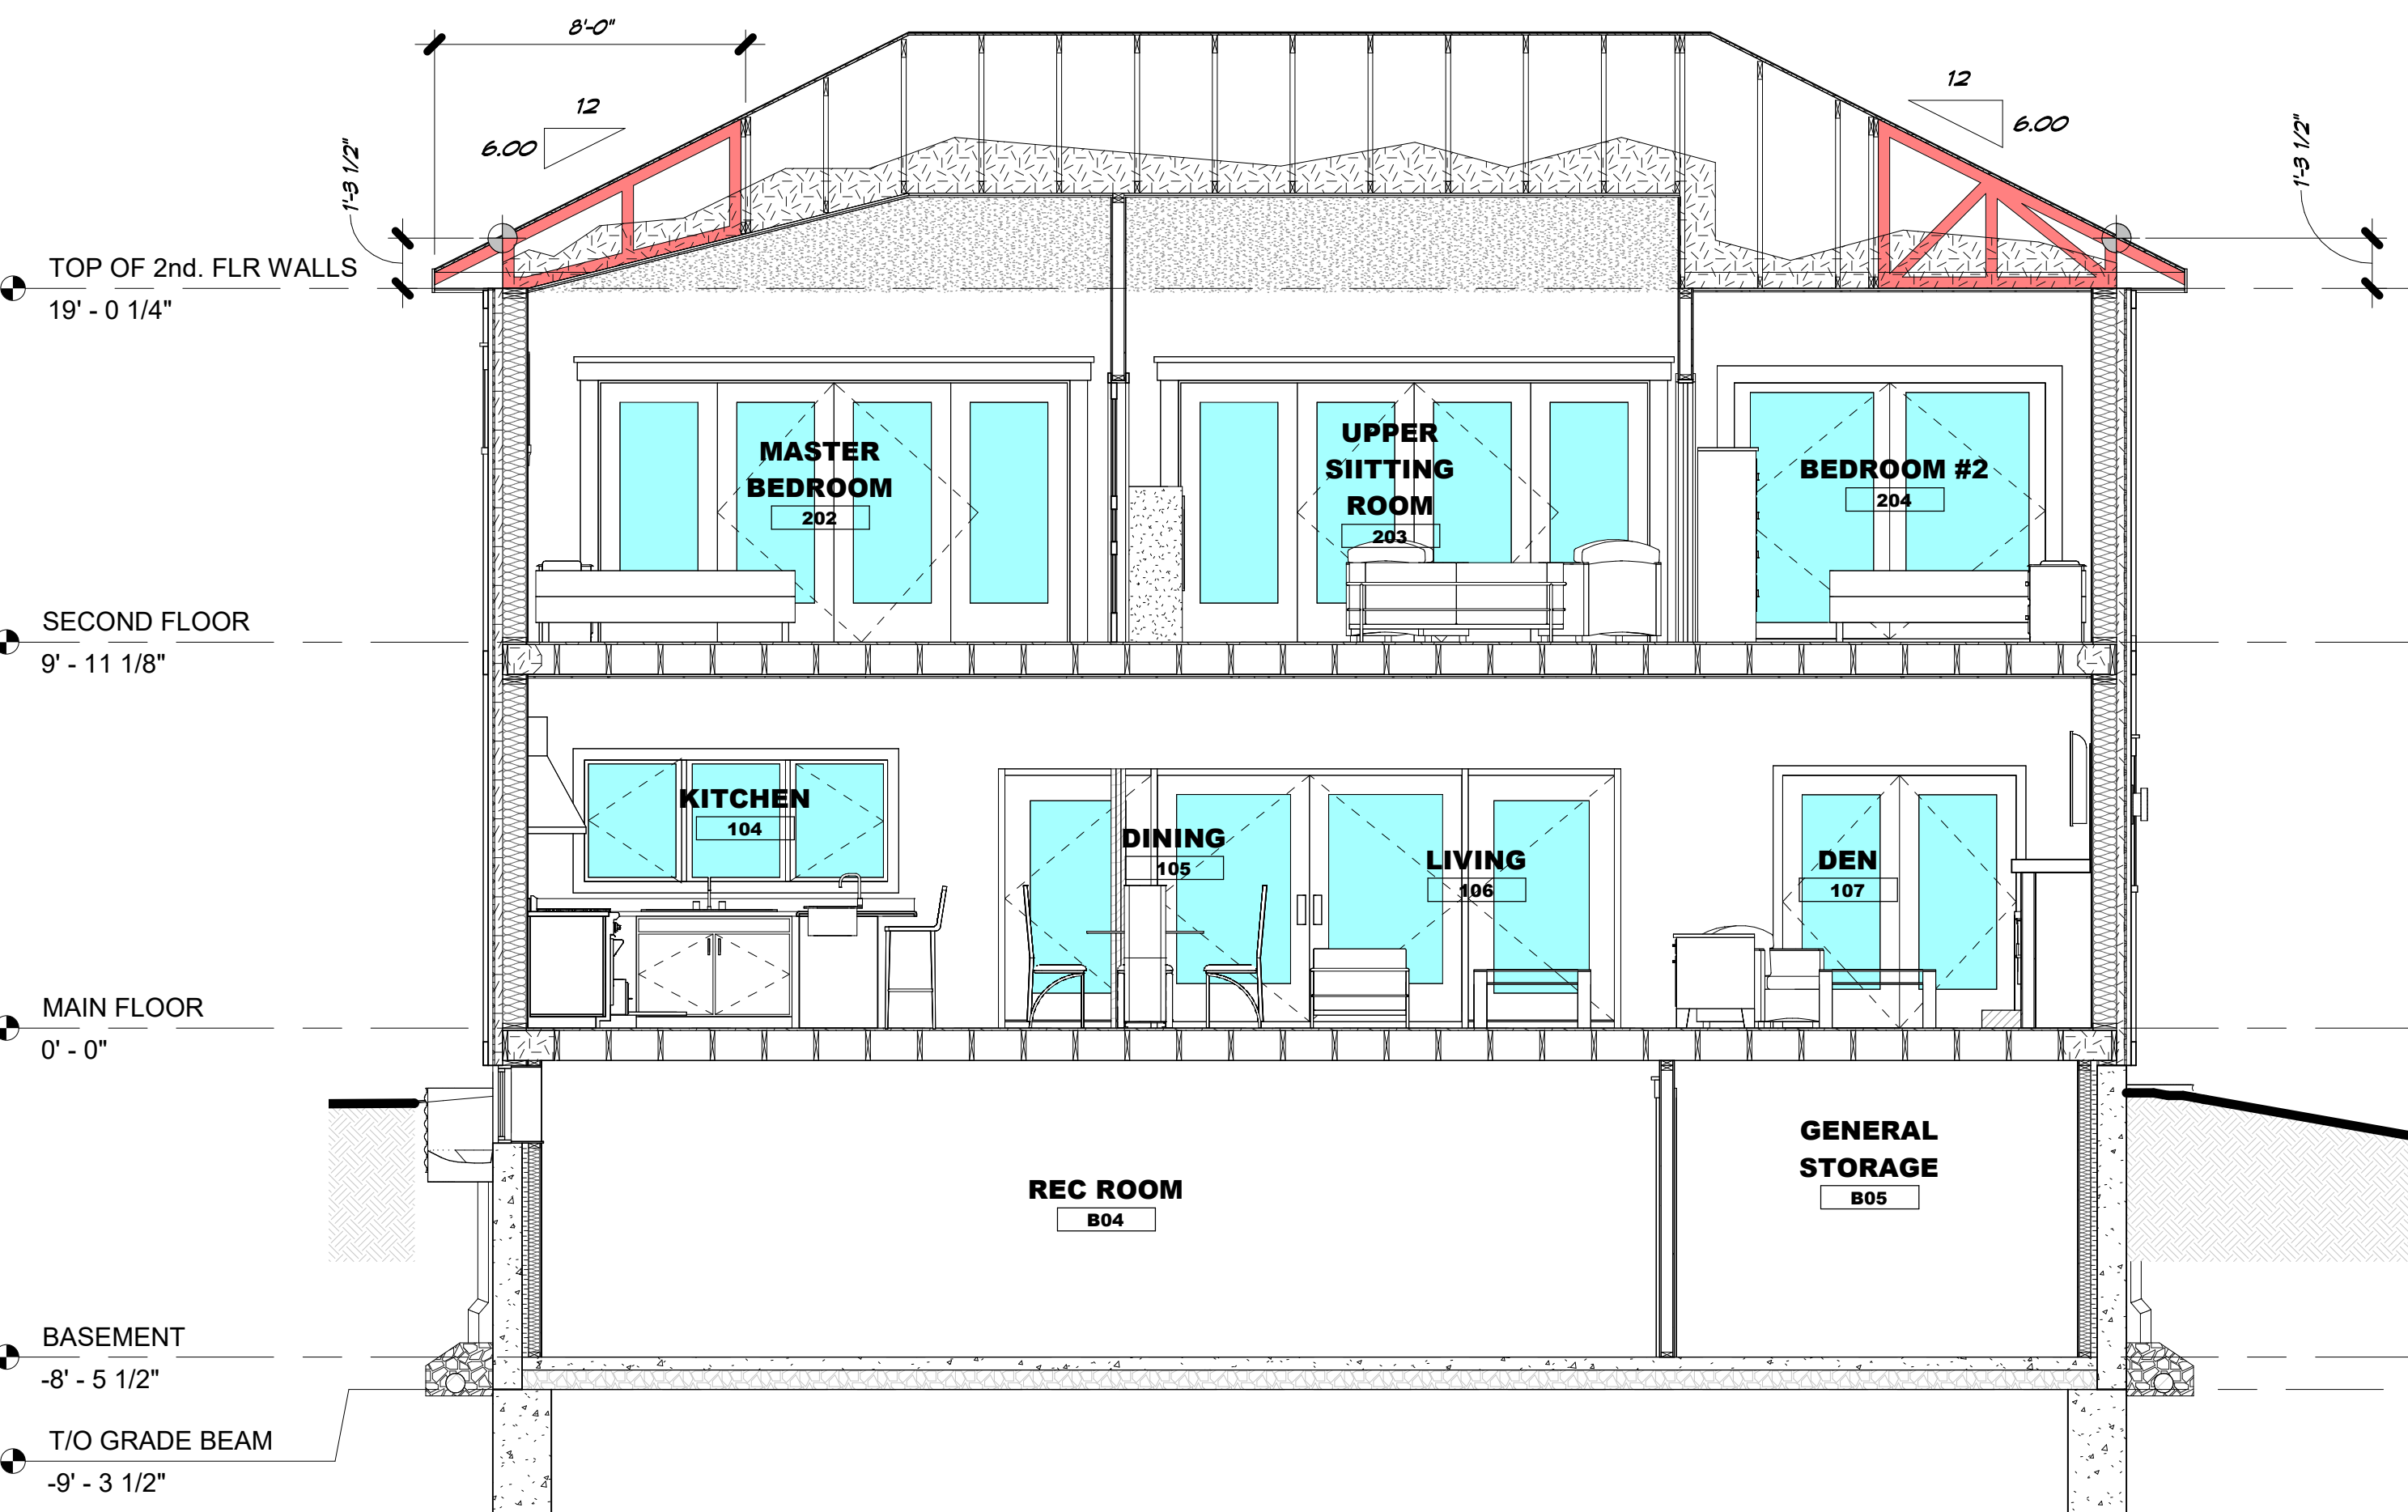

3 LONGITUDINAL SECTION  
A5 SCALE: 1/4" = 1'-0"

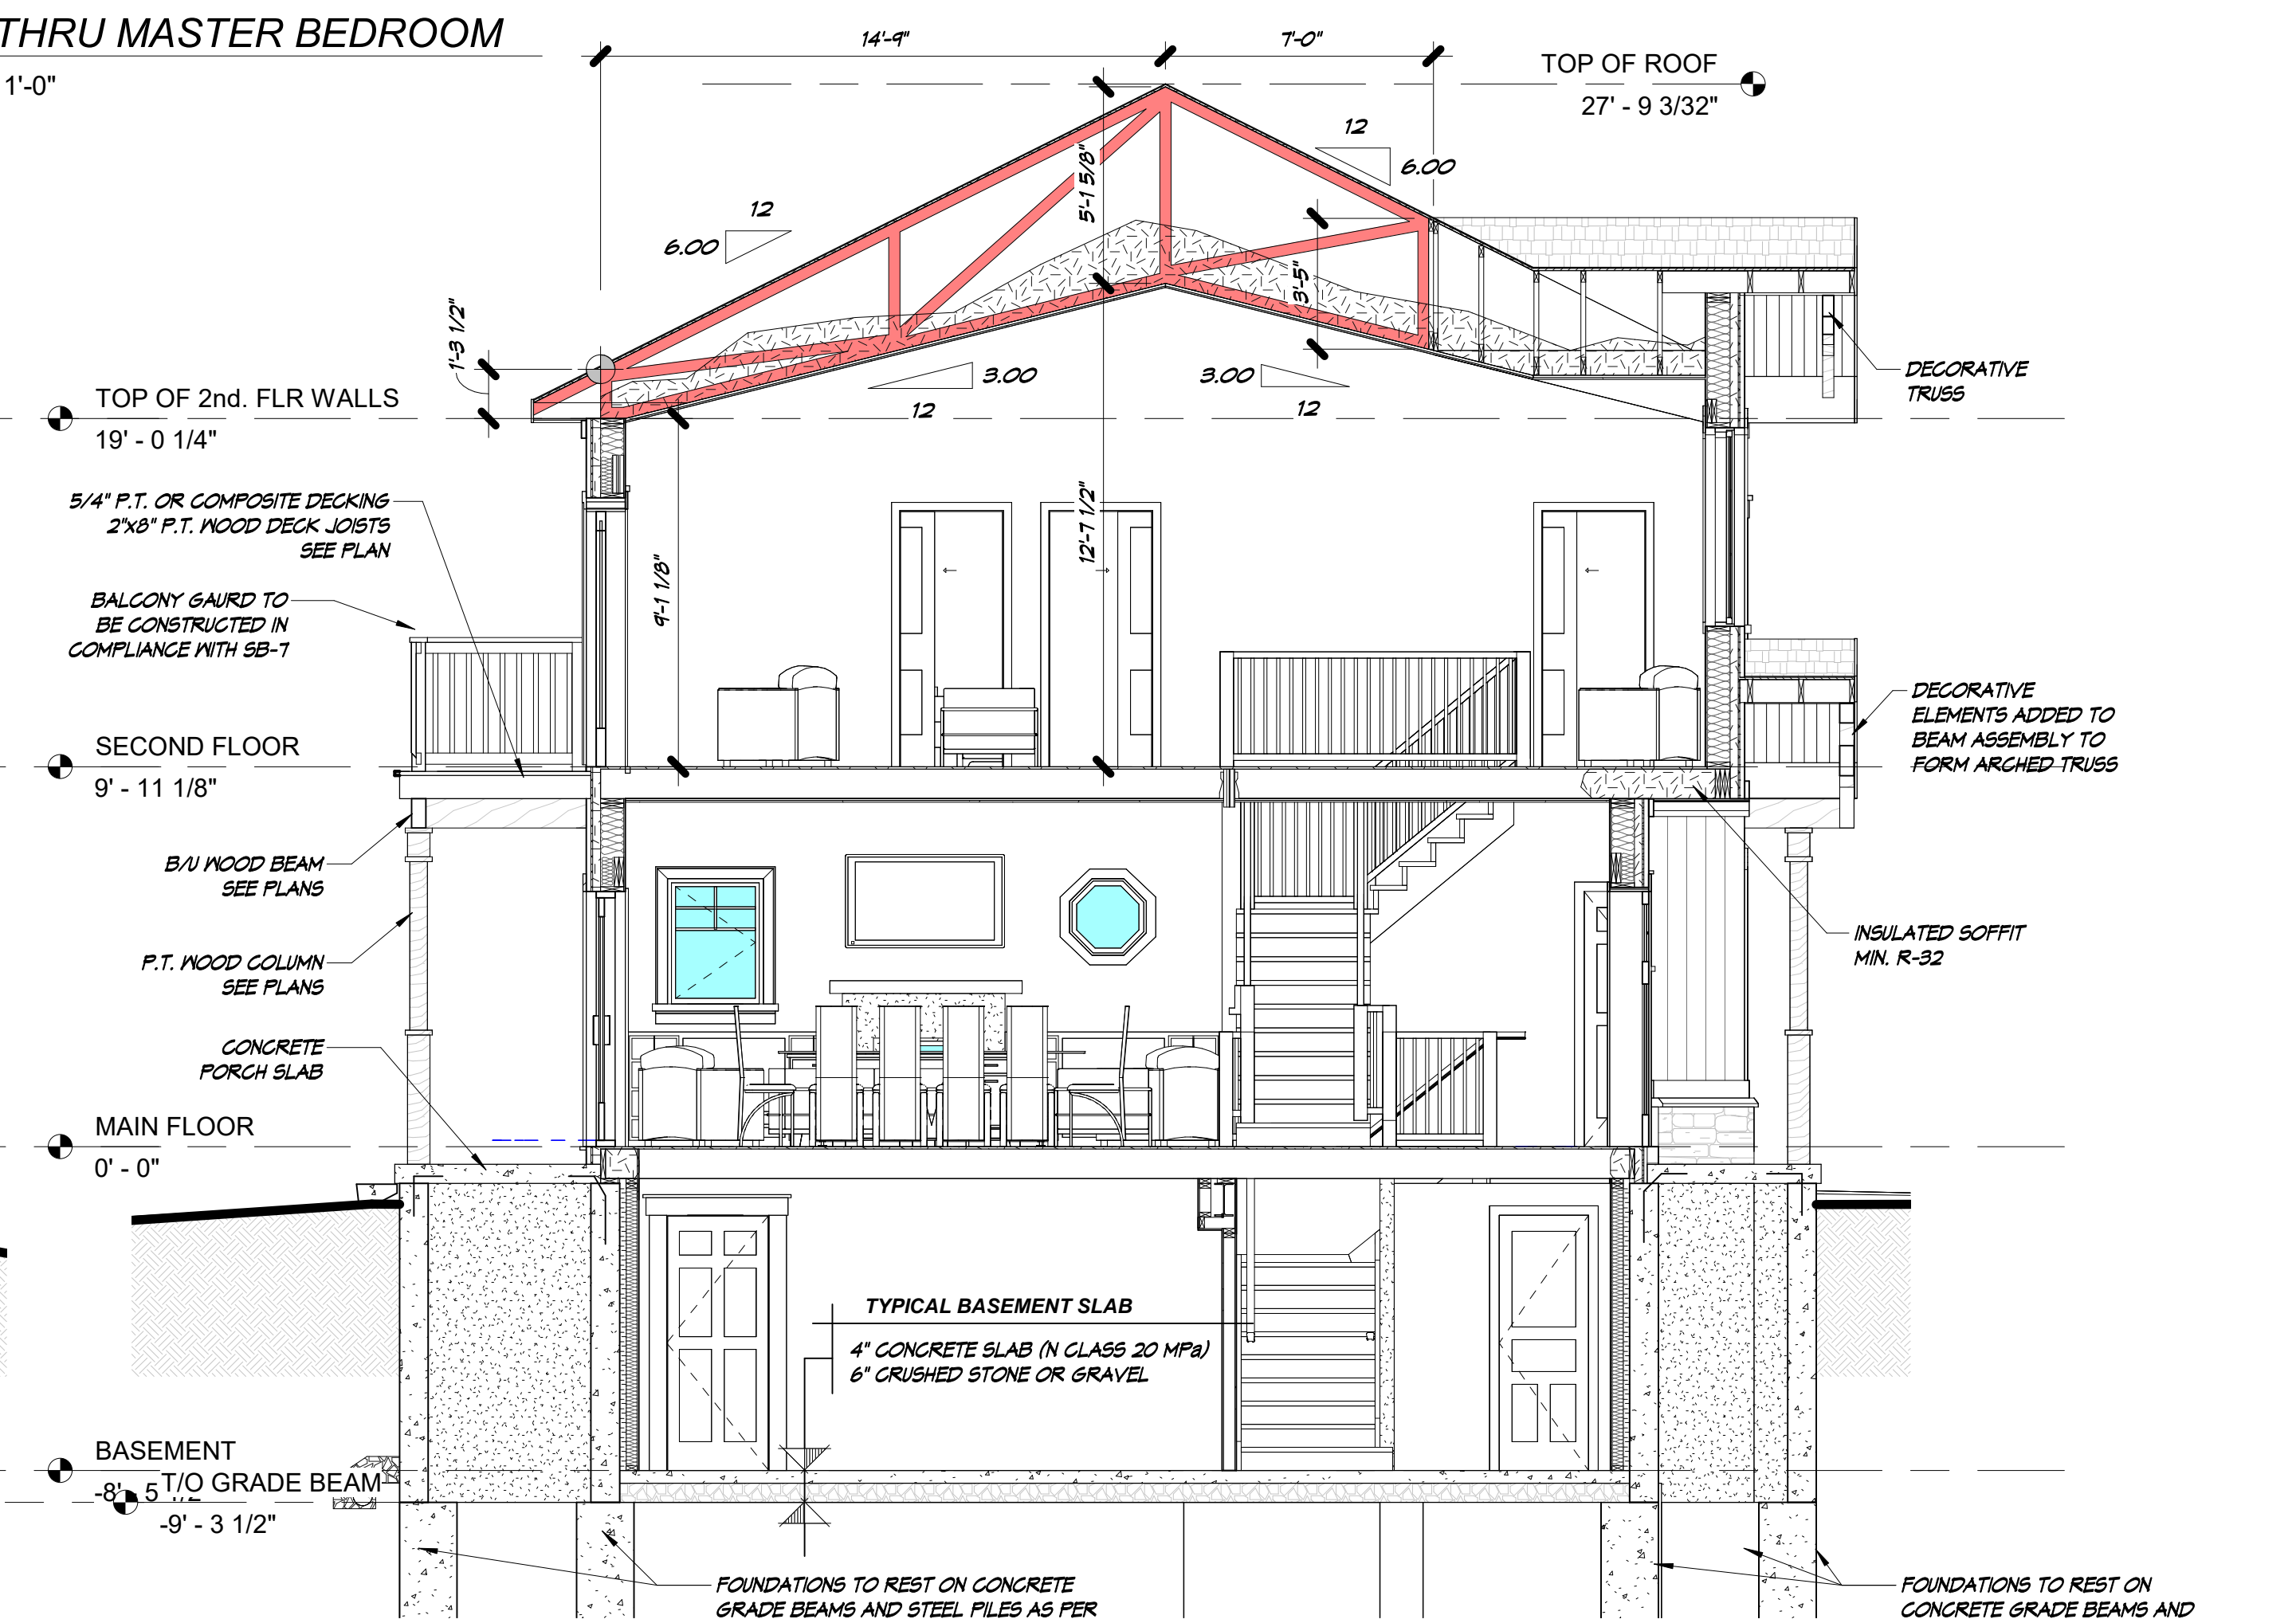

4 SECTION THRU LIVING ROOM / ENTRY  
A5 SCALE: 1/4" = 1'-0"

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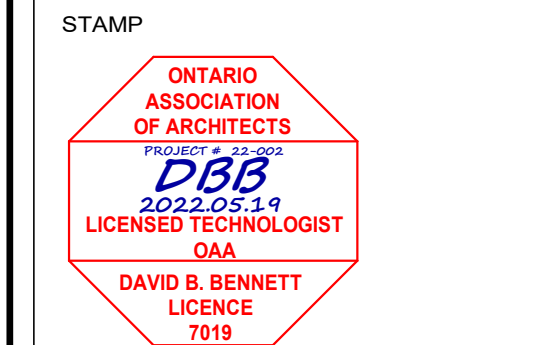
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ALL MISSING OR UNCLEAR INFORMATION MUST BE REPORTED TO THE DESIGNER IMMEDIATELY FOR FURTHER INSTRUCTION.

All construction shall be carried out in accordance with these drawings.

Any deviations, alterations or changes from the design intent shall be reported by the contractor to the designer prior to implementation of the change. The requested change shall then be reviewed by the designer who will in turn issue additional documentation supporting the change to the building department and owner for approval. Only after the contractor has received approval from the building department regarding said change may construction of the affected area continue. Changes involving adjustments in construction cost must be approved by the owner prior to implementation.

**ISSUED FOR BUILDING PERMIT APPLICATION**  
MAY 19, 2022



**Engaged**  
Custom Home Design

**David B. Bennett**  
Licensed Technologist OAA  
O.B.C. Qualified Design; Small Buildings

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Web Site: www.engageddesign.ca

PROJECT  
NEW COTTAGE  
For : Irene & Jeff Sidway  
13 LAKESIDE LANE  
PORT DOVER, ONTARIO  
NORFOLK COUNTY

Drawing Title  
BUILDING SECTIONS

Drawn By: D. BENNETT  
Designed By: D.B.  
Checked By: D.B.  
Project No.: 21-005

Date: MARCH 2021  
Drawing No.:  
A5



GENERAL STRUCTURAL NOTES

1. THIS DESIGN HAS BEEN PREPARED IN ACCORDANCE WITH THE REQUIREMENTS OF THE ONTARIO BUILDING CODE LATEST EDITION.
2. ALL PRE-ENGINEERED, PREFABRICATED BUILDING SYSTEMS AND COMPONENTS SHALL BE DESIGNED BY P.E.N.S. (P.E.D.) AND CONFIRMED SHOP DRAWINGS TO BE SUBMITTED TO CONSULTANT FOR REVIEW. THE CONSULTANT SHALL NOT ASSUME RESPONSIBILITY FOR SUCH COMPONENTS OR SYSTEMS THAT ARE DESIGNED BY OTHERS.
3. UNLESS SPECIFICALLY NOTED OTHERWISE ON THE DRAWINGS, NO PROVISIONS HAVE BEEN MADE IN THE DESIGN FOR TEMPORARY CONDITIONS OCCURRING DURING CONSTRUCTION. THE CONTRACTOR SHALL PROVIDE ALL NECESSARY BRACING AND SHORING REQUIRED FOR THE STRESSES & INSTABILITY OCCURRING FROM ANY CAUSE DURING CONSTRUCTION. THE CONTRACTOR SHALL ACCEPT ALL RESPONSIBILITY FOR ALL SUCH MEASURES. IT SHALL ALSO BE THE RESPONSIBILITY OF THE CONTRACTOR TO PROVIDE ALL NECESSARY BRACING, SHORING, SHEET PILING OR STRUCTURES AFFECTED BY THIS WORK.
4. REFER TO PROJECT SPECIFICATIONS FOR FURTHER DETAIL ON ALL ASPECTS OF CONSTRUCTION.
5. DIMENSIONS PROVIDED ON DRAWINGS MUST BE CHECKED AND VERIFIED WITH ALL OTHER DRAWINGS. WHERE DISCREPANCIES ARE DISCOVERED, THESE SHALL BE REPORTED TO THE PROJECT CONSULTANT FOR RESOLUTION PRIOR TO PROCEEDING WITH THE AFFECTED WORK.
6. THESE DRAWINGS ARE TO BE COORDINATED AND READ IN CONJUNCTION WITH THE ARCHITECTURAL, MECHANICAL AND ELECTRICAL DRAWINGS.
7. ALL WORK IS TO BE PERFORMED IN ACCORDANCE WITH THE OCCUPATIONAL HEALTH AND SAFETY ACT AND REGULATIONS FOR CONSTRUCTION PROJECTS - O. REG. 213.
8. WHERE THERE IS A CONFLICT IN THE SPECIFICATIONS AND/OR DRAWINGS THE MORE STRINGENT SHALL APPLY UNLESS APPROVED OTHERWISE IN WRITING BY THE PROJECT ENGINEER.
9. DO NOT SCALE THE DRAWINGS.

DESIGN LOADS

1. LOCATION
- NANTICOKE (PORT DOVER), ONTARIO
2. ROOF DEAD LOAD = 1.0 kPa
3. FLOOR DEAD LOADS:
- MAIN FLOOR DEAD LOAD = 1.0 kPa
- SECOND FLOOR DEAD LOAD = 1.0 kPa
4. LIVE (OCCUPANCY-OBC TABLE 4.1.5.3)

LOCATION SPECIFIED LOAD (kPa)

ROOF 1.0

BASEMENT (RESIDENTIAL)

MAIN FLOOR (RESIDENTIAL) 1.9

SECOND FLOOR (RESIDENTIAL) 1.9

5. SNOW (OBC CL. 4.1.6)

S<sub>s</sub> = 0.4kPa

S<sub>g</sub> = 1.2kPa

I<sub>s</sub> = 1.00 (NORMAL)

C<sub>D</sub> = 0.8

C<sub>w</sub> = 1.0

C<sub>S</sub> = 1.0

C<sub>E</sub> = 1.0 FOR FLAT ROOF

S = I<sub>s</sub> [ S<sub>g</sub> (C<sub>D</sub>C<sub>w</sub>C<sub>S</sub>C<sub>E</sub>) + S<sub>f</sub> ] = 1.36 kPa

FOUNDATIONS

1. DEEP FOUNDATION FILES BEARING ON BEDROCK. REFER TO GEOTECHNICAL REPORT PREPARED BY PETO MACGALLUM LTD. (16HFO3T APRIL 2017) PROVIDED.
2. ENGINEER TO BE PRESENT DURING FILE INSTALLATION TO CONFIRM LOCATION AND BEARING ON BEDROCK.
3. ALL FOUNDATION DESIGNS MAY BE SUBJECT TO CHANGE BASED ON UNFORSEEN SOIL CONDITIONS. ALL FOUNDING SOILS SHALL BE INSPECTED BY GEOTECHNICAL ENGINEER PRIOR TO FOUNDATION INSTALLATION.
4. GEOTECHNICAL ENGINEER MUST BE PRESENT DURING EXCAVATION AND ENGINEERED FILL CONSTRUCTION IN ORDER TO VERIFY COMPACTION AND SOIL BEARING CAPACITY.
5. REFER TO GEOTECHNICAL REPORT FOR CONSTRUCTION GUIDANCE REGARDING ENGINEERED FILL AND DEWATERING.
6. ALL DEWATERING TO BE THE RESPONSIBILITY OF THE GENERAL CONTRACTOR.
7. SOIL CONDITIONS, REINFORCING STEEL AND FORMWORK SHALL BE INSPECTED BY THE ENGINEER BEFORE POURING CONCRETE. CONTRACTOR SHALL GIVE ENGINEER A MINIMUM 24 HOURS NOTICE TO CARRY OUT INSPECTION.
8. THE LINE OF SLOPE BETWEEN ADJACENT FOOTING OR EXCAVATIONS SHALL NOT EXCEED A RISE OF 7 IN A RUN OF 10 UNLESS APPROVED BY THE GEOTECHNICAL ENGINEER.
9. DO NOT BACKFILL AGAINST FOUNDATION WALLS UNTIL LATERAL SUPPORTING FLOORS HAVE BEEN CONSTRUCTED, UNLESS BRACING DETAILS ARE SUBMITTED. WHERE POSSIBLE BACKFILL BOTH SIDES OF WALLS SIMULTANEOUSLY FOR BURIED FOUNDATIONS.
10. FOOTINGS SUBJECT TO FROST ACTION SHOULD BE PROVIDED WITH 1200mm OF EARTH COVER OR EQUIVALENT THERMAL INSULATION. A 25mm THICK LAYER OF POLYESTERENE INSULATION IS THERMALLY EQUIVALENT TO 600mm OF SOIL COVER.

STRUCTURAL STEEL

1. DESIGN & CONSTRUCTION CODES/STANDARDS:

CAN/CSA 516-01 LIMIT STATES DESIGN OF STEEL STRUCTURES

CAN/CSA 540.20/540.21 STRUCTURAL QUALITY STEEL

CAN/CSA 590.15 BILLET-STEEL BARS FOR CONCRETE REINFORCEMENT

CAN/CSA M186 WELDING OF REINFORCING BARS IN CONCRETE CONSTRUCTION

CAN/CSA M54 WELDED STEEL CONSTRUCTION

2. STRUCTURAL STEEL SHALL CONFORM TO CSA 540.21 GRADE 350N (CLASS H FOR HOLLOW STRUCTURAL SECTION-H56) WITH ONE SHOP COAT AND FIELD TOUCH-UP OF ZINC CHROMATE PRIMER, CONFORMING TO GSG/CPMA STANDARD 1-13A OR 2-75; IT SHALL BE PAINTED TO OWNERS SPECIFICATION.

3. E480XX (E70XX) ELECTRODES TO BE USED FOR ALL WELDING.

4. ALL STEEL CONNECTIONS TO BE DESIGNED BY THE STEEL FABRICATOR USING THE SUPPLIED FACTORED DESIGN LOADS. WHEN DESIGN LOADS ARE NOT PROVIDED, THE MEMBER SHALL BE ASSUMED TO BE SIMPLY - SUPPORTED WITH ALL CONNECTIONS DESIGNED AS PER THE STANDARD GSG MANUAL PRACTICES.

5. SUBMIT SHOP DRAWINGS, INCLUDING CONNECTIONS DETAILS AND LOCATIONS OF ALL SPLICES FOR REVIEW BEFORE PROCEEDING WITH FABRICATION. ALL SHOP DRAWINGS SHALL BE SEALED BY A PROFESSIONAL ENGINEER LICENSED IN THE PROVINCE OF ONTARIO.

CONCRETE

1. DESIGN & CONSTRUCTION CODES/STANDARDS

CAN/CSA A23.1 CONCRETE MATERIALS & METHODS OF CONCRETE CONSTRUCTION

CAN/CSA A23.2 METHODS OF TEST & STANDARD PRACTICES FOR CONCRETE

CAN/CSA A23.3 DESIGN OF CONCRETE STRUCTURES

CAN/CSA A23.4 PRE-CAST CONCRETE

2. ALL CONCRETE SHALL HAVE A 28-DAY COMPRESSIVE STRENGTH OF 25 MPa MINIMUM AND EXPOSURE CLASS OF TYPE "N" UNLESS OTHERWISE SPECIFIED. CONCRETE MIX DESIGNS SHALL BE SUBMITTED FOR REVIEW PRIOR TO CONSTRUCTION.

3. THE CONCRETE EXPOSURE CLASS AND 28-DAY COMPRESSIVE STRENGTH FOR EACH STRUCTURAL ELEMENT SHALL BE AS FOLLOWS, UNLESS OTHERWISE NOTED:

	EXPOSURE CLASS	28-DAY COMPRESSIVE STRENGTH
FOOTINGS	N	25 MPa
FOUNDATION WALLS AND COLUMNS (EXTERIOR)	F-2	25 MPa
FOUNDATION WALLS AND COLUMNS (INTERIOR)	N	25 MPa
INTERIOR FLOOR SLABS	N	25 MPa
REINFORCED WALLS AND SLABS	C-1	35 MPa
EXTERIOR SLABS	C-2	32 MPa

4. REINFORCEMENT SHALL BE DEFORMED BARS AND CONFORM TO CAN/CSA 690.10, GRADE 400MPa.

5. REINFORCING STEEL SHALL BE DETAILED, BENT, PLACED AND SUPPORTED TO CONFORM TO ACI STANDARDS 315 AND THE MANUAL OF STANDARD PRACTICE PUBLISHED BY THE REINFORCING STEEL INSTITUTE OF ONTARIO.

6. WELDING OF REINFORCING STEEL SHALL NOT BE PERMITTED.

7. MINIMUM REINFORCEMENT LAP LENGTHS:

BAR SIZE	MIN. SPLICE LAP LENGTH
10M	400mm
15M	600mm
20M	900mm
25M	1300mm

8. ALL REINFORCEMENT LAPS TO BE "CLASS B" UNLESS OTHERWISE DIRECTED BY THE ENGINEER.

9. CONCRETE SLABS-ON-GRADE TO BE REINFORCED WITH WELDED WIRE MESH REINFORCING IN ADDITION TO THE SPECIFIED REINFORCEMENT, UNLESS OTHERWISE NOTED.

10. REINFORCEMENT SPACING SHOWN ON DRAWINGS TO BE A MAXIMUM. ENSURE MINIMUM 1-15M TOP AND BOTTOM CONTINUOUS AT ALL SLAB EDGES BY ADJUSTING BAR LENGTH OR PROVIDING ADDITIONAL TOP/BOTTOM EDGE BARS AS REQUIRED.

11. PROVIDE CHAIRS, SPACER BARS, SUPPORT BARS AND OTHER ACCESSORIES TO SUPPORT REINFORCING IN ACCORDANCE WITH THE LATEST EDITIONS OF CSA A23.1 AND A23.3. CHAIRS TO BE PLASTIC, PLASTIC TIPPED OR CONCRETE. ALL TIE WIRE, CHAIRS AND BAR SUPPORTS USED FOR COATED REINFORCING SHALL BE NON-METALLIC OR PROTECTED WITH AN ACCEPTABLE COATING. CHAIRS SHALL BE SPACED AT 1200mm O.C. MAXIMUM.

12. ALL REINFORCING STEEL FABRICATION AND PLACEMENT DRAWINGS SHALL BE SUBMITTED TO THE ENGINEER FOR REVIEW BEFORE FABRICATION.

13. CONCRETE COVER FOR REINFORCEMENT SHALL CONFORM TO CSA STANDARD A23.1, AS FOLLOWS, UNLESS OTHERWISE NOTED:

	EXPOSED TO WEATHER	NOT EXPOSED TO WEATHER
CAST AGAINST EARTH	75 mm +/- 12mm (3" +/- 1/2")	75 mm +/- 12mm (3" +/- 1/2")
BELAYS, SLABS, WALLS, 50 mm +/- 12mm (2" +/- 1/2")	50 mm +/- 12mm (2" +/- 1/2")	40 mm +/- 12mm (1-1/2" +/- 1/2")
AND COLUMNS		

14. SLAB-ON-GRADE TO BE PLACED ON COMPACT GRANULAR MATERIAL. COMPACTION TESTS ON FILL MATERIAL TO BE CARRIED OUT PRIOR TO SLAB-ON-GRADE PLACEMENT.

15. PROVIDE 10mm ASPHALT IMPREGNATED FIBRE BOARD AND CAULKING AROUND ALL COLUMNS AND ALONG ALL WALLS.

16. PROVIDE CHAMFERS, REGLETS, RIVETS, REVEALS, RECESSES AND THE LIKE AS SHOWN ON THE ARCHITECTURAL AND/OR STRUCTURAL DRAWINGS.

17. ALL CONCRETE FORMS TO BE KETTED THOROUGHLY BEFORE POURING CONCRETE.

18. MAINTAIN MINIMUM SPECIFIED THICKNESS AT ALL DEPRESSIONS AND CHANGES IN ELEVATIONS. REFER TO ARCHITECTURAL AND STRUCTURAL DRAWINGS FOR EXTENT AND LOCATIONS OF ALL FINISHES AND DEPRESSIONS.

19. DO NOT ADD WATER TO CONCRETE ON SITE UNLESS WRITTEN APPROVAL IS GIVEN BY THE ENGINEER. IF HIGHER SLUMP CONCRETE IS DESIRED, CONCRETE SUPPLIER SHALL DESIGN AND SUPPLY ACCORDINGLY.

20. SLOPE ALL FLOORS AS SHOWN ON ARCHITECTURAL OR MECHANICAL DRAWINGS. FLOOR DRAINS TO SLOPE 1% MIN. IN THE DIRECTION OF ALL FLOOR DRAINS TYPE.

21. REFER TO ARCHITECTURAL DRAWINGS AND SPECIFICATIONS FOR REQUIRED FINISH TO EXPOSED CONCRETE. FLOOR FINISHES SHALL CONFORM TO CSA STANDARD A23.1 CLASS A FINISH UNLESS OTHERWISE NOTED.

22. ALL REQUIRED OPENINGS SHALL BE SLEEVED OR FORMED PRIOR TO PLACING CONCRETE. CORING OR SAW CUTTING FOR OPENINGS AFTER CASTING SHALL NOT BE PERMITTED AS AN ALTERNATE METHOD OF PROVIDING OPENINGS. ALL DRAINS SHALL BE SET PRIOR TO CONCRETE PLACING.

23. FOR OPENINGS GREATER THAN 300mmx300mm (12"x12") REINFORCE AROUND THE OPENING IN ACCORDANCE WITH THE TYPICAL DETAILS UNLESS OTHERWISE NOTED.

24. CURING

- REINFORCED CONCRETE ELEMENTS TO BE WET-CURED AS PER ACI 308 AND THE DURATIONS SPECIFIED BELOW UNLESS DIRECTED OTHERWISE BY THE ENGINEER.

CONCRETE SLABS: 7 DAYS MINIMUM

EXPOSED CONCRETE WALLS: 4 DAYS MINIMUM

25. ALL HONEYCOMBS SHALL BE CUT OUT AND FILLED TO THE SATISFACTION OF THE ENGINEER.

26. PROVIDE SAWCUTS WITHIN 24 HOURS OF FINISHING AT LOCATIONS SHOWN ON DRAWINGS. SAWCUT DEPTH TO BE 1/4 OF SLAB THICKNESS. SAWCUT AS CLOSE TO COLUMNS OR WALLS AS PRACTICAL. FILL SAWCUTS WITH NON-METALLIC JOINT FILLER (STERNSON LOADFLEX OR EQUAL).

27. SPACING OF SAW-CUT CONTROL JOINTS IN CONCRETE SLABS SHALL NOT EXCEED 4.5m (14'-6") O.C.

28. SUBMIT PROPOSED SAW-CUT CONTROL JOINT LOCATION TO THE ENGINEER FOR APPROVAL UNLESS SHOWN ON DRAWINGS.

29. OPENINGS AND DRIVEN FASTENERS REQUIRED IN THE CONCRETE AFTER THE CONCRETE IS PLACED, SHALL BE APPROVED BY THE ENGINEER BEFORE PROCEEDING.

30. NON-SHRINK GROUT SHALL BE AN APPROVED PREMIXED PROPRIETARY PRODUCT.

31. DRY-PACKED GROUT SHALL BE 1 PART PORTLAND CEMENT TO 1.5 PARTS OF SAND TO 2 PARTS OF #4mm PEA GRAVEL WITH ONLY SUFFICIENT WATER TO DAMPEN THE MIXTURE. COMPRESSIVE STRENGTH SHALL BE 50MPa AT 28 DAYS.

NO.	DATE	ISSUANCE
1	2021.05.04	ISSUED FOR BUILDING PERMIT APPLICATION
NO.	DATE	ISSUANCE

ISSUED FOR  
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AND  
CONSTRUCTION

DO NOT SCALE DRAWINGS. CALL FOR ANY CLARIFICATIONS THAT ARE REQUIRED. FIELD VERIFY AT ALL BUILT CONDITIONS.

ALL DWG.'S ARE TO BE READ IN COLOUR

ORIGINAL PAGE SIZE ARCH "D" - 24" x 36"



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2 TALBOT STREET NORTH  
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(519) 426-6270

STAMP ARCH.

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PROJECT TITLE:  
SIDWAY COTTAGE

13 LAKESIDE LANE,  
PORT DOVER, ONTARIO  
N0A 1N2

DRAWING TITLE:  
STRUCTURAL GENERAL NOTES

CHECKED BY:

B.B.

DRAWING SCALE:

1 : 50

PROJECT NO.:

21-044


DRAWN BY:

B.L.H.

DRAWING NO.:

S000



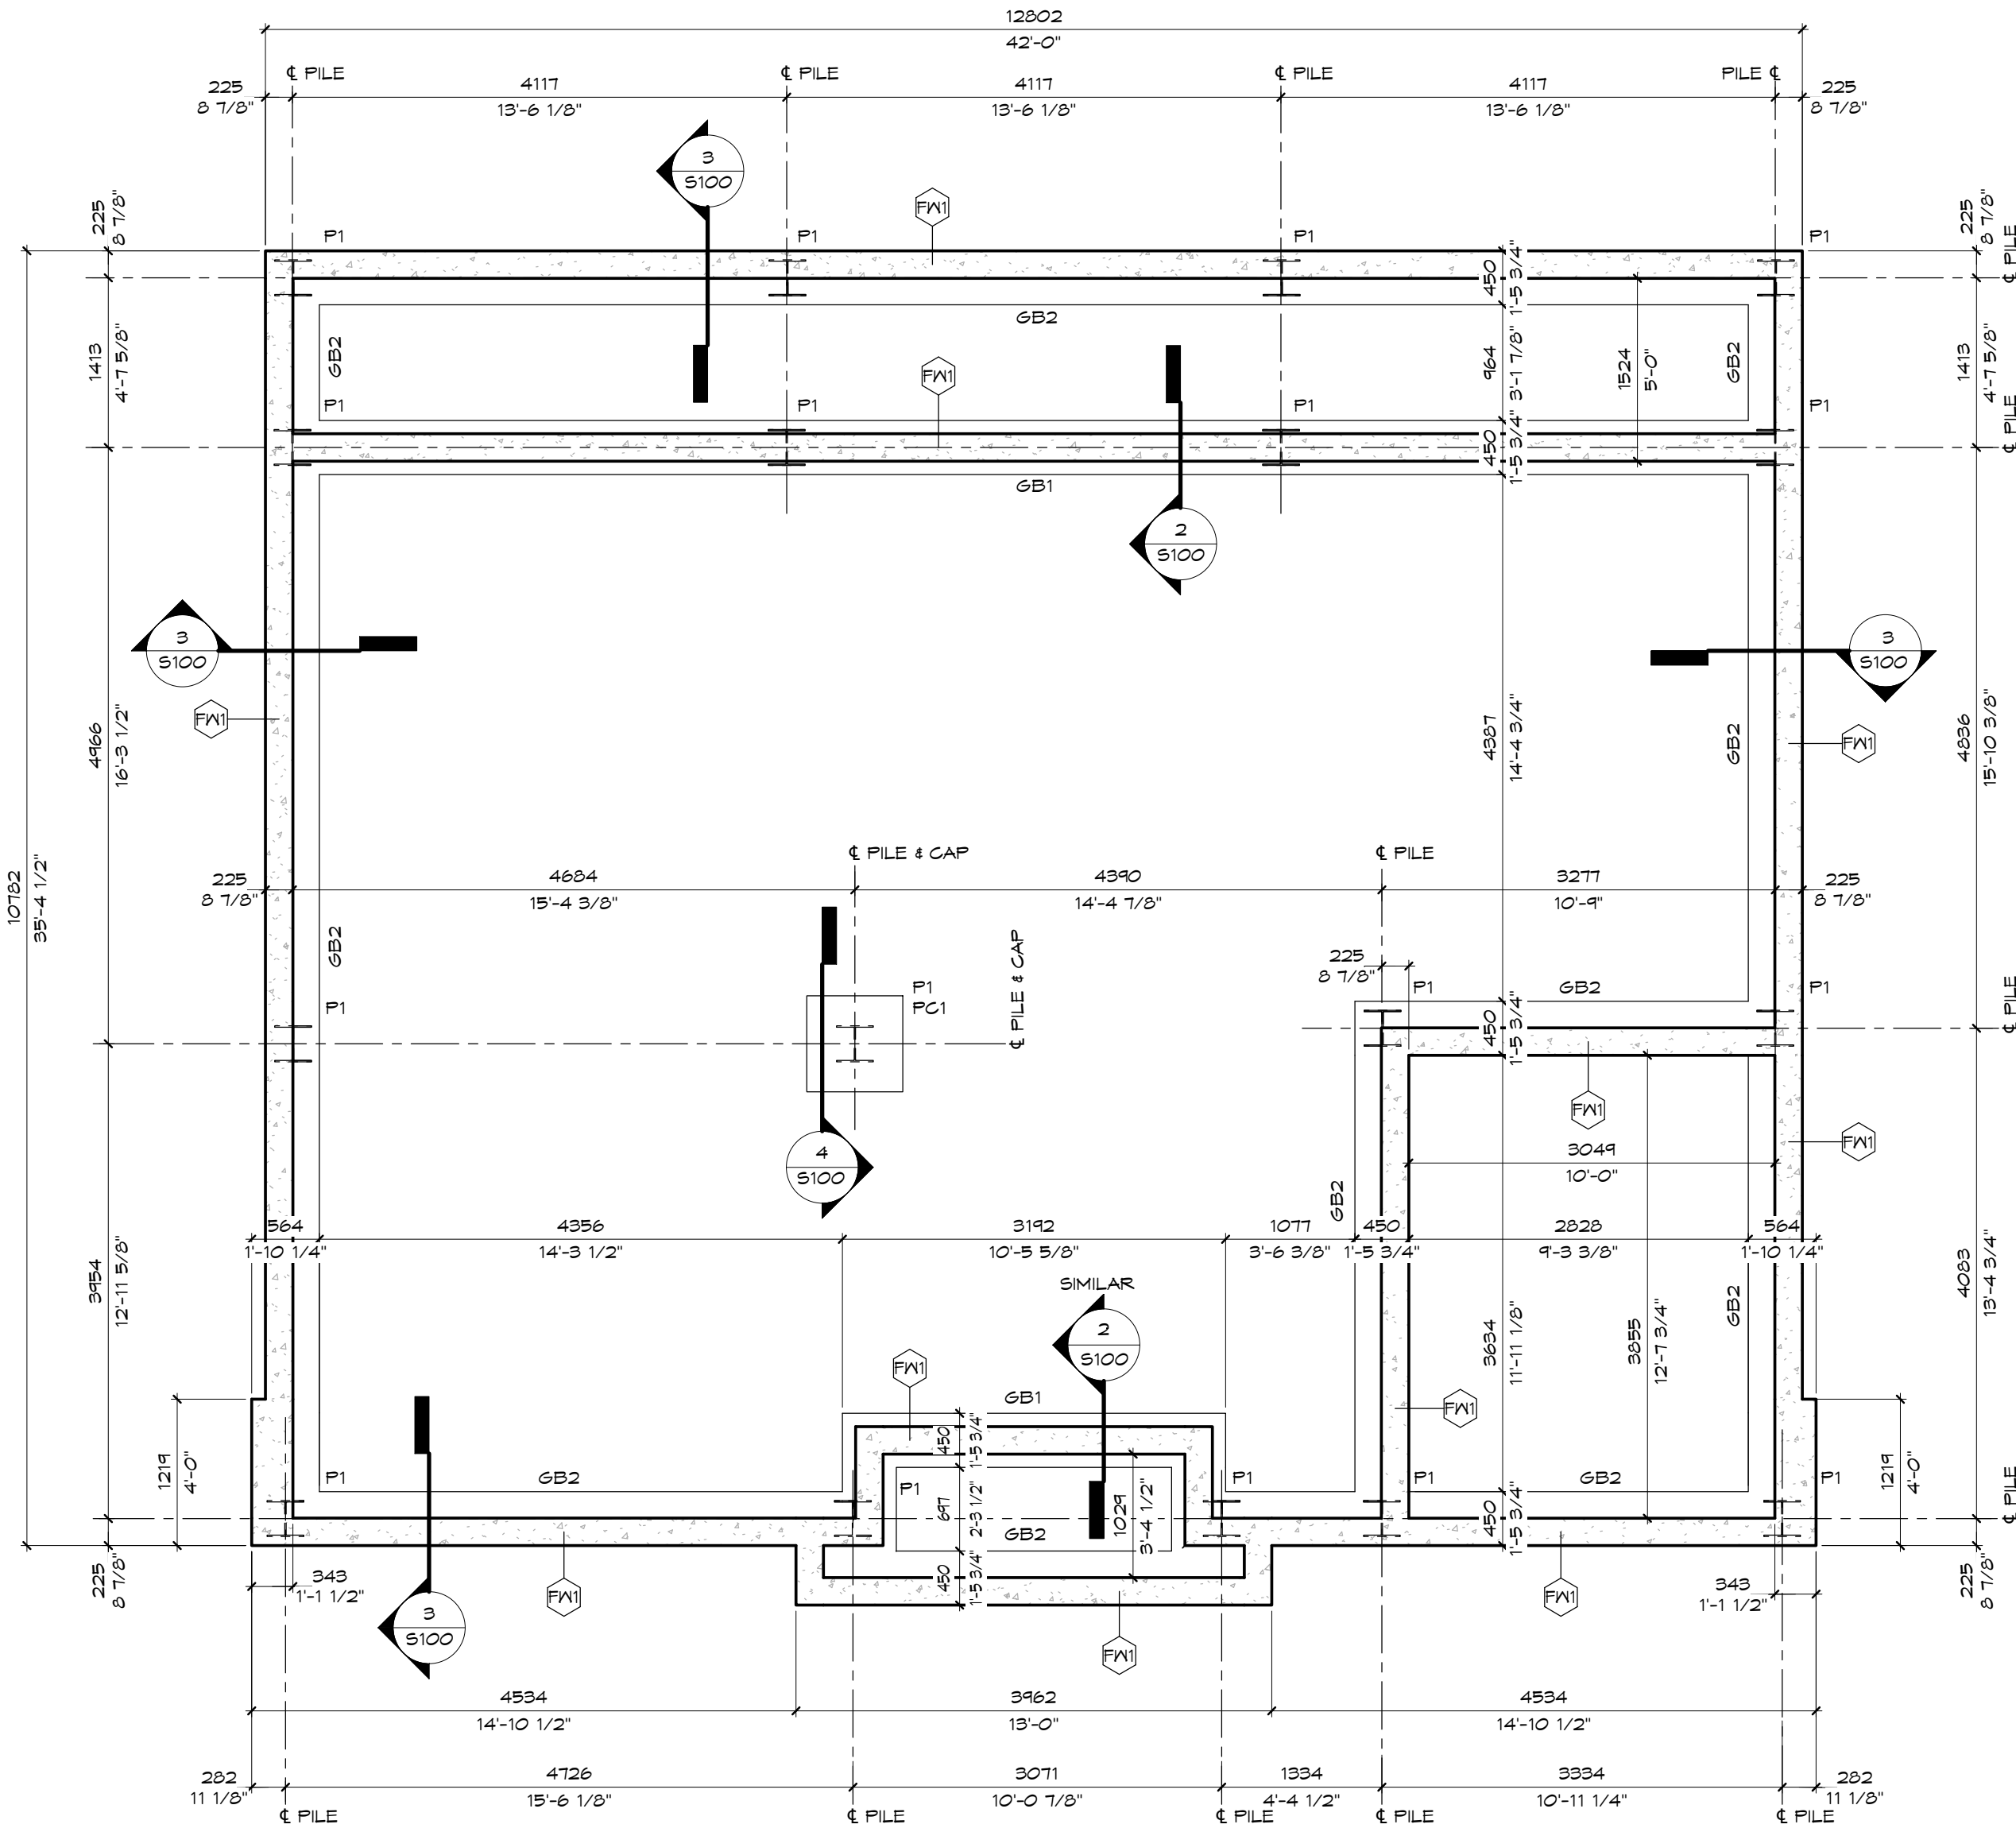

**1 FOUNDATION PLAN**  
S100 SCALE 1:50

### GRADE BEAM SCHEDULE

MARK	DESCRIPTION
GB1	450mm (11 3/4") WIDE x 1200mm (4') DEEP GRADE BEAM C/W REBAR AS DETAILED
GB2	450mm (11 3/4") WIDE x 1200mm (4') DEEP GRADE BEAM C/W REBAR AS DETAILED

#### NOTES:

- ALL INT. GRADE BEAMS ARE TYPE GB1 U/N/O
- ALL EXT. GRADE BEAMS ARE TYPE GB2 U/N/O
- WHERE REINFORCEMENT OF THE FOUNDATION WALLS IS REQUIRED, ALL RE-BAR SHALL BE DOVEILED INTO GRADE BEAMS MIN. 600mm (2') EMBEDMENT, (2'-0" LAP LENGTH FOR TIE-IN DOVELS)

### PILE SCHEDULE

MARK	DESCRIPTION
P1	1/3"X14" DRIVEN TO REFUSAL AT BEDROCK

### PILE CAP SCHEDULE

MARK	DESCRIPTION
PC1	800mm x 800mm x 800mm DEEP PILE CAP C/W REBAR AS DETAILED

### FOUNDATION WALL REINFORCING SCHEDULE

MARK	WALL TYPE	HORIZONTAL	VERTICAL
FX1	229mm (9") CONCRETE WALL	15M @ 300mm O/C E.W.	15M @ 300mm O/C (AT CENTER)

#### NOTES:

- 1. 15mm (3/8") COVER AT EXTERIOR CONDITIONS, 50mm (2") COVER AT INTERIOR CONDITIONS

### FOUNDATION NOTES


- FOUNDATION PLAN TO BE USED FOR THE GRADE BEAM DESIGN ONLY, IN LIEU OF THE STRIP FOOTINGS SHOWN ON THE DRAWINGS PROVIDED BY ENGAGED CUSTOM HOME DESIGN.
- ALL ELEVATIONS FOR FOUNDATION WALLS AND TOP OF GRADE BEAMS TO BE AS PER THE DRAWINGS PROVIDED BY ENGAGED CUSTOM HOME DESIGN.
- ALL FOUNDATION WALLS, FLOOR SLABS AND FRAMING TO BE AS PER THE DRAWINGS PROVIDED BY ENGAGED CUSTOM HOME DESIGN.

### FOUNDATION LEGEND


GB#	GRADE BEAM TAG & IDENTIFICATION (COORD. IV GRADE BEAM SCH.)
PF	STEEL H-PILE TAG & IDENTIFICATION (COORD. IV PILE SCH.)
PC#	CONC. PILE CAP TAG & IDENTIFICATION (COORD. IV PILE CAP SCH.)
FX#	FOUNDATION WALL TAG & IDENTIFICATION (COORD. IV FDTN. SCH.)

#### GENERAL NOTES:


- REFERENCE - FIN. FLR. ELEV. OF LEVEL 1 IS 0000
- TOP OF ALL INT. FTG.'S ARE 1200mm MIN. BELOW FIN. FLR. U/N/O. INT. FTG.'S ARE TO BE STEPPED DOWN TO EXT. FTG.'S WHERE APPLICABLE
- GRADE BEAM THICKNESS(ES) SHOWN ARE MIN. ALL SIDES OF FTG.'S ARE TO BE PROPERLY FORMED TO PREVENT OUTWARD FLOW OF CONC. BELOW FORMWORK
- ALL SLABS ON GRADE SHALL BE AS PER. FLR. TYPES ON: GRANULAR 'A' 150mm THICK COMPACTED TO 100% SPMD, GRANULAR 'B' BACKFILL AT ALL HARD SURFACES COMPACTED TO 100% SPMD, ON UNDISTURBED NATIVE SOIL / ENG'D FILL (COORD. IV ARCH. FOR UNDER SLAB INSUL. LOCATIONS)
- INSTALL SAWCUT CONTROL JOINTS IN CONC. S/O/S @ 4500mm MAX. SPACING U/N/O; COORD. IV TYP. SAWCUT CONTROL JOINT DETAIL; SAW CUTS TO BE PROVIDED @ ALL DOOR OPENINGS
- INSTALL SLEEVES IN ALL WALLS FOR STORM & SANITARY LINES
- CORNER & INTERSECTION SPICE BARS SHALL BE PROVIDED IN CONC. WALLS & GRADE BEAMS IN ACCORDANCE IV MANUAL OF STD. PRACTICE FOR REIN. STEEL. DETAILS TO BE SUBMITTED IV SHOP DNG.'S

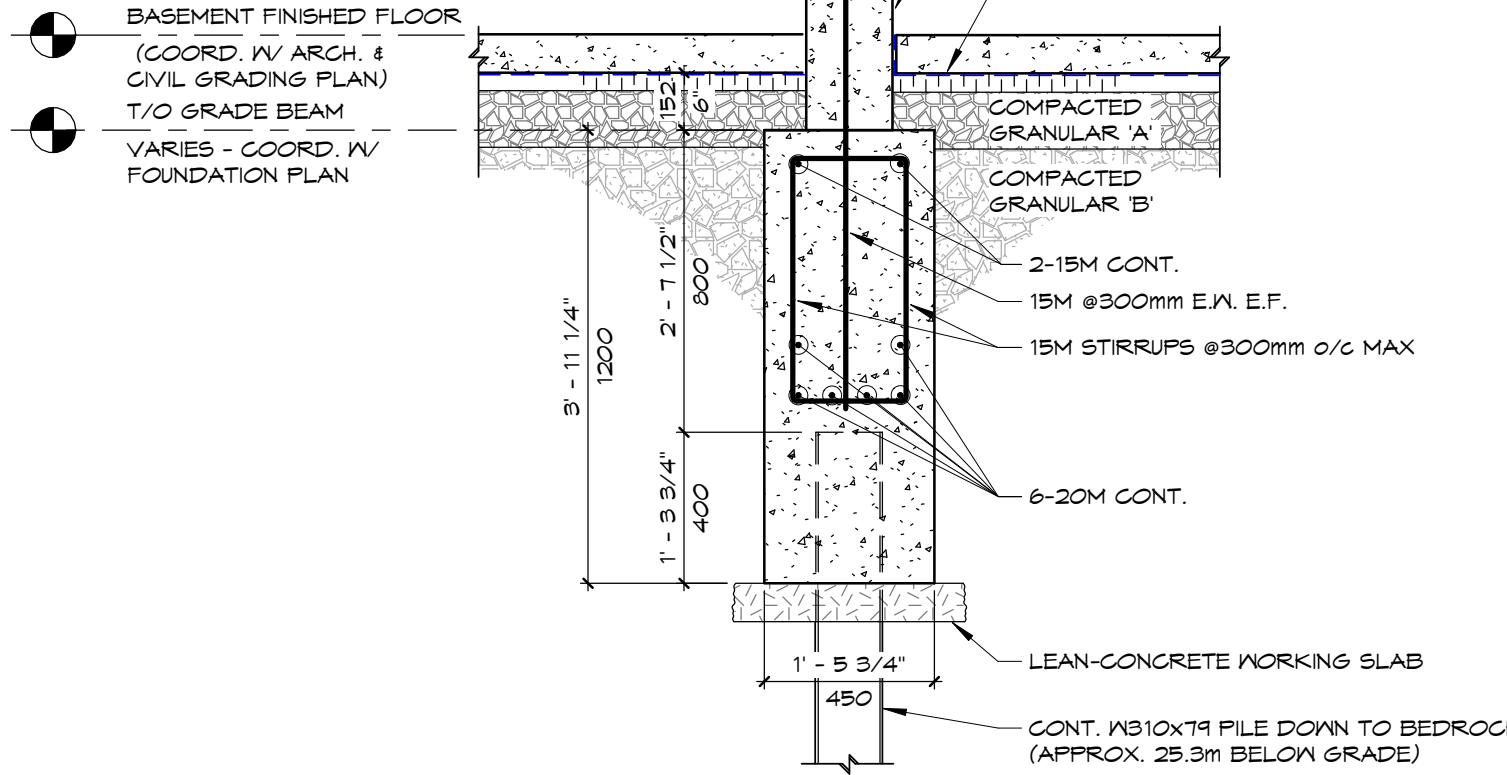


**2 TYPICAL INTERIOR GRADE BEAM (GB1)**  
S100 SCALE 1:20

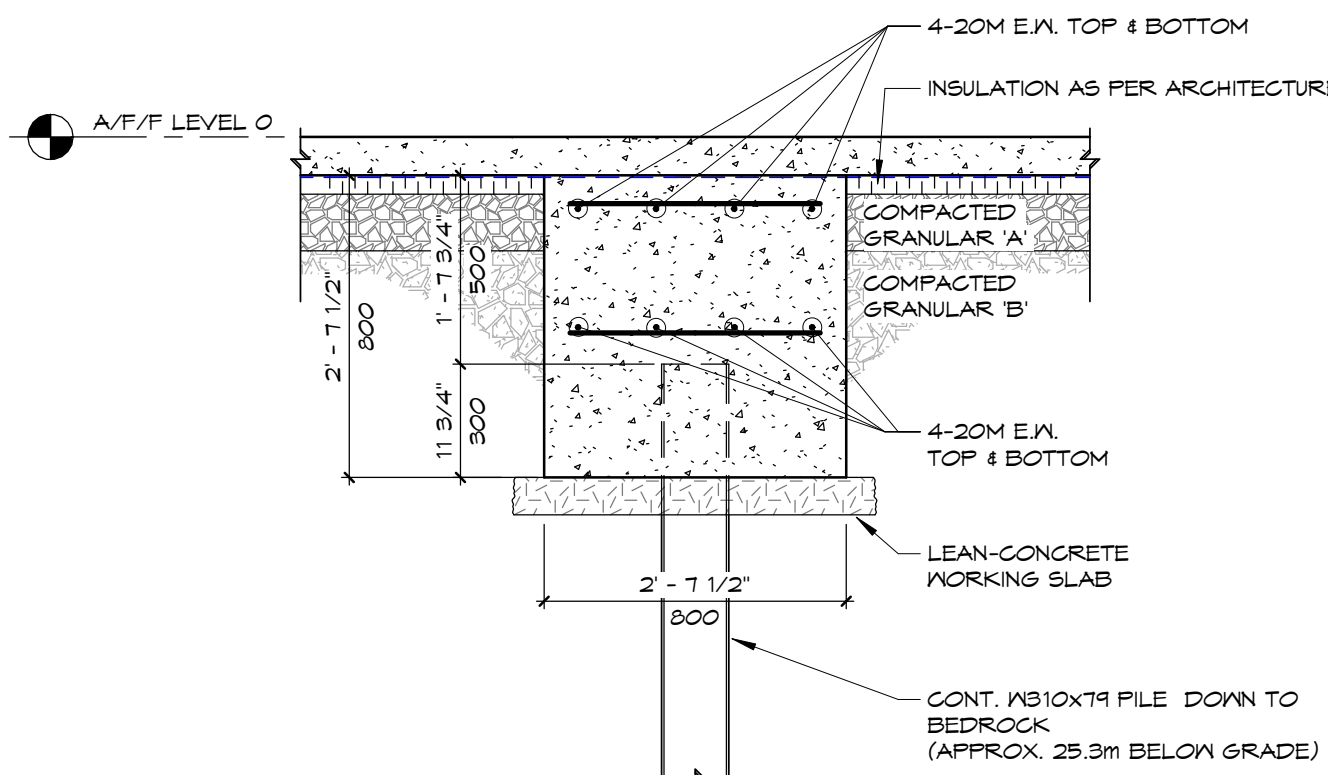

**4 TYPICAL PILE CAP**  
S100 SCALE 1:20

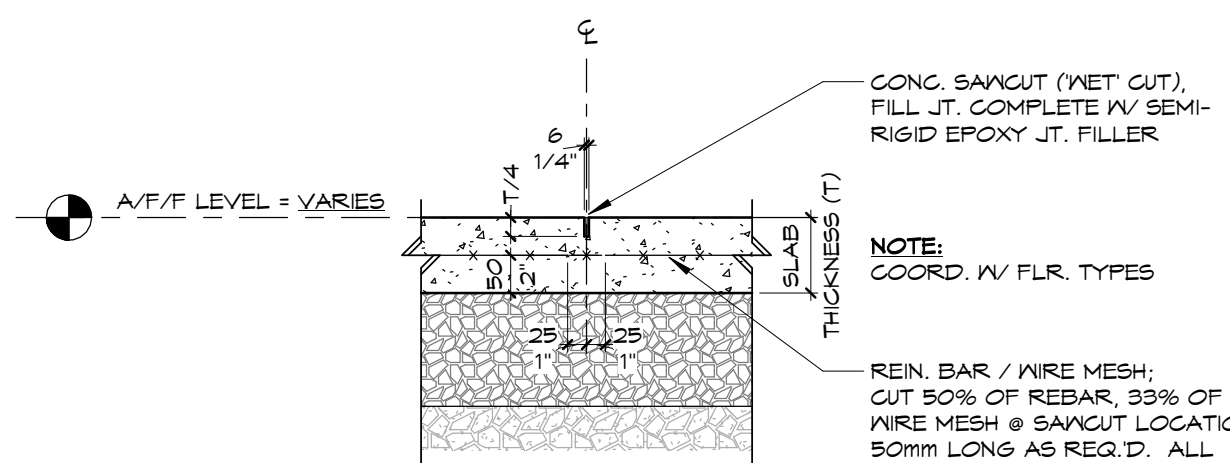


**5 TYPICAL SLAB-ON-GRADE CONTROL JOINT**  
S100 SCALE 1:10

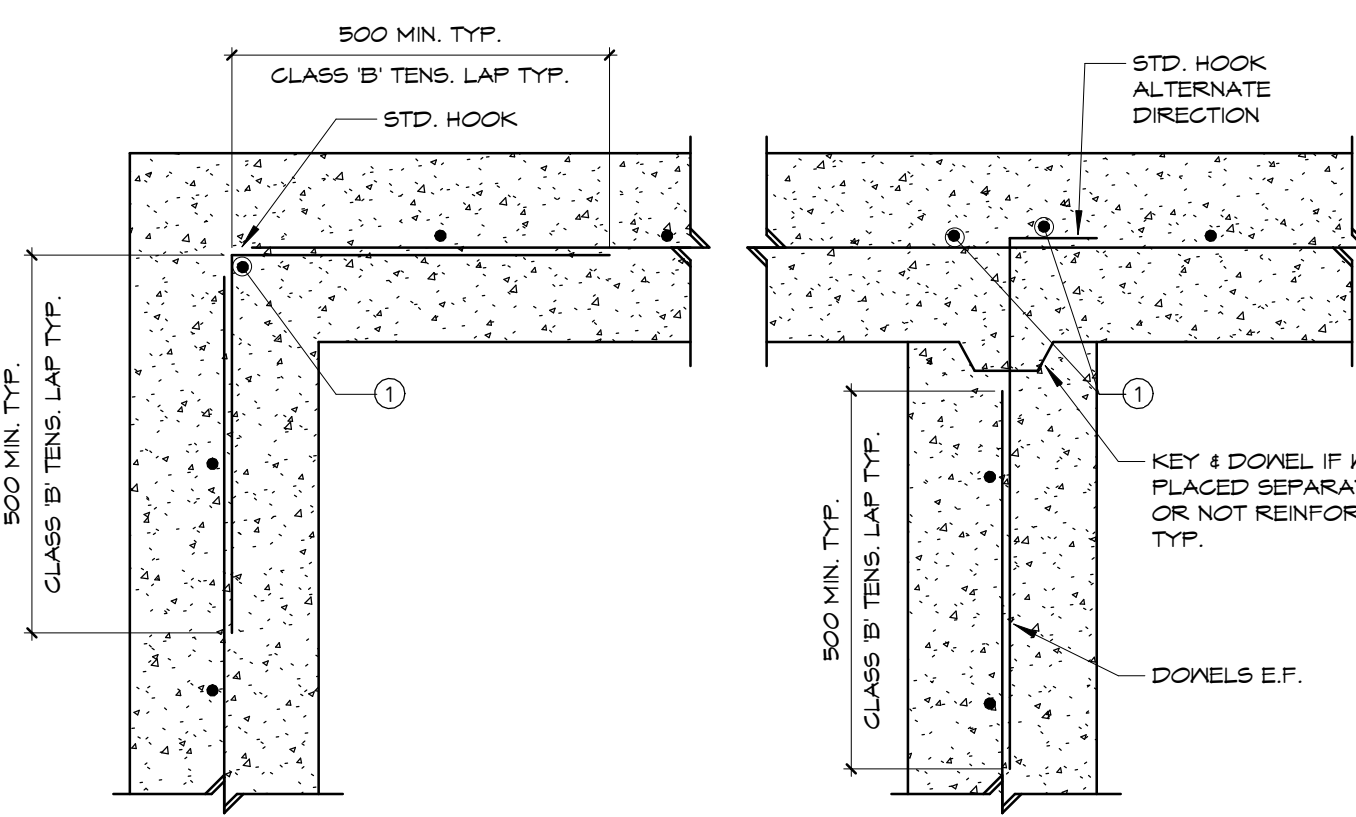


#### NOTES:

1. DENOTES 3 CORNER BARS SAME SIZE AND SPACING AS LARGEST VERTICAL REINFORCING. ELSEWHERE PROVIDE 2-20M CORNER BARS UNLESS NOTED.
2. DOVELS TO BE SAME SIZE AND SPACING AS HORIZONTAL REINFORCING.
3. PROVIDE STANDARD HOOKS AS SHOWN.
4. CORNER BAR REINFORCING SHOWN IS TYPICAL FOR ALL GRADE BEAMS AND FOUNDATION WALLS.


**7 TYPICAL CORNER REINFORCEMENT**  
S100 SCALE 1:10

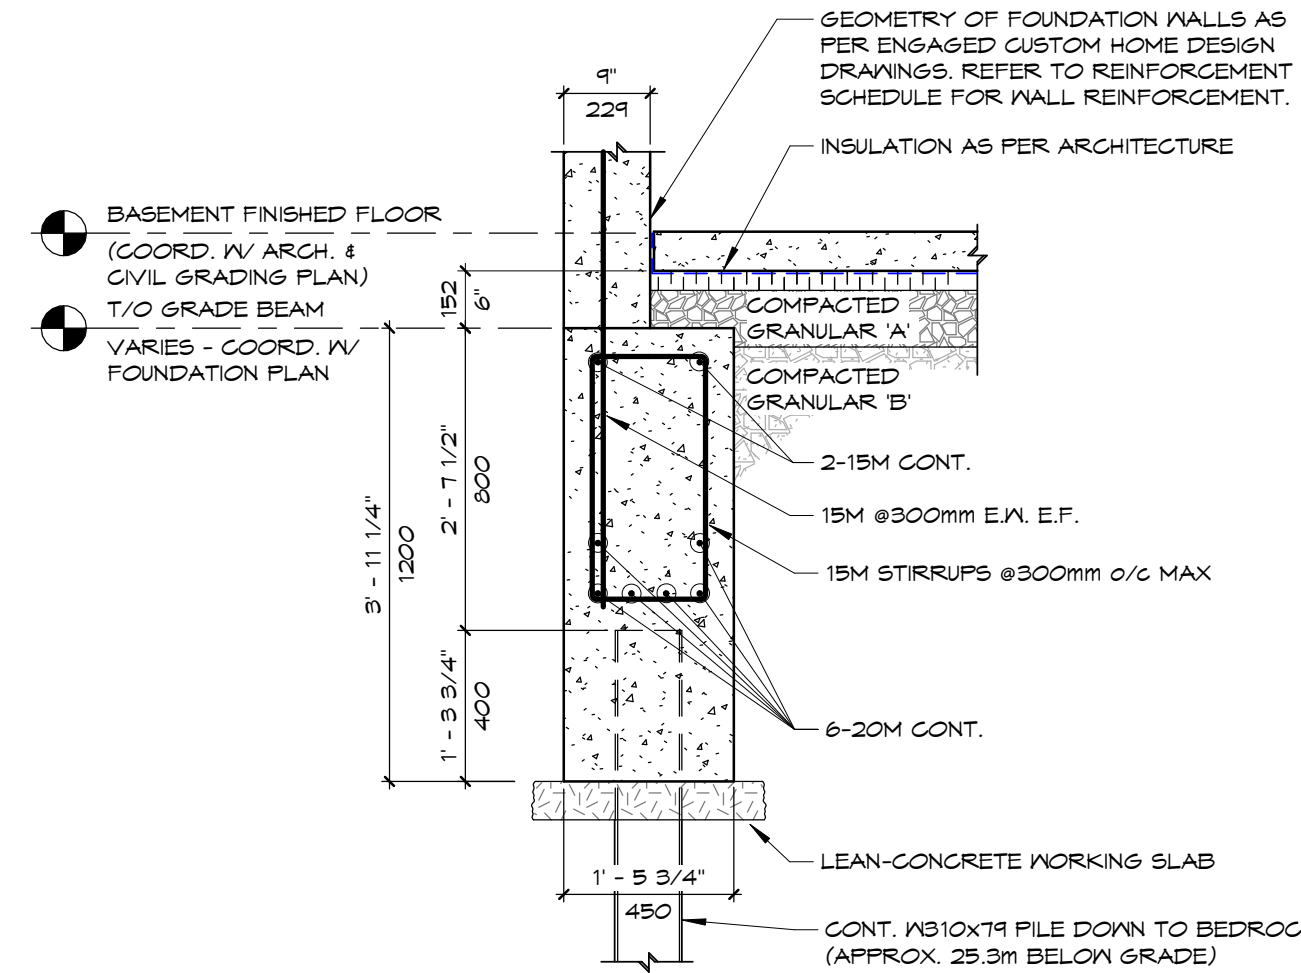

**3 TYPICAL EXTERIOR GRADE BEAM (GB2)**  
S100 SCALE 1:20

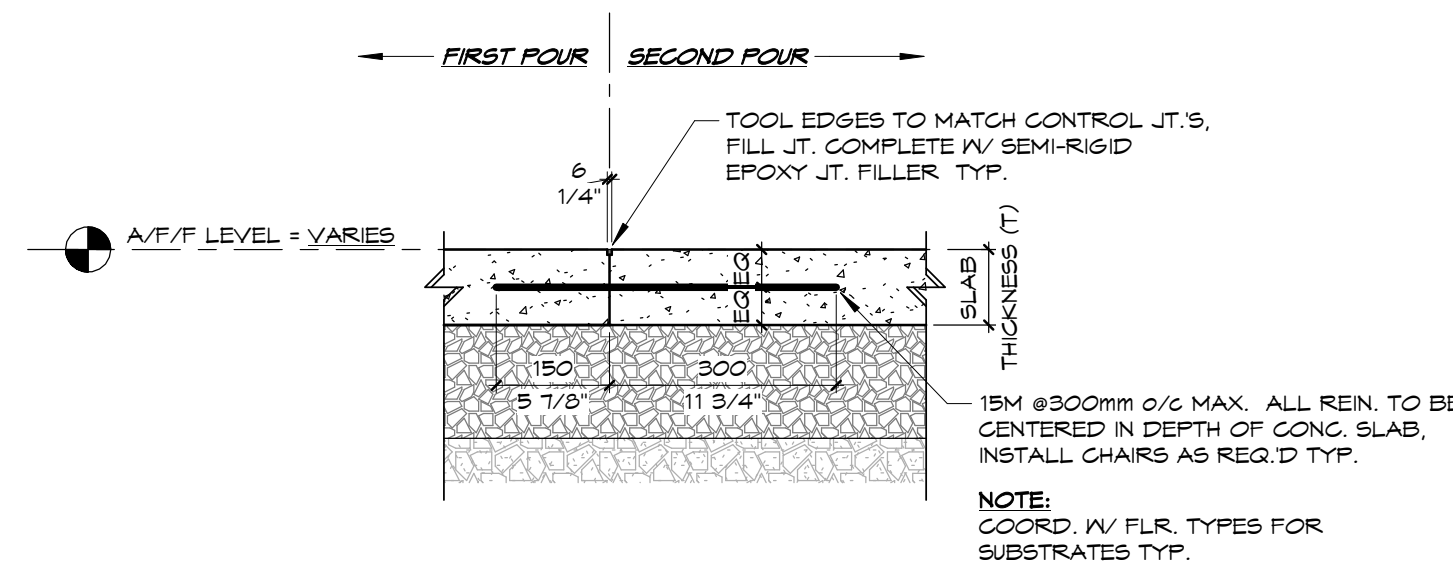


**6 TYPICAL SLAB-ON-GRADE CONSTRUCTION JOINT**  
S100 SCALE 1:10

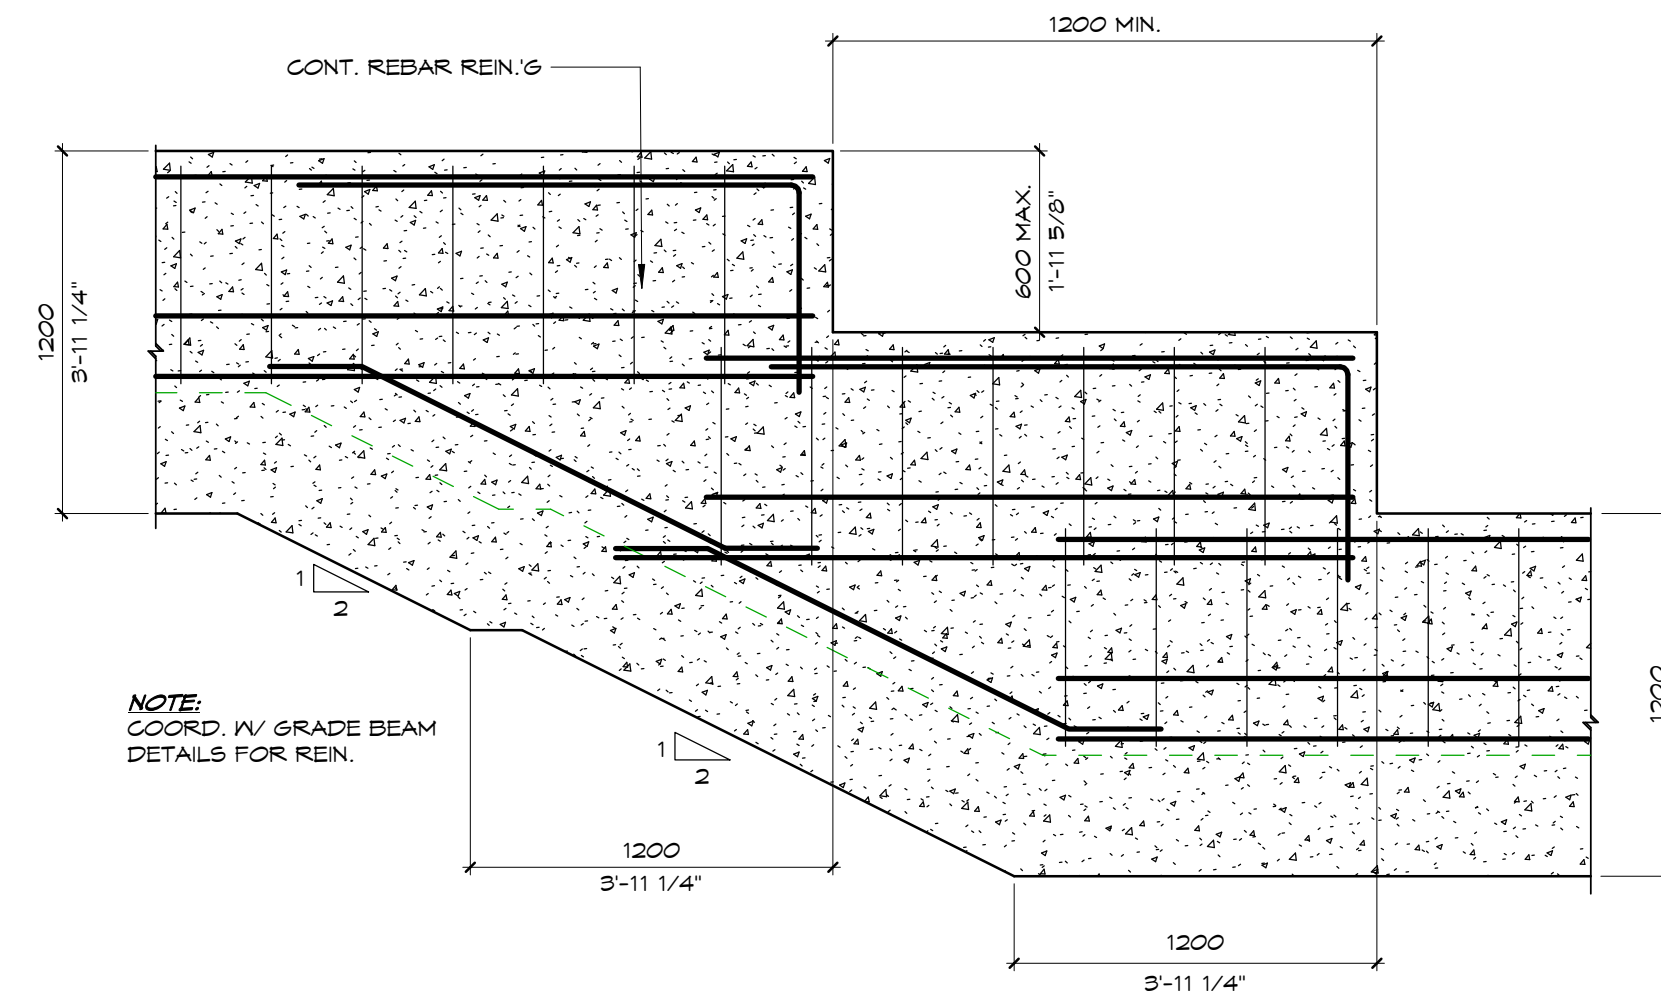

**8 TYPICAL STEPPED GRADE BEAM DETAIL**  
S100 SCALE 1:25

NO.	DATE	ISSUANCE
1	2021.05.04	ISSUED FOR BUILDING PERMIT APPLICATION
NO.	DATE	ISSUANCE

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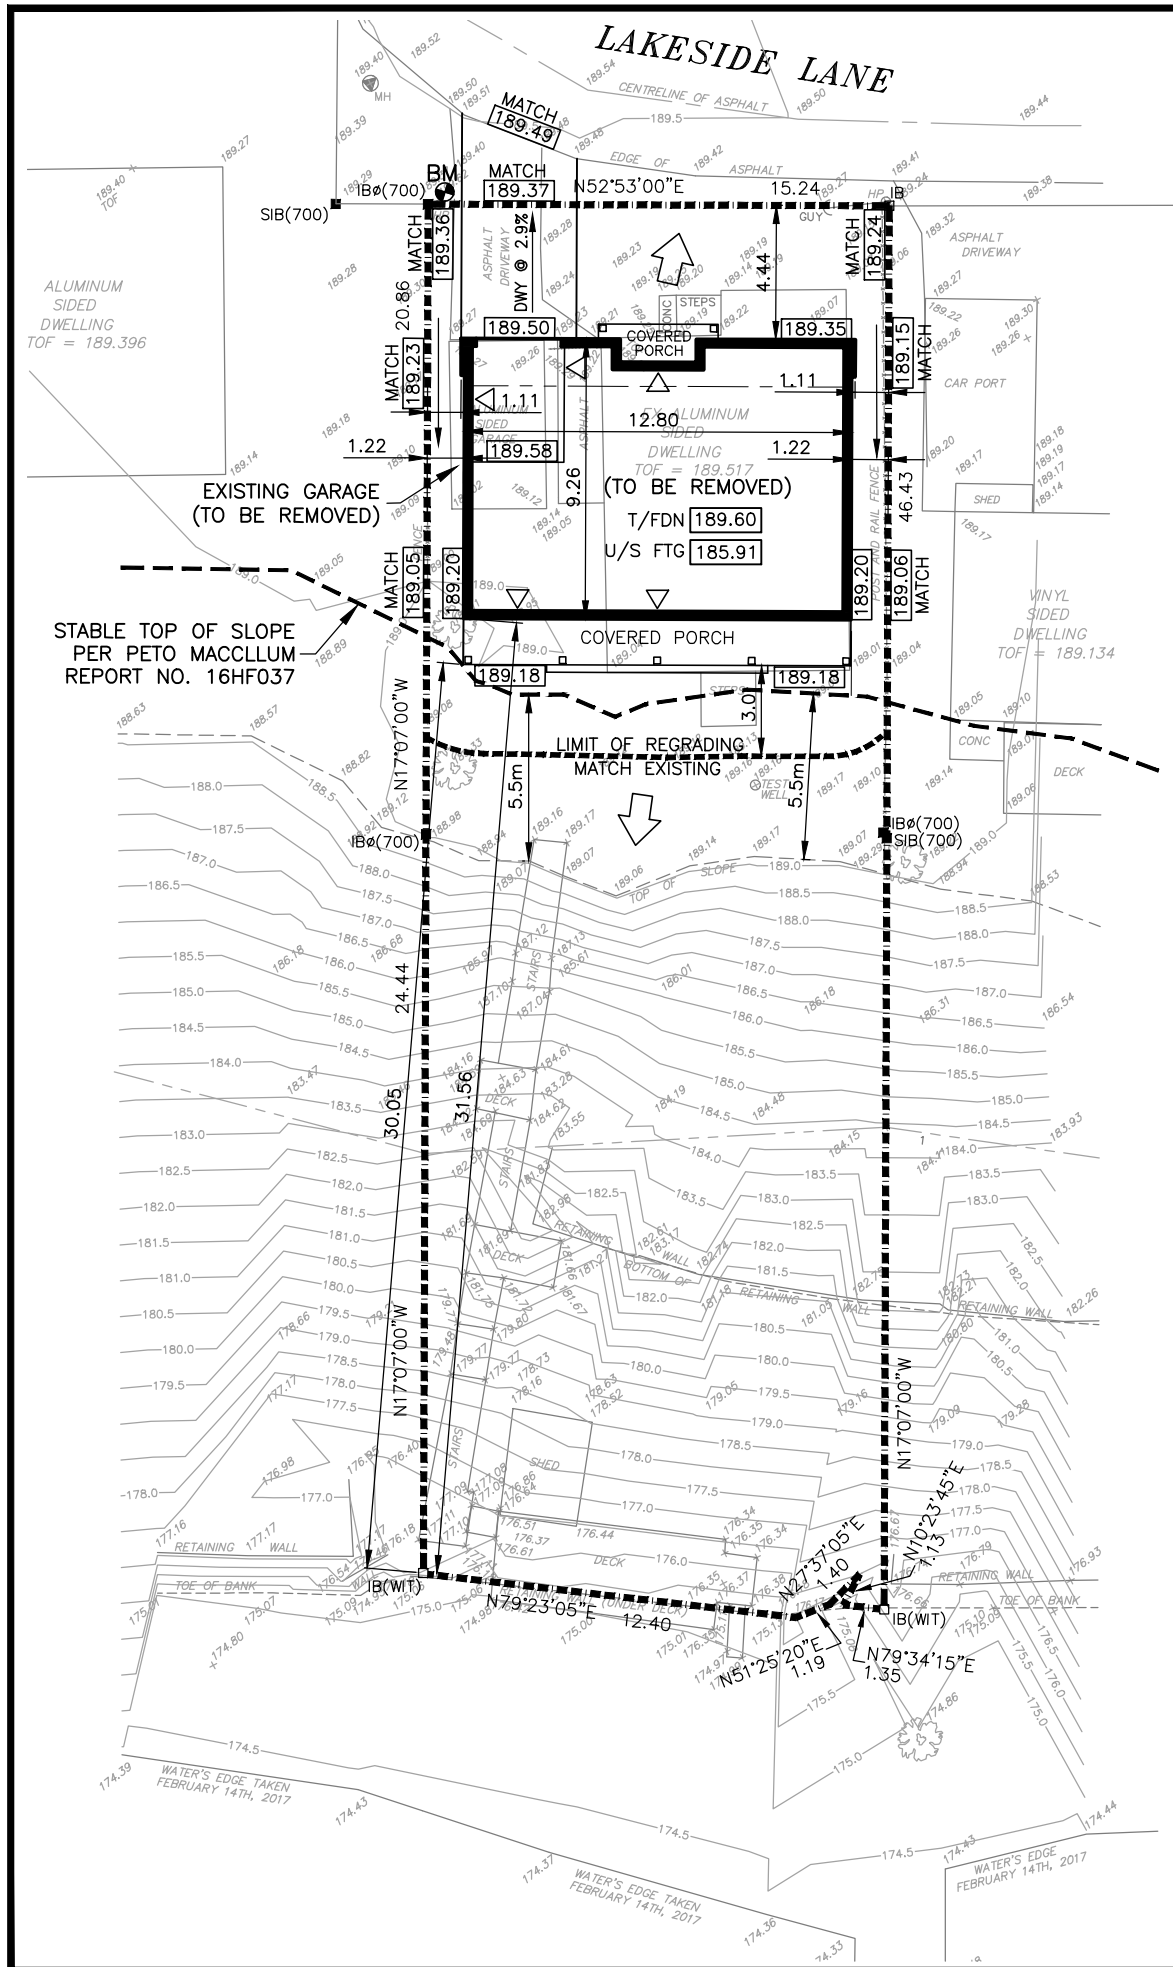
PROJECT TITLE:  
**SIDWAY COTTAGE**

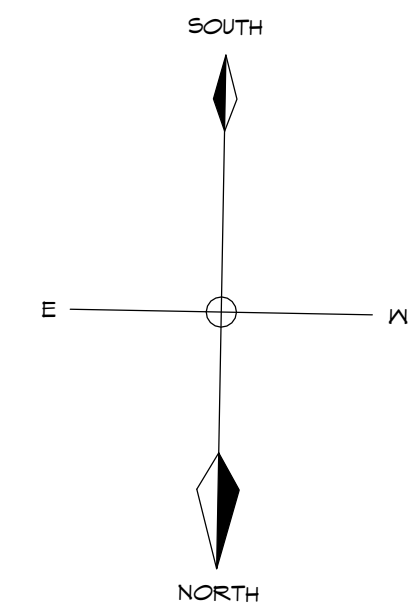13 LAKESIDE LANE,  
PORT DOVER, ONTARIO  
N0A 1N2



DRAWING TITLE:  
**FOOTING, FOUNDATION, SOG  
PLAN**

CHECKED BY: B.B.	DRAWN BY: B.L.H.
DRAWING SCALE: As indicated	DRAWING NO.:
PROJECT NO.: <b>21-044</b>	<b>S100</b>





**NOTE:**  
ALL PROPERTY AND TOPOGRAPHIC INFORMATION WAS COLLECT FROM TOPOGRAPHIC SURVEY BY JEWITT & DIXON LTD ONTARIO LAND SURVEYORS. DWG NO. 16-191 DATED MARCH 16, 2017

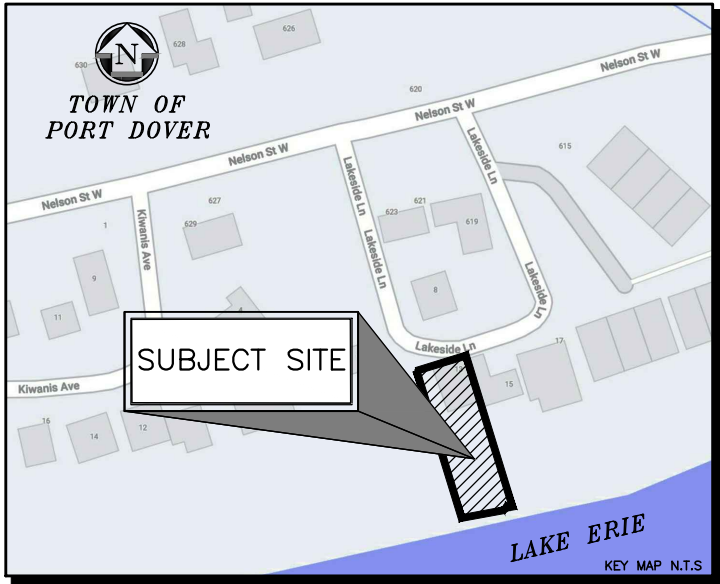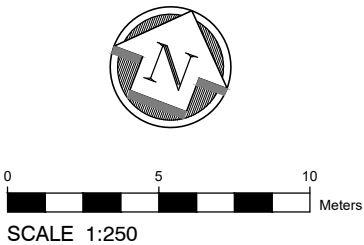

### LEGEND

- 189.64 PROPOSED SPOT ELEVATION
- ← LOT FLOW DIRECTION
- 1.5% PROPERTY LINE FLOW DIRECTION AND SLOPE
- EXISTING SPOT ELEVATION
- EXISTING CONTOUR ELEVATION

### NOTES

CONTRACTOR TO ENSURE THAT HOUSE FOUNDATION IS PLACED ON SUITABLE, DRY SOIL.

ACCORDING TO NORFOLK COUNTY REQUIREMENTS ALL FINAL GRADING MUST BE INSPECTED AND CERTIFIED BY AN ENGINEER OR ONTARIO LAND SURVEYOR. THE BUILDER SHALL ENSURE THAT THE REQUIRED INSPECTIONS ARE CARRIED OUT IN ACCORDANCE WITH COUNTY REQUIREMENTS.

ALL DISTANCES AND ELEVATIONS ARE IN METRES AND CAN BE CONVERTED TO FEET BY DIVIDING BY 0.3048.

BUILDER TO CONFIRM BOTTOM OF FOOTING ELEVATION AND TOP OF FOUNDATION ELEVATION PRIOR TO COMMENCEMENT OF CONSTRUCTION.

IN ACCORDANCE WITH THE ONTARIO BUILDING CODE, AT LEAST 0.15m OF FOUNDATION WALL MUST REMAIN EXPOSED.

ALL ROOF LEADERS TO BE DIRECTED TO THE ROAD.

### SETBACK REQUIREMENTS:

	REQUIRED	ACTUAL
FRONT YARD	6.0m	4.44m
INTERIOR SIDE YARD	1.2m	1.22m/1.22m
EXTERIOR SIDE YARD	6.0m	N/A
REAR YARD	7.5m	30.05m

### TOP OF FOUNDATION

T/FDN	189.60
9-1/2" ENG. JOIST	+ 0.24
3/4 PLYWOOD	+ 0.02
2x4 SILL PLATE	+ 0.04
FIN FLOOR	189.90
2 RISERS @ 0.19m	= 0.38
GARAGE ENTRY	189.52
1m @ 2%	= 0.02
GARAGE SILL	189.50

### UNDERSIDE OF FOOTING

T/FDN	189.60
FOUNDATION WALL	- 2.39
(7'-10")	
GRADE BEAM	- 1.20
(3'-11 1/2")	
CONCRETE SLAB (4")	= 0.10
UNDERSIDE FOOTING	185.91

### LOT COVERAGE:

BUILDING FOOTPRINT AREA	116.9 sq m
LOT AREA	702.7 sq m
LOT COVERAGE	16.6 %

DATE	REVISION
MAY 28/21	ISSUED TO CLIENT FOR REVIEW

LOT 9, CONCESSION 1  
IN THE GEOGRAPHIC  
TOWNSHIP OF WOODHOUSE  
LOT 8, REGISTERED PLAN 121  
TOWN OF PORT DOVER  
NORFOLK COUNTY

### SITE BENCHMARK

BM: SPIKE IN NORTH FACE OF HYDRO POLE ON NORTH WEST CORNER OF PROPERTY.

ELEVATION 189.617m

Stamp



G. DOUGLAS VALLEE LIMITED  
CONSULTING ENGINEERS, ARCHITECTS AND PLANNERS  
2 TALBOT STREET NORTH  
SIMCOE, ONTARIO N3Y 3W4  
(519) 426-6270

Project Title

**JEFF SIDWAY COTTAGE**  
**13 LAKESIDE LANE**  
**PORT DOVER - NORFOLK COUNTY**

Drawing Title

**SITE GRADING PLAN**

Home Builder :

**BOER HOMES INC.**

Designed by :  
TJC

Drawn By :  
TJC

Checked By :  
JTI

Scale :  
1:250

Date :  
MAY 11, 2021

Drawing No.

Project No.

**21-103**


**01**





**MAP B**  
**PROPOSED OFFICIAL PLAN AMENDMENT MAP**  
Urban Area of PORT DOVER

OPNPL2022278  
ZNPL2022279

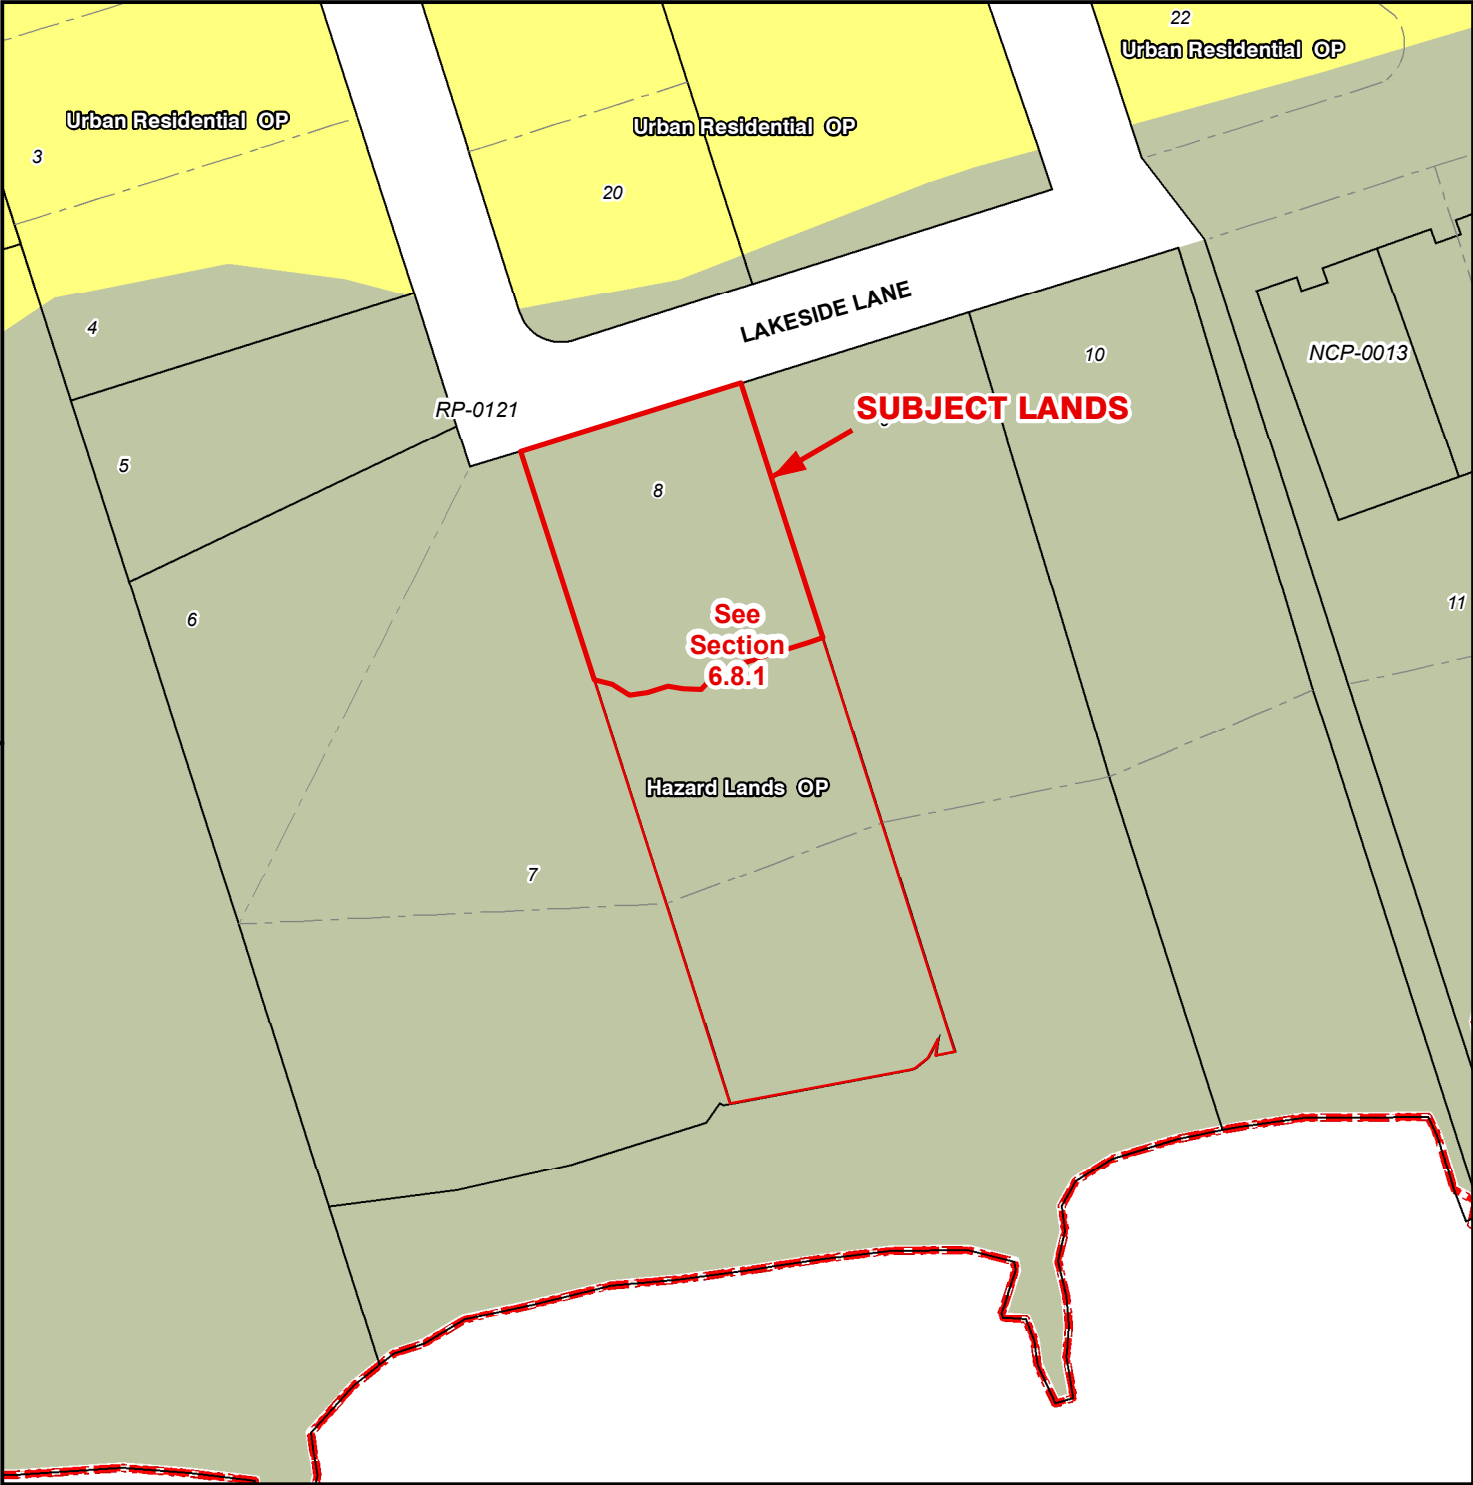

**Legend**

Subject Lands
  Lands Owned

**Official Plan Designations**

Hazard Lands
  Urban Residential

Special Policy Area
  Urban Area Boundary

**From: Hazard Land (HL)  
To: Urban Residential**

9/13/2022


# MAP C

## PROPOSED ZONING BY-LAW AMENDMENT MAP

Urban Area of PORT DOVER

OPNPL2022278

ZNPL2022279

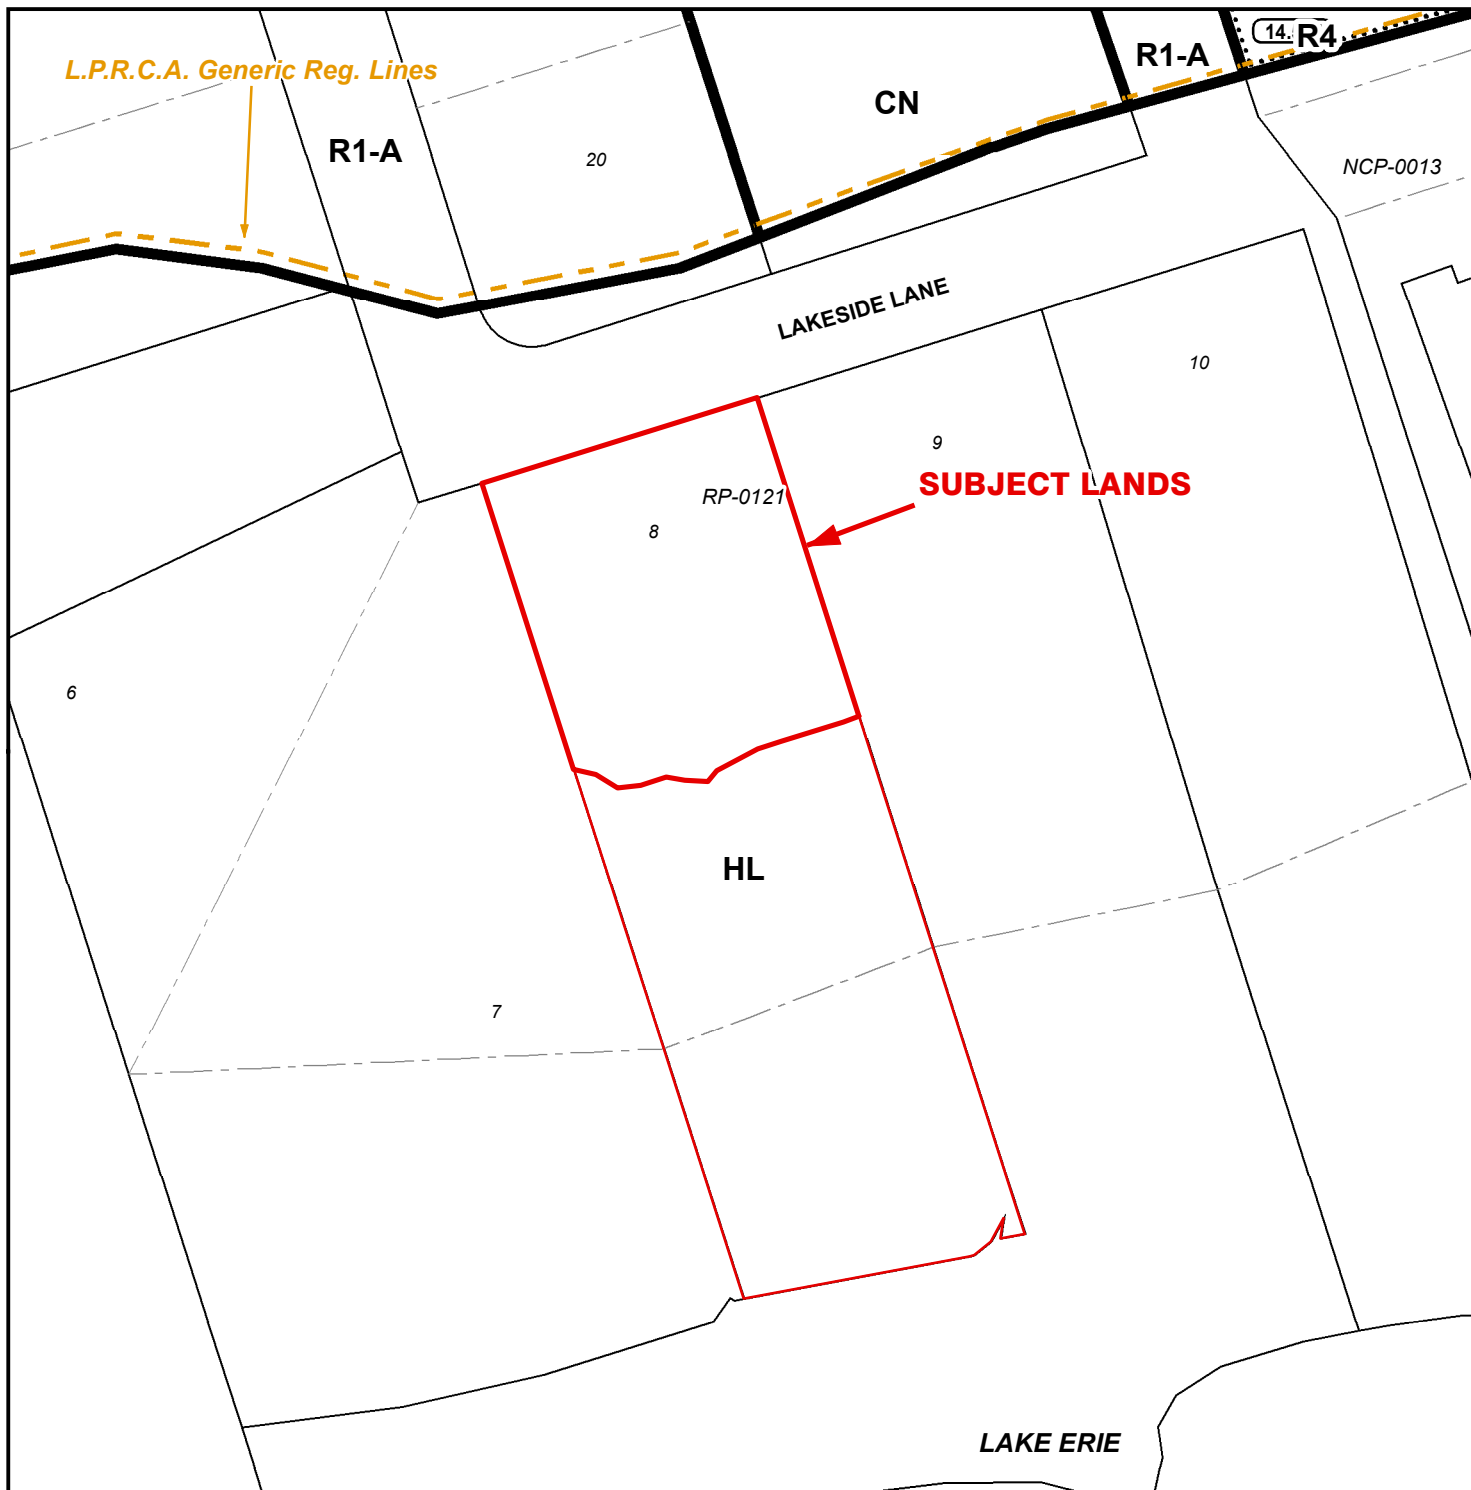

### LEGEND

- Subject Lands
- Lands Owned
- LPRCA Generic RegLines

ZONING BY-LAW 1-Z-2014

9/13/2022

(H) - Holding


CN - Neighbourhood Commercial Zone

HL - Hazard Land Zone

R1-A - Residential R1-A Zone

R4 - Residential R4 Zone


**From: Hazard Land (HL)**  
**To: Urban Residential Type 1 (R1-B)**

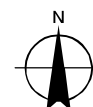



3 1.5 0 3 6 9 12 Meters


**MAP D**  
**CONCEPTUAL PLAN**  
Urban Area of PORT DOVER

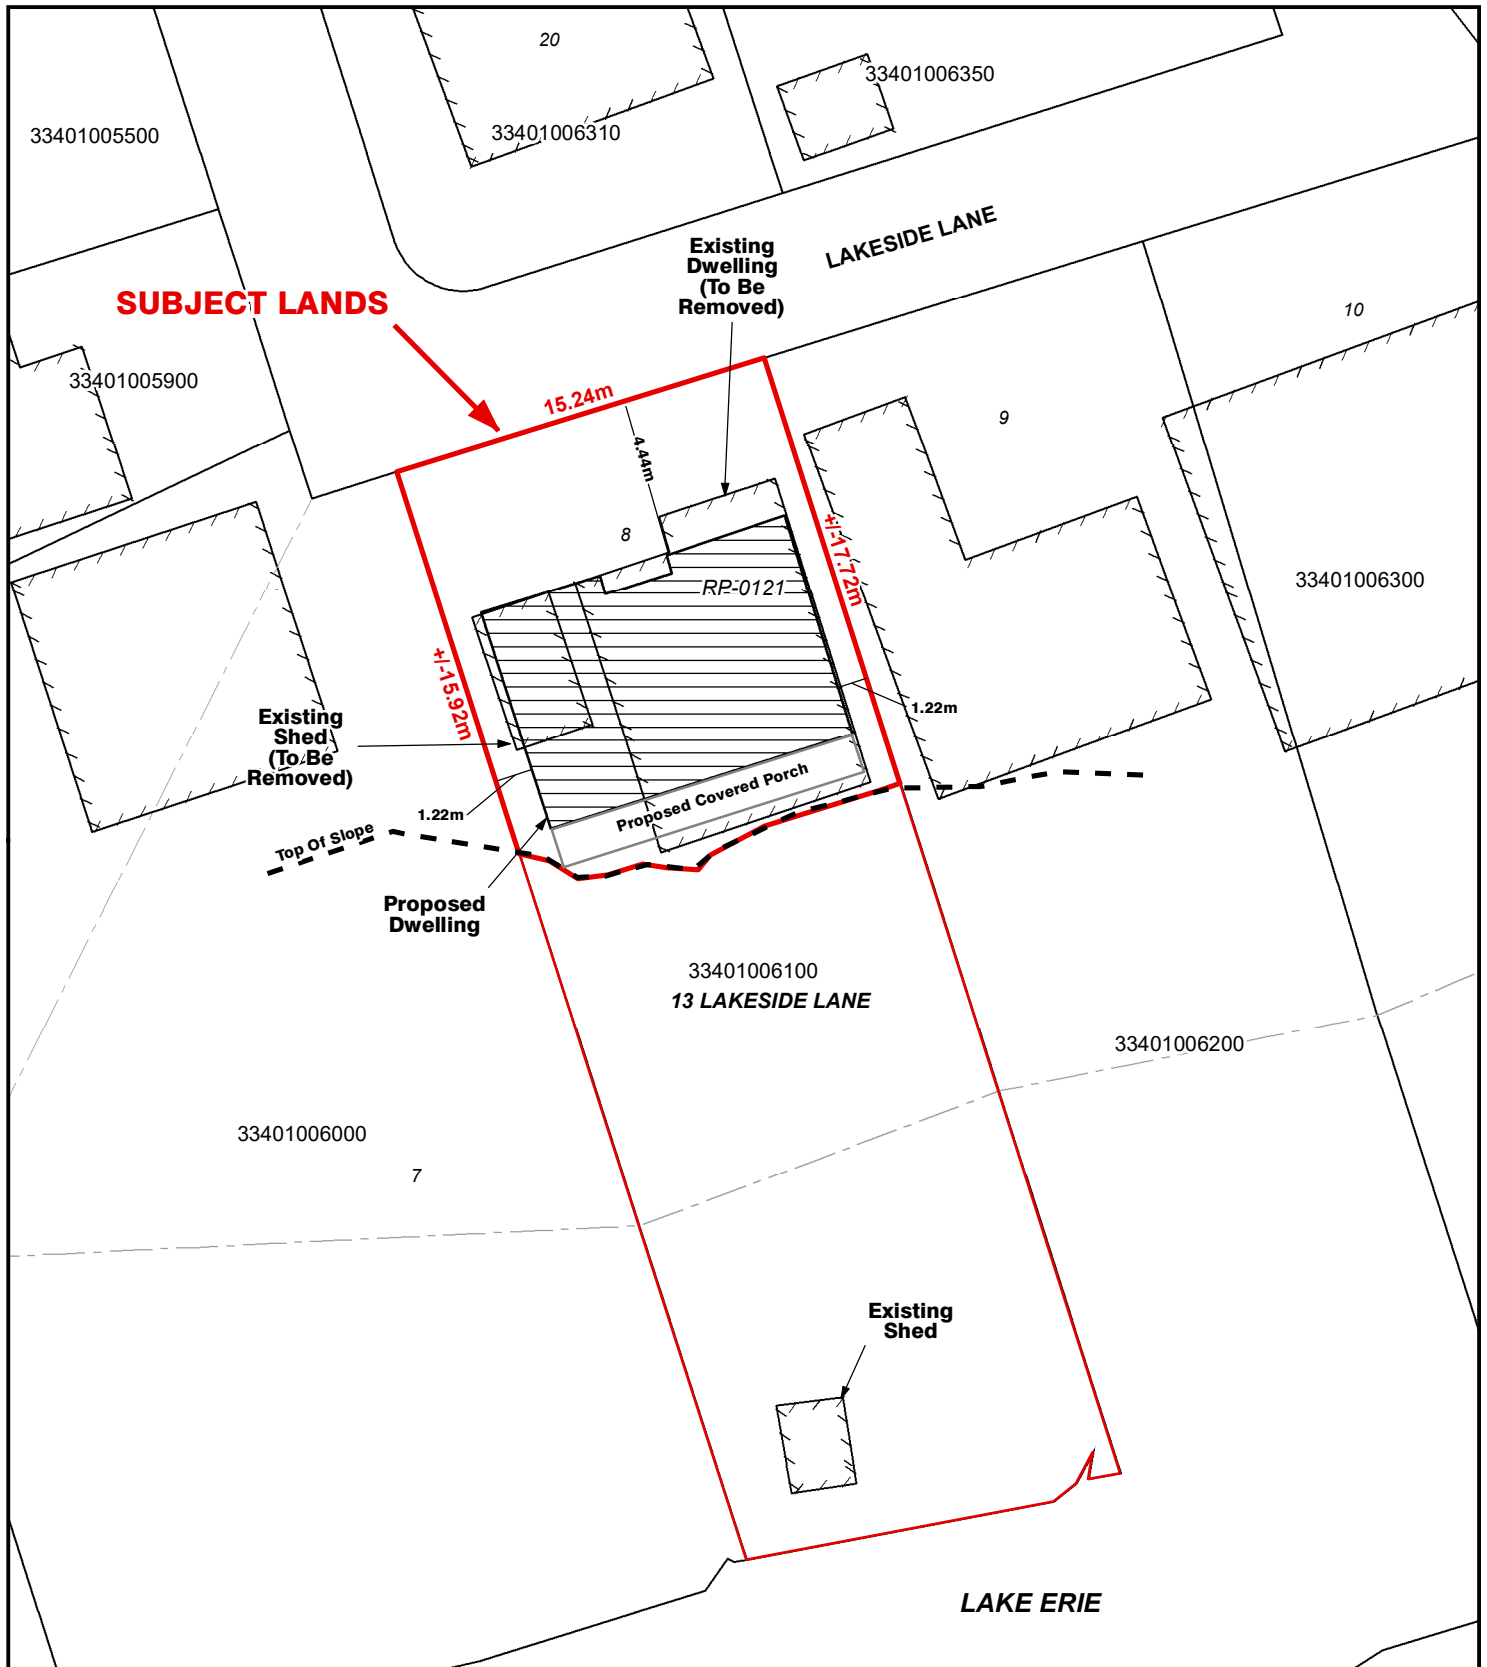OPNPL2022278  
ZNPL2022279



**Legend**

-  Subject Lands
-  Lands Owned

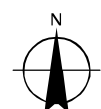

9/13/2022

2.5 1.25 0 2.5 5 7.5 10 Meters